

EXISTING SOUTH ENTRANCE

SCALE: NTS








J



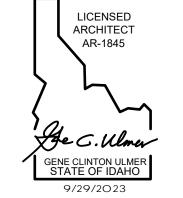

K



С

SOUTH ENTRANCE SIDEWALK TO BE


REMOVE EXISTING CONCRETE PAD. FENCE AND POLES INSTALL NEW

SIDEWALK AND LAWN

G


Ε



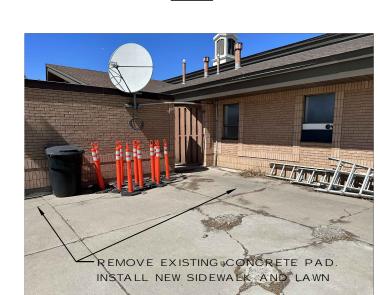





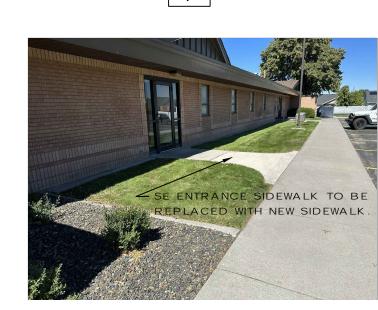

| H |

THE CHURCH OF JESUS CHRIST OF LATTER-DAY SAINTS

EMENT

 \simeq

VICINITY MAP





PROJECT INFORMATION

PROJECT OWNER:

The Church of Jesus Christ of Latter-Day Saints, A Utah Corporation Sole

Meetinghouse Project Management Office Logan King, Project Manager

50 E. North Temple Street, 12th Floor

Salt Lake City, Utah 84150-0012 Phone: (385) 228-4288

Fax: (801) 240-1494 kinglc@churchofjesuschrist.org

PROJECT DISCRIPTION:

THIS PROJECT CONSISTS OF EXISTING 28,606 SF MEETINGHOUSE AND ONE STORAGE BUILDING. WORK INCLUDES REMOVING EXISTING PARKING LOT BASE, ASPHALT, CONCRETE SIDEWALKS, CURBS, GUTTERS AND MISC. LANDSCAPE WORK. WORK ALSO INCLUDES PROVIDING LOW ENERGY

DOOR OPERATORS AT THE SOUTHEAST ENTRY OF THE BUILDING.

APPLICABLE CODES: 2018 INTERNATIONAL BUILDING CODE 2018 INTERNATIONAL MECHANICAL CODE 2018 UNIFORM PLUMBING CODE 2017 NATIONAL ELECTRICAL CODE

2018 INTERNATIONAL FIRE CODE

2018 INTERNATIONAL ENERGY CONSERVATION CODE

TYPE OF USE: TYPE III - 1 HOUR ZONE/LAND USE: C - PUBLIC/SEMIPUBLIC EXISTING OCCUPANCY: A-3 BUILDING ALARM & FIRE SUPPRESSION: NO EXITS REQUIRED: NO CHANGES.

OCCUPANCY LOAD: NO CHANGE PARCEL NUMBER: RPJ00000175810A

DRAWING INDEX

ARCHITECTURAL SHEET TITLE

A100 TITLE SHEET & PHOTOS AS101 ARCHITECTURAL SITE PLAN

CIVIL

C1.00	SITE DEMOLITION PLAN
C1.50	ESC PLAN
C1.51	ESC DETAILS
C2.OO	SITE LAYOUT PLAN
C2.50	SITE DETAILS
C2.51	SITE DETAILS
C3.OO	GENERAL NOTES

PROJECT DIRECTORY

ARCHITECT:

Gene C. Ulmer Architect 1506 S. Secretariat Way Nampa, Idaho 83686 (208) 899-0874

ulmergc@gmail.com

Contact: Gene C. Ulmer

C4.00 GRADING PLAN


CIVIL ENGINEER: The Land Group


462 E. Shore Dr., Suite 100 Eagle, Idaho 83616 (208) 939-4041 Fax (208) 939-4445 Contact: Russ Hepworth


	_		<u></u>	1)	7	7	F
•		NO	REV	ISION				DATE
		1						
		2						
		3						
		l .	OJEC MB ER		223	313	3	

PROPERTY NUMBER: 520270122020101	SHEET #
DRAWN BY:	
G.U.	
CHECKED BY:	A 10
DATE:	

SEPT. 29, 2023

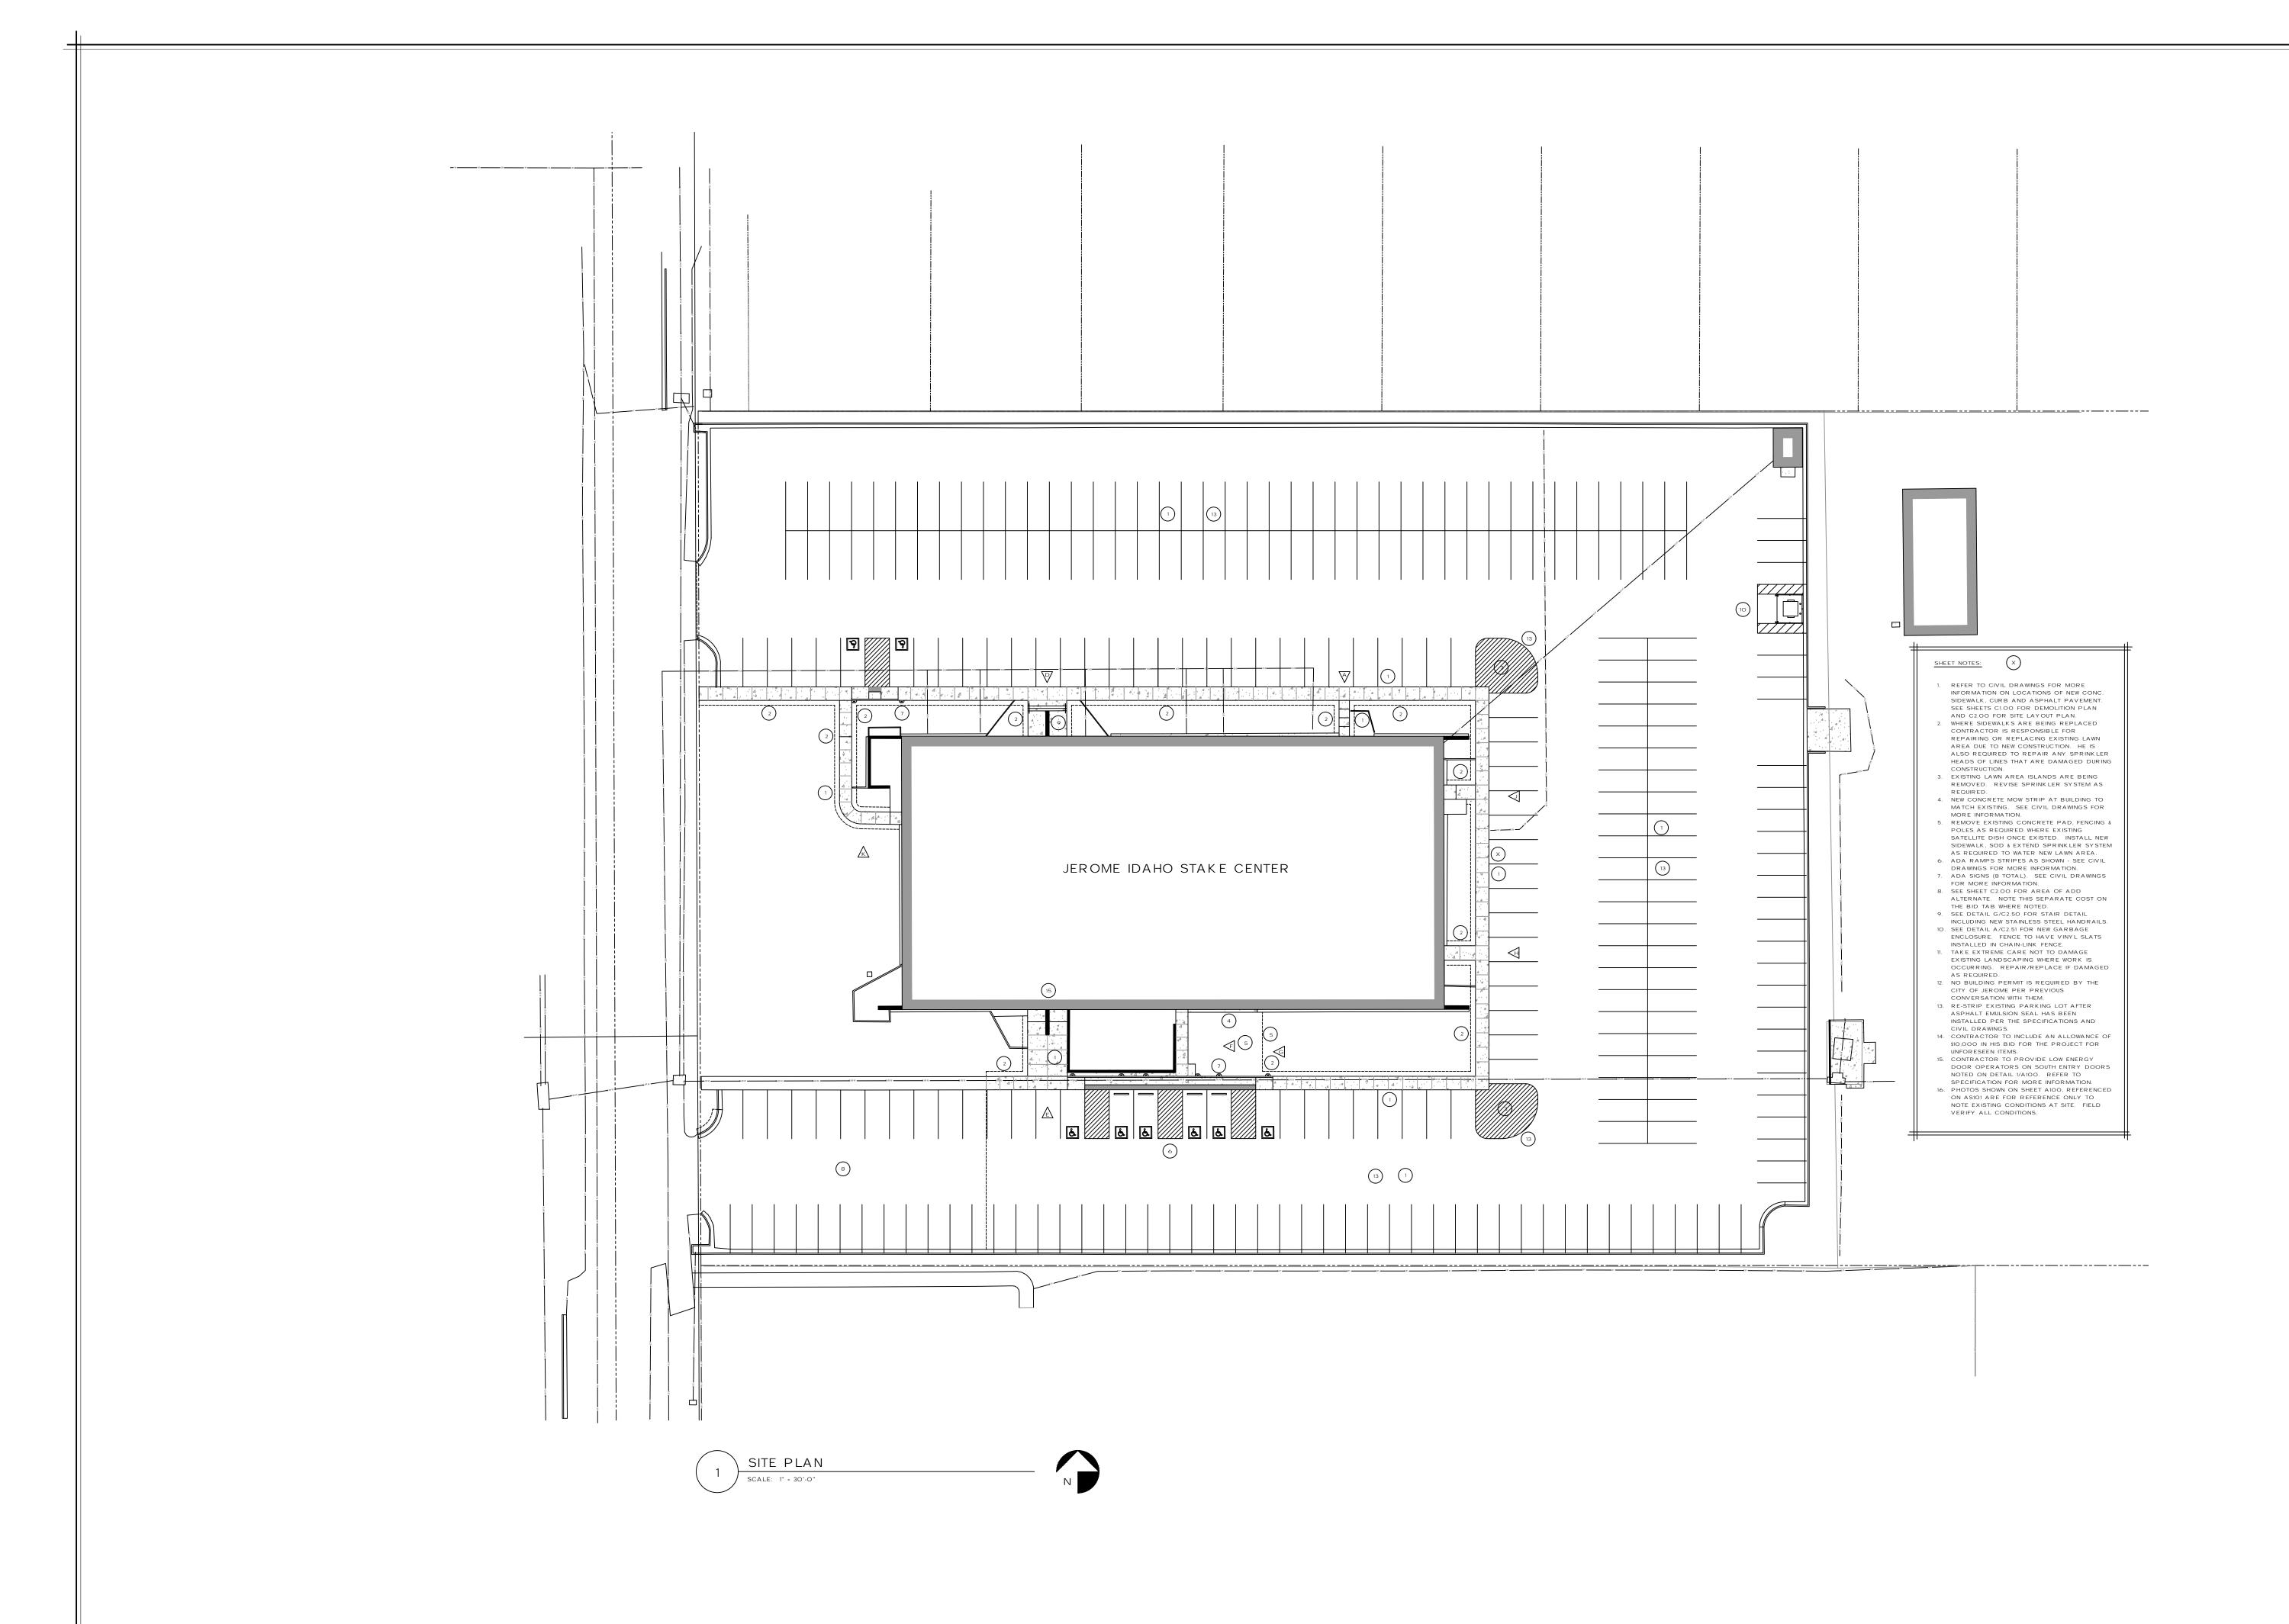

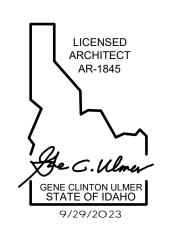

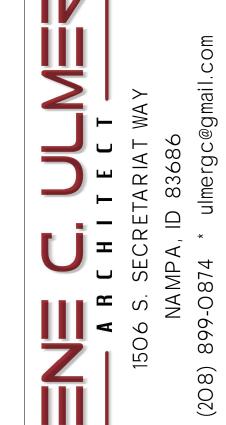

THE CHURCH OF JESUS CHRIST OF LATTER-DAY SAINTS

HH EMENT O R \bigcirc ЕР \simeq Ш Ž Y E 1, 4, 6 & - PARK E IDAHO STAKE RTH 100 EAST (5C E, IDAHO 83338

PLA


SITE


TUR,

CHITEC

JEROME JEROME 26 NORT JEROME, AR NO REVISION PROJECT 22313

520270122020101 DRAWN BY: G.U. CHECKED BY: DATE: SEPT. 29, 2023

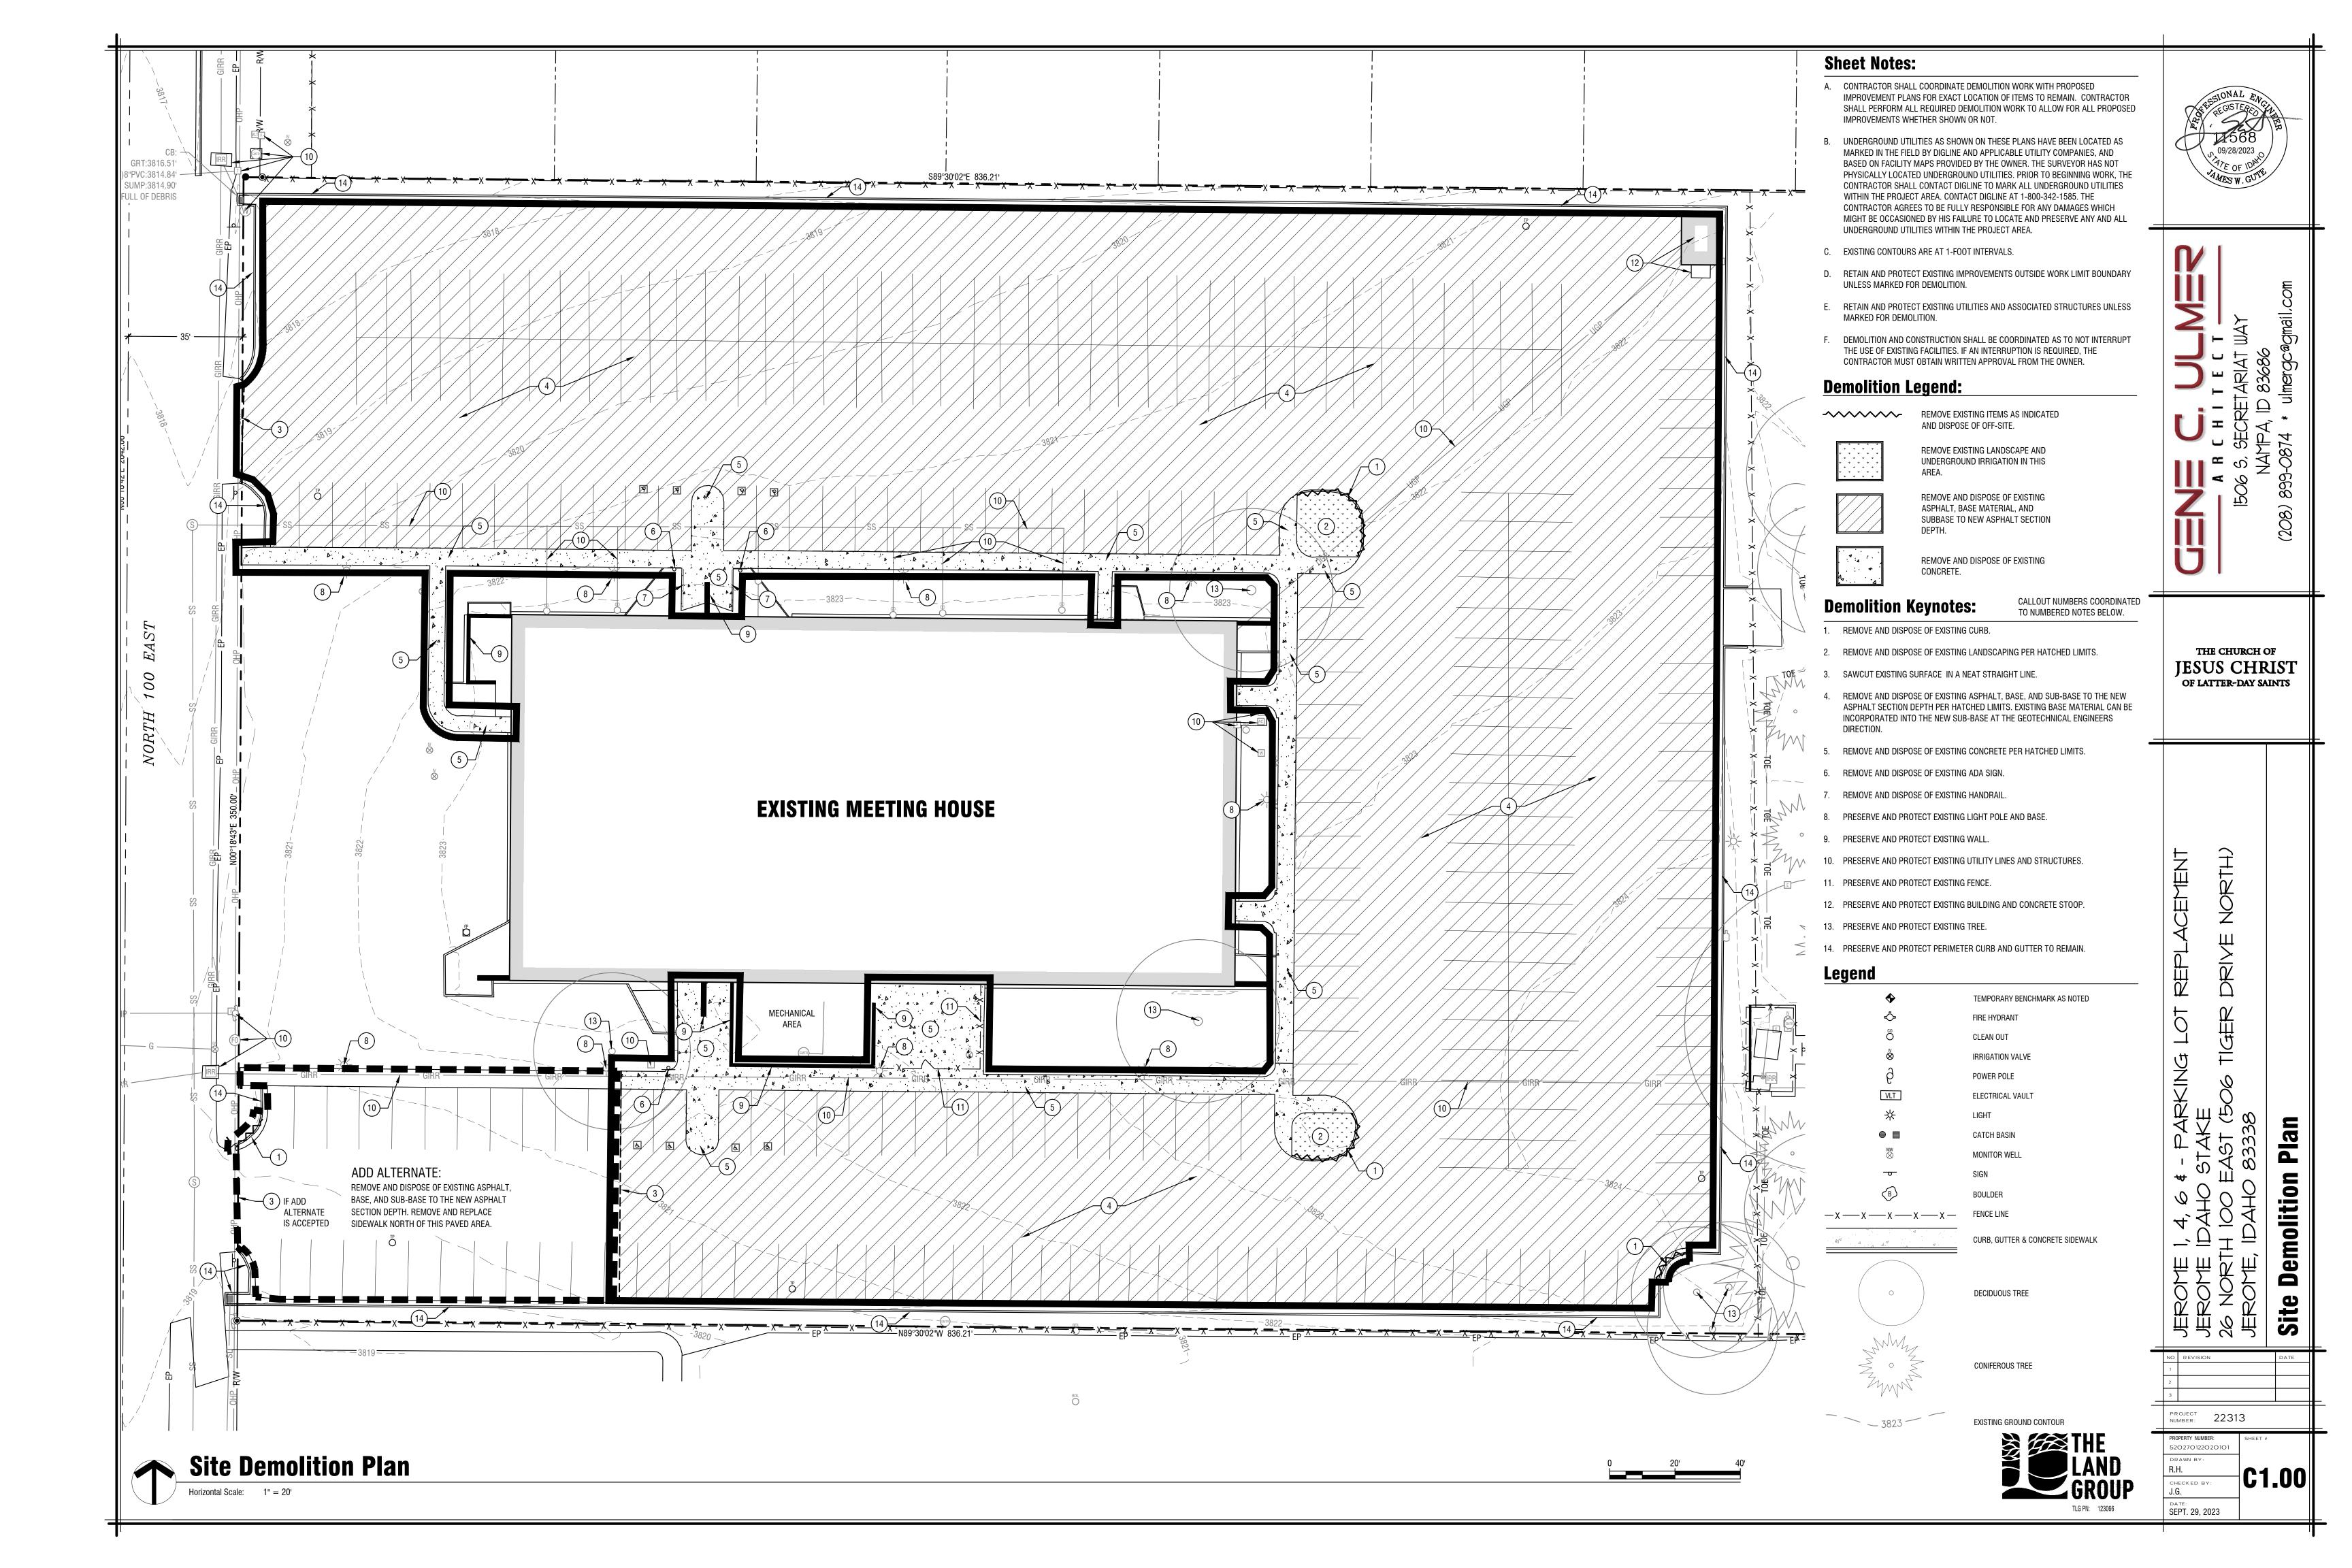

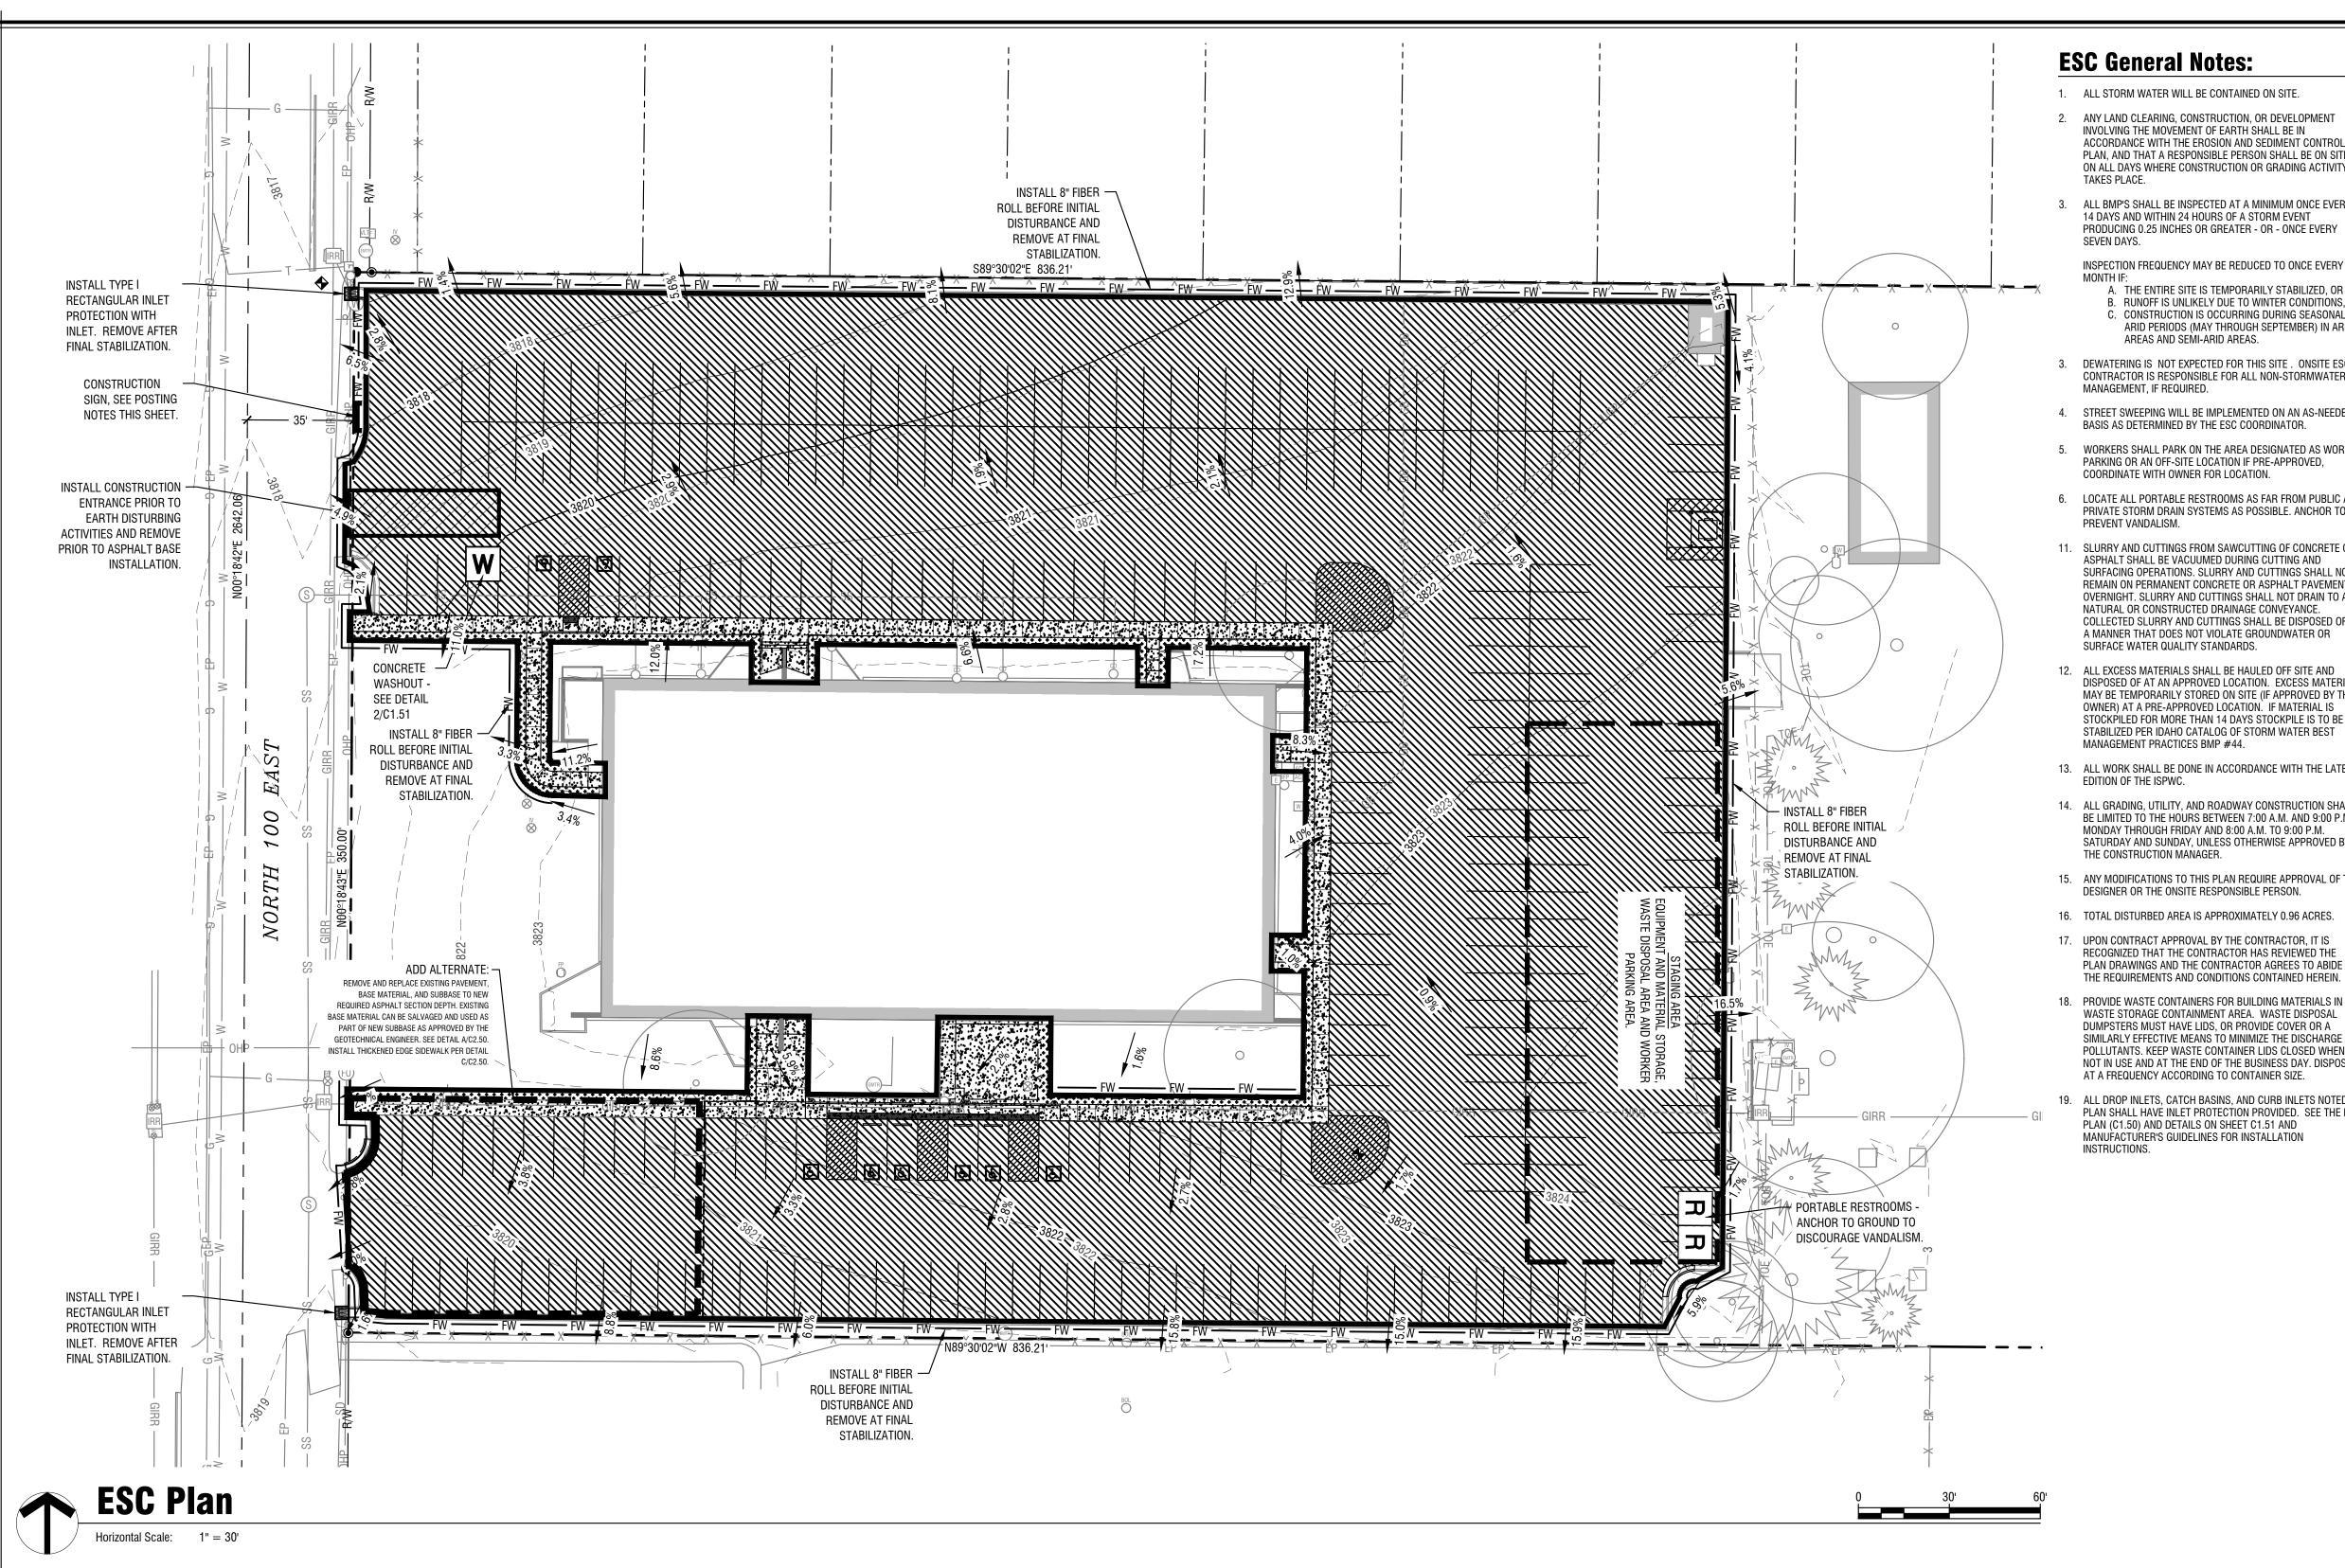

ESC General Notes:

- 1. ALL STORM WATER WILL BE CONTAINED ON SITE.
- 2. ANY LAND CLEARING, CONSTRUCTION, OR DEVELOPMENT INVOLVING THE MOVEMENT OF EARTH SHALL BE IN ACCORDANCE WITH THE EROSION AND SEDIMENT CONTROL PLAN, AND THAT A RESPONSIBLE PERSON SHALL BE ON SITE ON ALL DAYS WHERE CONSTRUCTION OR GRADING ACTIVITY
- 3. ALL BMP'S SHALL BE INSPECTED AT A MINIMUM ONCE EVERY 14 DAYS AND WITHIN 24 HOURS OF A STORM EVENT PRODUCING 0.25 INCHES OR GREATER - OR - ONCE EVERY

INSPECTION FREQUENCY MAY BE REDUCED TO ONCE EVERY

- A. THE ENTIRE SITE IS TEMPORARILY STABILIZED, OR B. RUNOFF IS UNLIKELY DUE TO WINTER CONDITIONS, OR C. CONSTRUCTION IS OCCURRING DURING SEASONAL ARID PERIODS (MAY THROUGH SEPTEMBER) IN ARID AREAS AND SEMI-ARID AREAS.
- 3. DEWATERING IS NOT EXPECTED FOR THIS SITE. ONSITE ESC CONTRACTOR IS RESPONSIBLE FOR ALL NON-STORMWATER MANAGEMENT, IF REQUIRED.
- 4. STREET SWEEPING WILL BE IMPLEMENTED ON AN AS-NEEDED BASIS AS DETERMINED BY THE ESC COORDINATOR.
- 5. WORKERS SHALL PARK ON THE AREA DESIGNATED AS WORKER PARKING OR AN OFF-SITE LOCATION IF PRE-APPROVED, COORDINATE WITH OWNER FOR LOCATION
- 6. LOCATE ALL PORTABLE RESTROOMS AS FAR FROM PUBLIC AND PRIVATE STORM DRAIN SYSTEMS AS POSSIBLE. ANCHOR TO PREVENT VANDALISM.
- 11. SLURRY AND CUTTINGS FROM SAWCUTTING OF CONCRETE OR ASPHALT SHALL BE VACUUMED DURING CUTTING AND SURFACING OPERATIONS. SLURRY AND CUTTINGS SHALL NOT REMAIN ON PERMANENT CONCRETE OR ASPHALT PAVEMENT OVERNIGHT. SLURRY AND CUTTINGS SHALL NOT DRAIN TO ANY NATURAL OR CONSTRUCTED DRAINAGE CONVEYANCE. COLLECTED SLURRY AND CUTTINGS SHALL BE DISPOSED OF IN A MANNER THAT DOES NOT VIOLATE GROUNDWATER OR
- 12. ALL EXCESS MATERIALS SHALL BE HAULED OFF SITE AND DISPOSED OF AT AN APPROVED LOCATION EXCESS MATERIAL MAY BE TEMPORARII Y STORED ON SITE (IF APPROVED BY THE OWNER) AT A PRE-APPROVED LOCATION. IF MATERIAL IS STOCKPILED FOR MORE THAN 14 DAYS STOCKPILE IS TO BE STABILIZED PER IDAHO CATALOG OF STORM WATER BEST
- 13. ALL WORK SHALL BE DONE IN ACCORDANCE WITH THE LATEST EDITION OF THE ISPWC.
- 14. ALL GRADING, UTILITY, AND ROADWAY CONSTRUCTION SHALL BE LIMITED TO THE HOURS BETWEEN 7:00 A.M. AND 9:00 P.M. MONDAY THROUGH FRIDAY AND 8:00 A.M. TO 9:00 P.M. SATURDAY AND SUNDAY, UNLESS OTHERWISE APPROVED BY THE CONSTRUCTION MANAGER.
- 17. UPON CONTRACT APPROVAL BY THE CONTRACTOR, IT IS RECOGNIZED THAT THE CONTRACTOR HAS REVIEWED THE PLAN DRAWINGS AND THE CONTRACTOR AGREES TO ABIDE BY
- PLAN SHALL HAVE INLET PROTECTION PROVIDED. SEE THE ESC PLAN (C1.50) AND DETAILS ON SHEET C1.51 AND MANUFACTURER'S GUIDELINES FOR INSTALLATION

Contact Information:

OWNER/DEVELOPER: THE CHURCH OF JESUS CHRIST OF LATTER-DAY

50 E NORTH TEMPLE STREET FLOOR 4WW SALT LAKE CITY, UT 84150 PRIMARY CONTACT: ALLAN CHRISTEAN PH.: 208.557.9079

CONTRACTOR: TO BE DETERMINED BY BID

PRIMARY CONTACT:

PHONE:

ONSITE ESC COORDINATOR: TBD CONTACT: PHONE (CELL):

PLAN PREPARER: THE LAND GROUP, INC. 462 E. SHORE DR., STE. 100

EAGLE, IDAHO 83616 PRIMARY CONTACT: ALISON LARK PHONE: 208-939-4041

PROJECT ENGINEER: THE LAND GROUP, INC. 462 E. SHORE DR., STE. 100 EAGLE, IDAHO 83616 PRIMARY CONTACT: JAMES GUTE, PE

PHONE: 208.939.4041

SURFACE WATER QUALITY STANDARDS.

- MANAGEMENT PRACTICES BMP #44.
- 15. ANY MODIFICATIONS TO THIS PLAN REQUIRE APPROVAL OF THE DESIGNER OR THE ONSITE RESPONSIBLE PERSON.
- 16. TOTAL DISTURBED AREA IS APPROXIMATELY 0.96 ACRES.
- 18. PROVIDE WASTE CONTAINERS FOR BUILDING MATERIALS IN WASTE STORAGE CONTAINMENT AREA. WASTE DISPOSAL DUMPSTERS MUST HAVE LIDS, OR PROVIDE COVER OR A SIMILARLY EFFECTIVE MEANS TO MINIMIZE THE DISCHARGE OF POLLUTANTS. KEEP WASTE CONTAINER LIDS CLOSED WHEN NOT IN USE AND AT THE END OF THE BUSINESS DAY. DISPOSE AT A FREQUENCY ACCORDING TO CONTAINER SIZE.
- 19. ALL DROP INLETS, CATCH BASINS, AND CURB INLETS NOTED ON

APPROXIMATE LIMIT OF DISTURBANCE PROPOSED GROUND CONTOUR (ONE-FOOT

> APPROXIMATE EXISTING GROUND CONTOUR (ONE-FOOT INTERVAL) WITH DIRECTIONAL SLOPE ARROWS

> > PORTABLE RESTROOM PER THE STATE OF IDAHO CATALOG OF STORM WATER BEST MANAGEMENT PRACTICES BMP #50.

INTERVAL) WITH DIRECTIONAL SLOPE ARROWS

CONCRETE WASHOUT PER THE STATE OF IDAHO CATALOG OF STORM WATER BEST MANAGEMENT PRACTICES BMP #49. SEE SHEET C1.51 FOR DETAILS.

THE CHURCH OF

JESUS CHRIST

OF LATTER-DAY SAINTS

MATERIALS STORAGE, STAGING, AND PARKING AREAS PER THE STATE OF IDAHO CATALOG OF STORM WATER BEST MANAGEMENT PRACTICES PROVIDE STABILIZED ENTRANCE PER THE STATE

OF IDAHO CATALOG OF STORM WATER BEST MANAGEMENT PRACTICES BMP #40. THIS SHALL BE MAINTAINED THROUGHOUT CONSTRUCTION UNTIL MATERIAL IS INSTALLED. PROVIDE SWEEPING DAILY OR AS NEEDED TO REMOVE ANY TRACKING OF MUD AND/OR DIRT ONTO EXISTING ASPHALT. SEE SHEET C1.51 FOR DETAILS.

FIBER ROLL PER STATE OF IDAHO CATALOG OF STORM WATER BEST MANAGEMENT PRACTICES BMP #64. SEE DETAILS ON SHEET C1.51.

ASPHALT STABILIZATION AREAS, COORDINATE WITH MATERIALS SHEETS. LANDSCAPE STABILIZATION AREAS PER THE

STATE OF IDAHO CATALOG OF STORM WATER BEST MANAGEMENT PRACTICES BMP #32, COORDINATE WITH LANDSCAPE SHEETS.

DROP INLET PROTECTION TYPE I PER BMP #13,

CONCRETE STABILIZATION AREAS, COORDINATE WITH MATERIALS SHEETS.

SEE SHEET C1.51 FOR DETAILS.

Soil Stabilization:

- 1. IF SEDIMENT ESCAPES THE CONSTRUCTION SITE, OFF-SITE ACCUMULATIONS OF SEDIMENT MUST BE REMOVED AT A FREQUENCY
- SUFFICIENT TO MINIMIZE OFF-SITE IMPACTS. 2. LITTER, CONSTRUCTION DEBRIS, AND CONSTRUCTION CHEMICALS THAT COULD BE EXPOSED TO STORM WATER MUST BE PREVENTED
- FROM BECOMING A POLLUTANT SOURCE IN STORM WATER DISCHARGES. 3. EXCEPT AS PROVIDED BELOW, STABILIZATION MEASURES MUST BE INITIATED AS SOON AS PRACTICAL IN PORTIONS OF THE SITE WHERE CONSTRUCTION ACTIVITIES HAVE TEMPORARILY OR PERMANENTLY CEASED, BUT IN NO CASE MORE THAT 14 DAYS AFTER THE
- CONSTRUCTION ACTIVITY IN THAT PORTION OF THE SITE HAS TEMPORARILY OR PERMANENTLY CEASED. 3.1. WHERE STABILIZATION BY THE 14th DAY IS PRECLUDED BY SNOW COVER OR FROZEN GROUND CONDITIONS, STABILIZATION
- MEASURES MUST BE INITIATED AS SOON AS PRACTICAL WHERE CONSTRUCTION ACTIVITY ON A PORTION OF THE SITE IS TEMPORARILY CEASED, AND EARTH DISTURBING ACTIVITIES WILL BE RESUMED WITHIN 14 DAYS. TEMPORARY STABILIZATION MEASURES DO NOT HAVE TO BE INITIATED ON THAT PORTION OF THE SITE.

NOTE: ONE OF THE FOLLOWING TEMPORARY SOIL STABILIZATION PRACTICES SHALL BE IMPLEMENTED ON ALL DISTURBED AREAS AND/OR WHERE SHOWN ON PLAN, UNLESS CONDITIONS AS LISTED ABOVE DICTATE OTHERWISE:

- 1. MULCHING (BMP 52) APPLY GRAVEL, STRAW, GRASS, COMPOST, WOOD CHIPS OR WOOD FIBERS TO DISTURBED AREAS TO PREVENT EROSION. SEE APPENDIX F OF THE ESC/SWPPP NARRATIVE FOR A COMPLETE DESCRIPTION, **AND/OR**:
- GEOTEXTILE (BMP 53) APPLY NONBIODEGRADABLE SYNTHETIC FABRIC TO DISTURBED AREAS TO PREVENT EROSION. SEE APPENDIX F OF THE ESC/SWPPP NARRATIVE FOR A COMPLETE DESCRIPTION, AND/OR: 3. MATTING (BMP 54) - APPLY BIODEGRADABLE WOVEN OR JUTE FIBER MAT TO DISTURBED AREAS TO PREVENT EROSION. SEE APPENDIX F

PERMANENT SOIL STABILIZATION BMPS:

OF THE ESC/SWPPP NARRATIVE FOR A COMPLETE DESCRIPTION.

SEEDING (BMP 32), SODDING (BMP 32), AND PLANTING (BMP 32) - COORDINATE WITH THE APPROVED LANDSCAPE PLAN FOR LOCATIONS AND

L.E.W. Posting Requirements:

- 1. THE OPERATORS (CONTRACTOR AND OWNER/DEVELOPER) ARE RESPONSIBLE FOR APPLYING FOR OBTAINING THE EPA LOW EROSIVITY WAIVER (LEW) FROM THE EPA eNOI WEBSITE.
- 2. A COMPLETE COPY OF THE LEW AND THE EROSION & SEDIMENT CONTROL (ESC) PLAN SHALL BE HELD ON SITE AND MADE AVAILABLE FOR REVIEW BY EPA, STATE, COUNTY, OR CITY OFFICIALS.
- **ESC Posting Requirements:**

ALL CONSTRUCTION PROJECTS WHICH HOLD AN EROSION CONTROL PERMIT SHALL DISPLAY A SIGN AT THE MAIN ENTRANCE OF THE

- PROPERTY INDICATING THE FOLLOWING: ADDRESS OF THE PROPERTY, IF ONE HAS BEEN ASSIGNED, OR A LOT OR BLOCK NUMBER,
- THE ESC PERMIT NUMBER, THE EPA PERMIT NUMBER (IF APPLICABLE),
- THE RESPONSIBLE PERSON'S NAME AND PHONE NUMBER, 4. THE STORMWATER POLLUTION HOTLINE PHONE NUMBER

ALL REQUIRED WRITING ON THE SIGNS SHALL BE LEGIBLE AND OF SUFFICIENT SIZE TO BE EASILY READ FROM THE STREET. ESC AND ANY WAIVER DOCUMENTS MUST BE MADE AVAILABLE UPON REQUEST BY EPA, A STATE, TRIBAL, OR OTHER LOCAL APPROVING Note: This project meets the requirements for a Low Erosivity Waiver for Small

Disturbed Area is less than 5.0 ac The Erosivity Index is 2.01 which is below the threshold of 5.0

The above is based on a start date of If the construction time increases, a new

Construction Projects:

05.01.2024 and an end date of 08.31.2024. calculation will need to be completed.






UMBER: 22313

SEPT. 29, 2023

C1.50

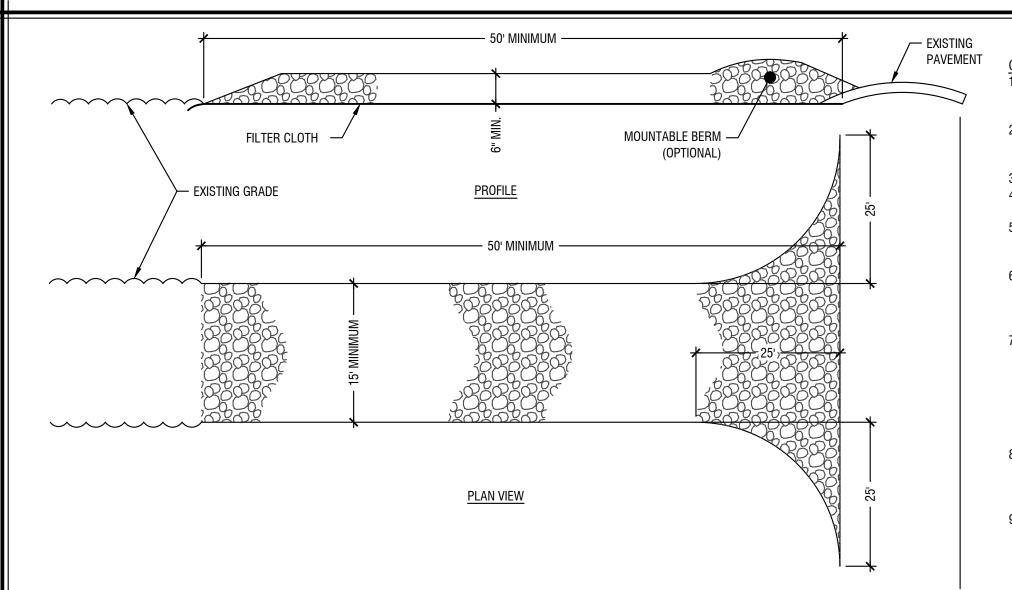

WOOD STAKE -

FIBER WATTLE —

STONE SIZE-USE CRUSHED 2" STONE OR RECLAIMED OR RECYCLED CONCRETE EQUIVALENT FOR TOP LAYER, 2"-8" DIAMETER FOR BASE

2. LENGTH-AS REQUIRED, BUT NOT LESS THAN 50 FEET (EXCEPT ON A SINGLE RESIDENCE LOT WHERE A 30 FOOT MINIMUM LENGTH WOULD

3. THICKNESS-NOT LESS THAN 6 INCHES.

4. WIDTH-10 FOOT MINIMUM, BUT NOT LESS THAN THE FULL WIDTH AT POINTS WHERE INGRESS OR EGRESS OCCURS. 5. FILTER CLOTH-WILL BE PLACED OVER THE ENTIRE AREA PRIOR TO PLACING OF STONE. FILTER WILL NOT BE REQUIRED ON A SINGLE


6. ALL SURFACE WATER FLOWING OR DIVERTED TOWARD CONSTRUCTION ENTRANCES SHALL BE PIPED ACROSS THE ENTRANCE. IF PIPING IS IMPRACTICAL, A MOUNTABLE BERM WITH 5:1 SLOPES WILL BE

7. MAINTENANCE-THE ENTRANCE SHALL BE MAINTAINED IN A CONDITION WHICH WILL PREVENT TRACKING OR FLOWING OF SEDIMENT ONTO PUBLIC RIGHT-OF-WAY. THIS MAY REQUIRE PERIODIC TOP DRESSING WITH ADDITIONAL STONE AS CONDITIONS DEMAND AND REPAIR AND/OR CLEANOUT OF ANY MEASURES USED TO TRAP SEDIMENT. ALL SEDIMENT SPILLED, DROPPED, WASHED OR TRACKED ONTO PUBLIC RIGHT-OF-WAY MUST BE REMOVED IMMEDIATELY.

8. WASHING-WHEELS SHALL BE CLEANED TO REMOVE SEDIMENT PRIOR TO ENTRANCE ONTO PUBLIC RIGHT-OF-WAY. WHEN WASHING IS REQUIRED, IT SHALL BE DONE ON AN AREA STABILIZED WITH STONE

AND WHICH DRAINS INTO AN APPROVED SEDIMENT TRAPPING DEVICE. 9. PERIODIC INSPECTION AND NEEDED MAINTENANCE SHALL BE PROVIDED AFTER EACH RAIN.


— SLOPE SURFACE

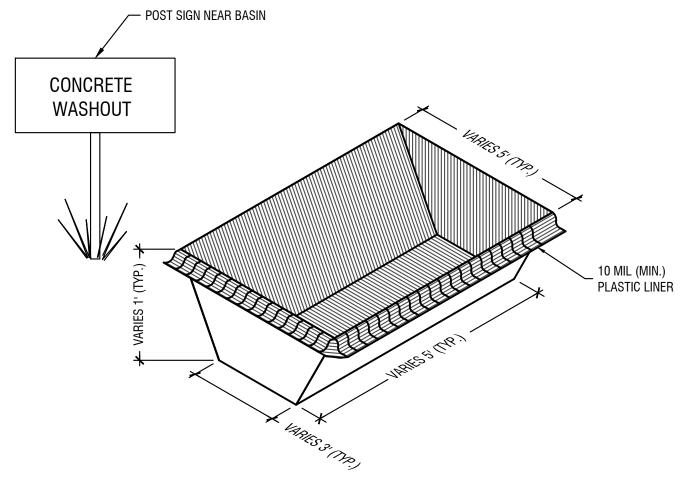


NOTES

1. DIMENSIONS VARY. RESPONSIBLE PERSON SHALL SIZE BASIN APPROPRIATELY.

SERVICES / 2. SELF CONTAINED MOBILE WASHOUTS WITH DELIVERY AND REMOVAL SERVICES ARE ACCEPTABLE.

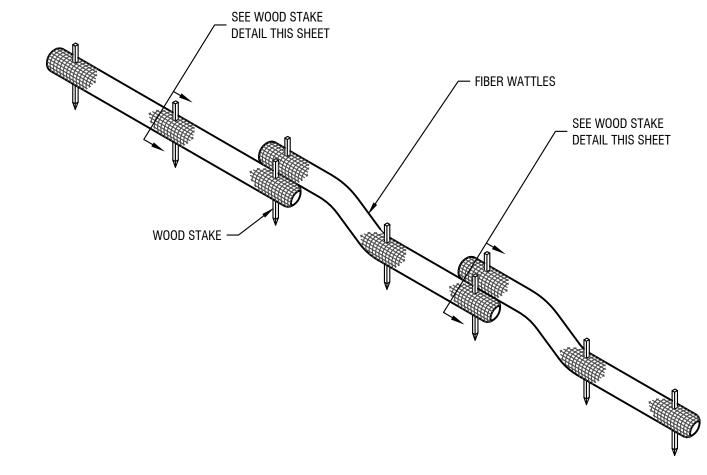

Concrete Washout (BMP 49)

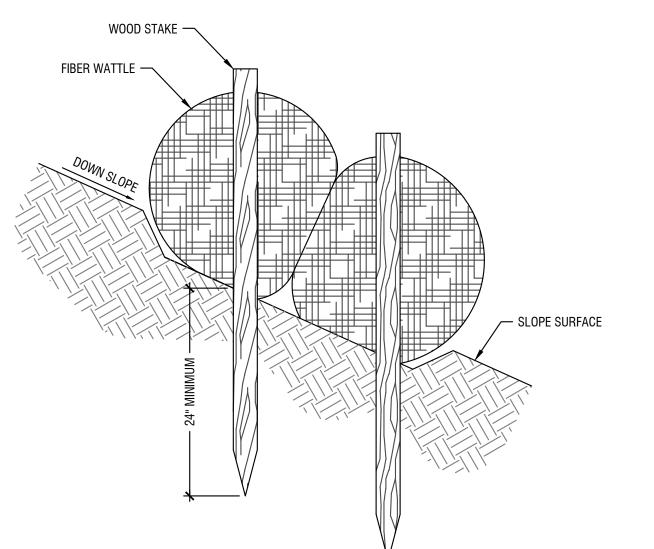

√ Fiber Roll Stake Section 2 (BMP 64)


Fiber Roll (BMP 64)


FASTNER - MINIMUM NO. 10 GAGE WIRE (4 PER POST REQ'D) FILTER FABRIC - EXISTING GROUND - COMPACTED NATIVE MATERIAL

FABRIC ANCHOR DETAIL TEMPORARY SEDIMENT FENCE SHALL BE INSTALLED PRIOR TO ANY GRADING WORK IN THE AREA TO BE PROTECTED. THEY SHALL BE MAINTAINED THROUGHOUT THE CONSTRUCTION PERIOD AND REMOVED IN CONJUNCTION WITH THE

- 3. FENCE POSTS SHALL BE EITHER STANDARD STEEL POST OR WOOD POST WITH A MINIMUM CROSS-SECTIONAL AREA OF

Silt Fence Install 1 (BMP 65)

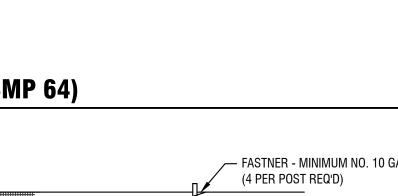

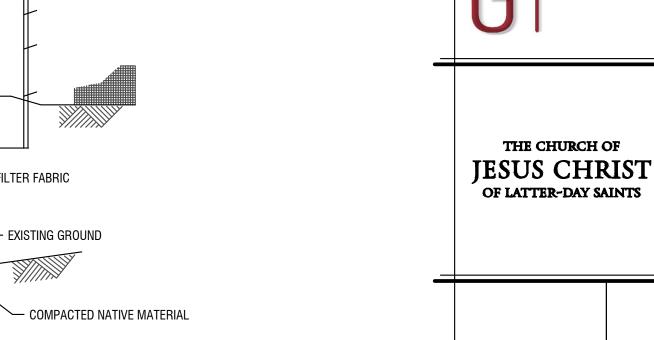




THE CHURCH OF

OF LATTER-DAY SAINTS

PROJECT 22313 DRAWN BY:
R.H.
CHECKED BY:
J.G.

SEPT. 29, 2023

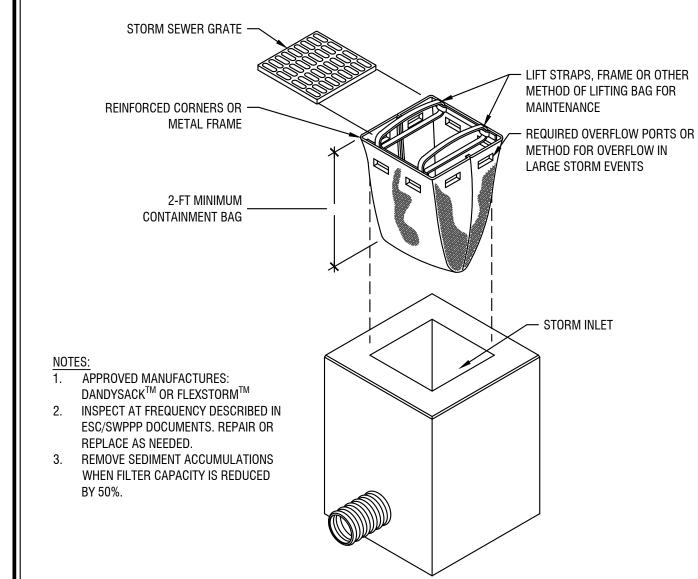



Drop Inlet Protection Type I (BMP 13)

Stabilized Construction Entrance (BMP 40)

Fiber Roll Stake Section (BMP 64)



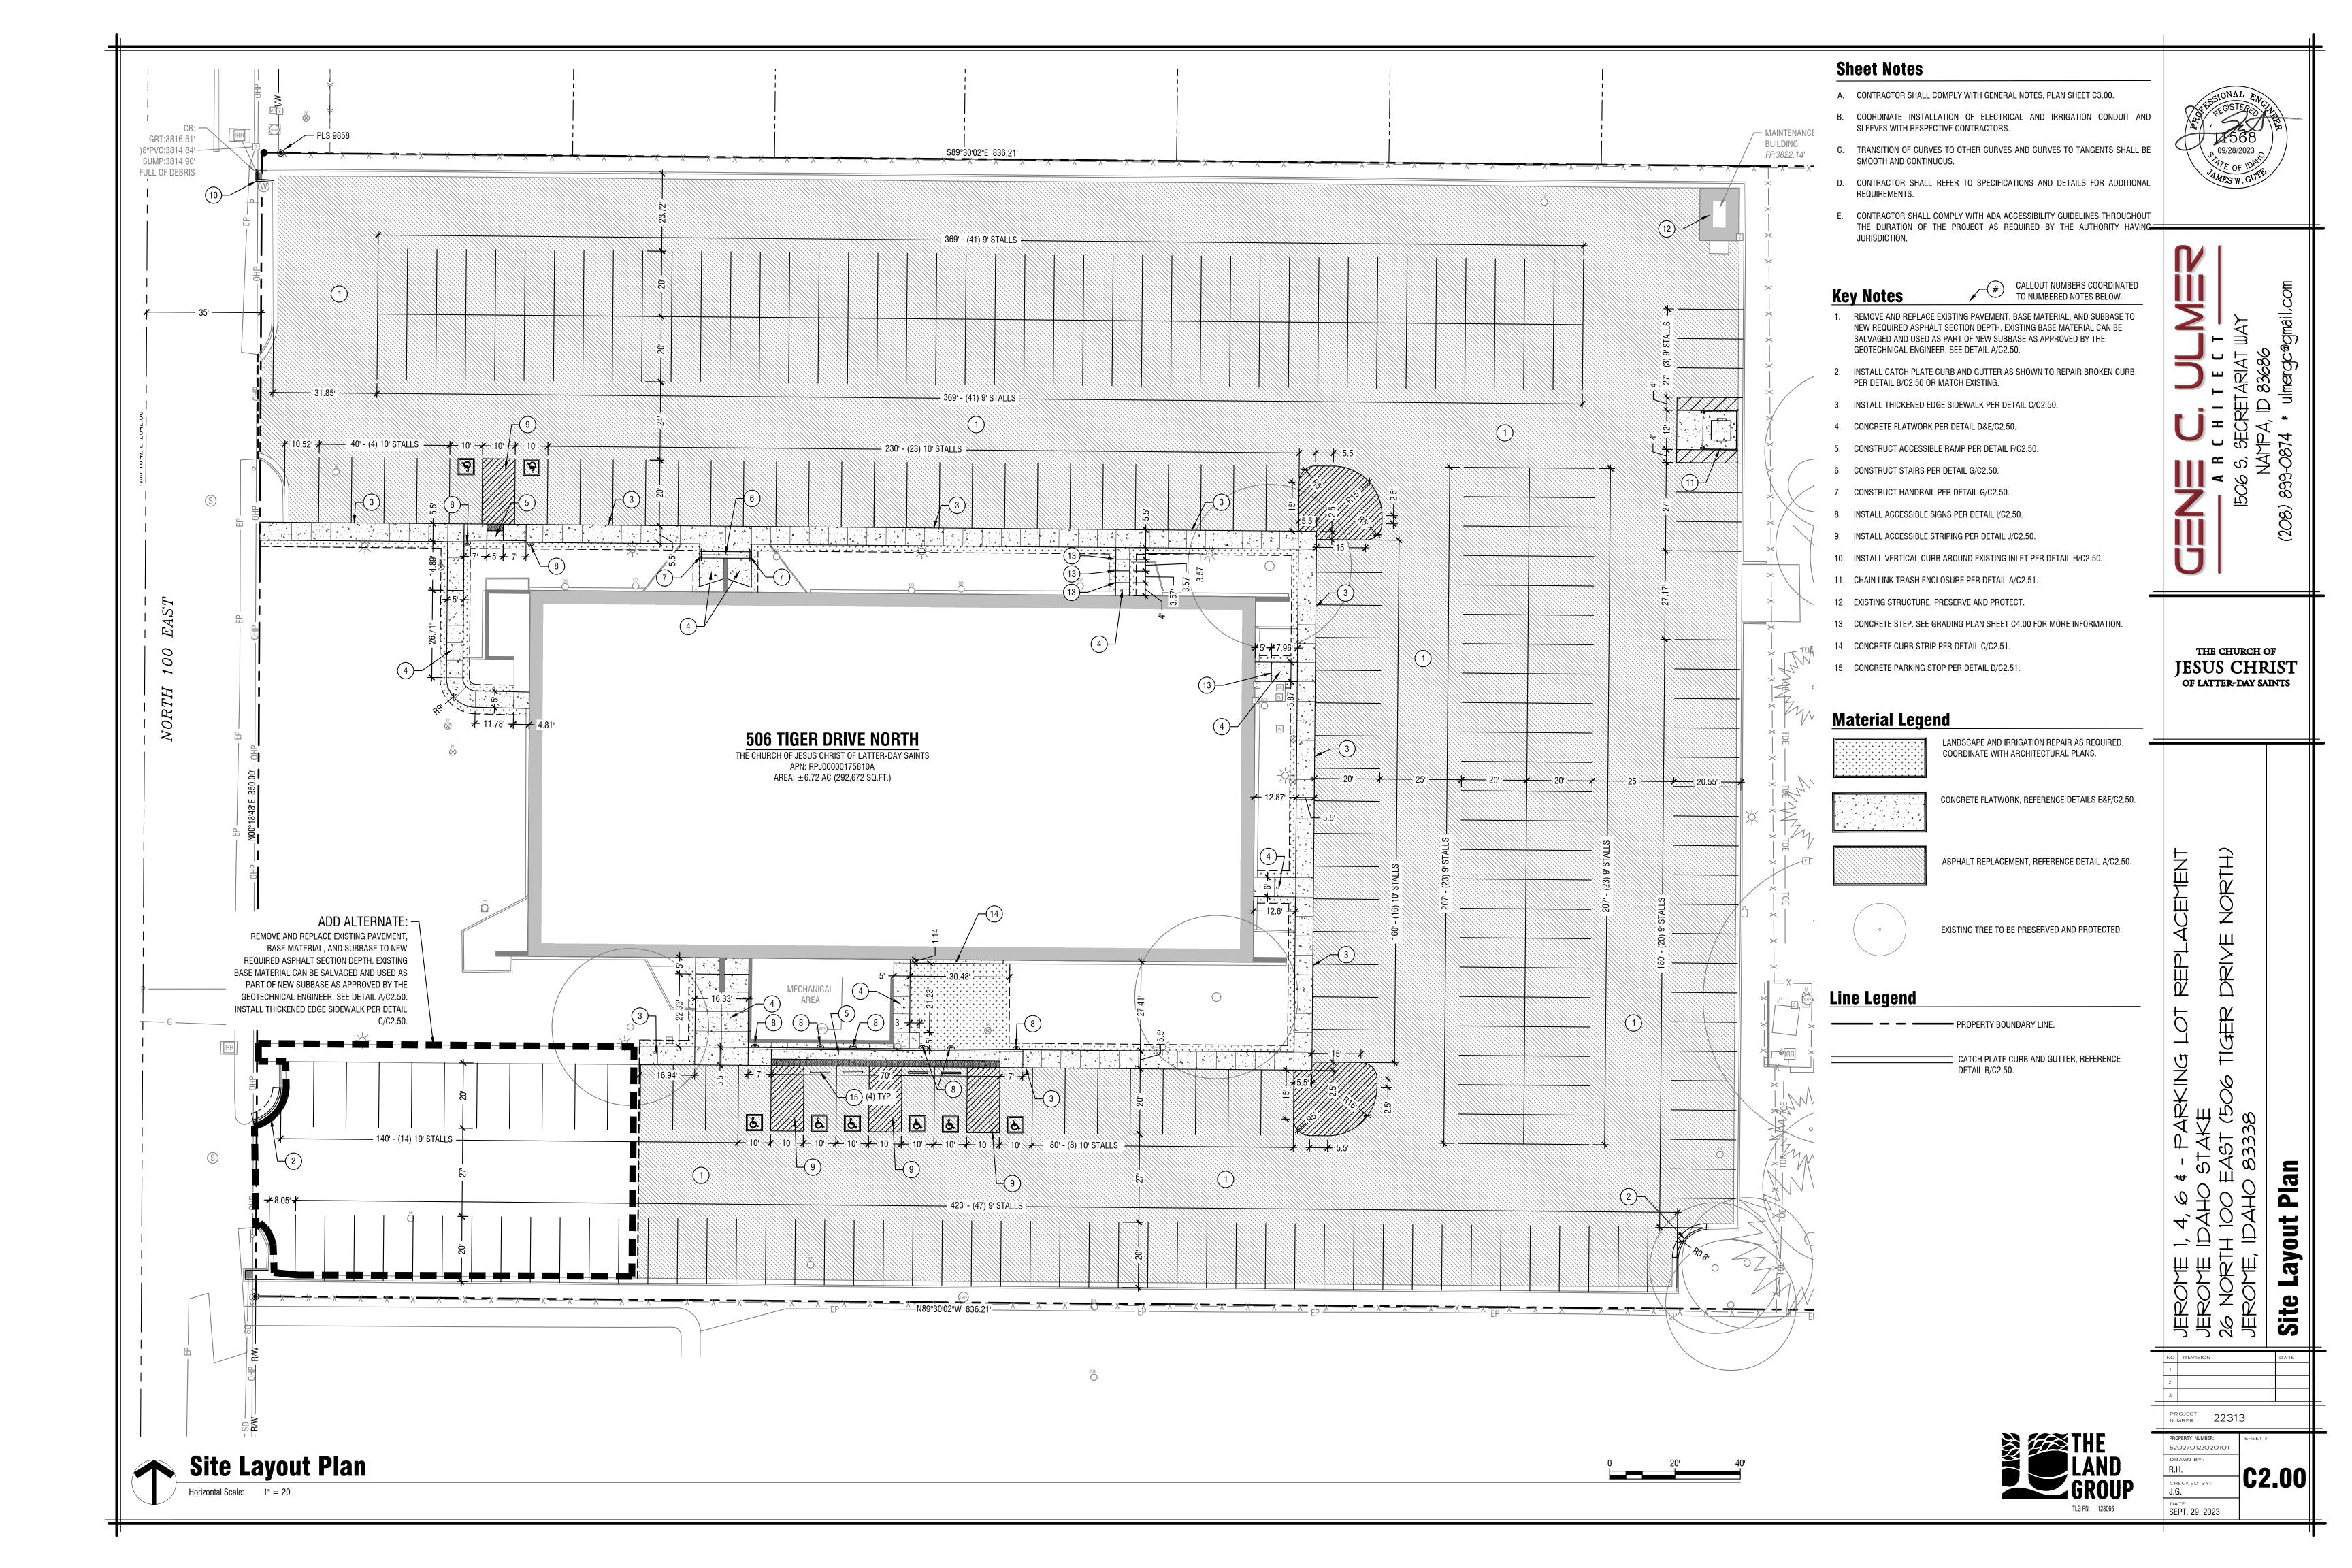

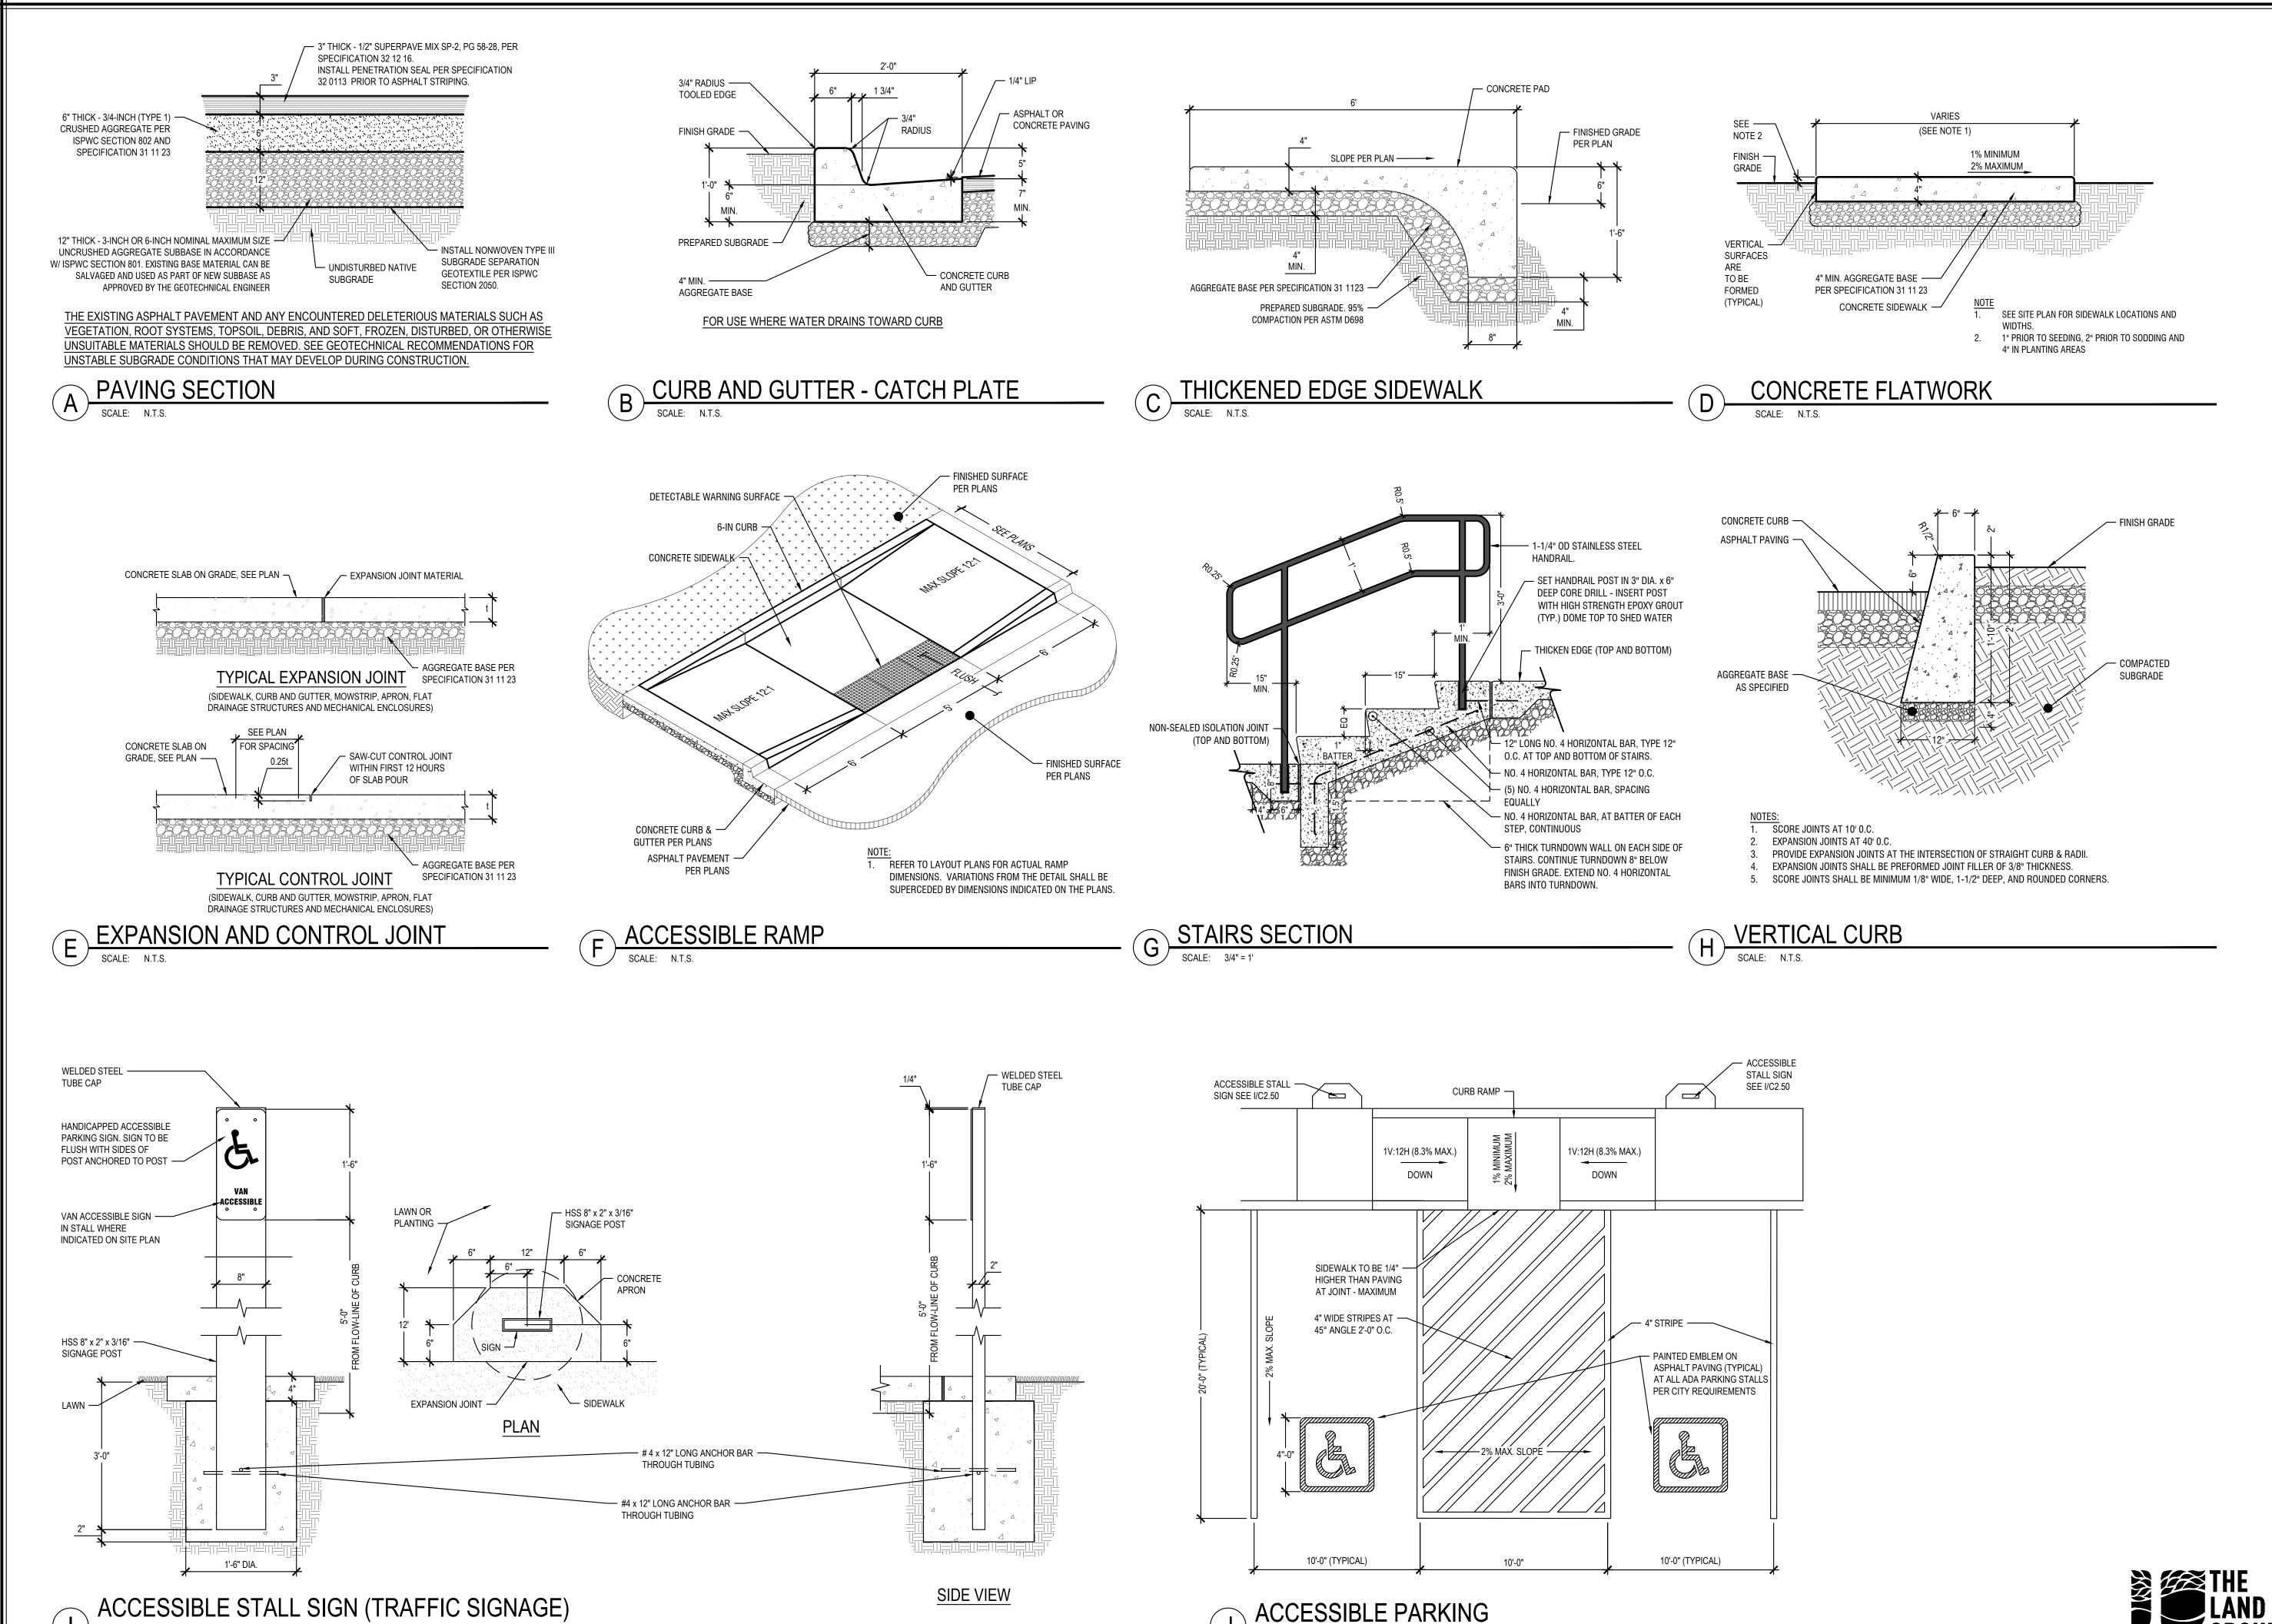



THE CHURCH OF JESUS CHRIST


OF LATTER-DAY SAINTS

PROJECT 22313

C2.50 SEPT. 29, 2023

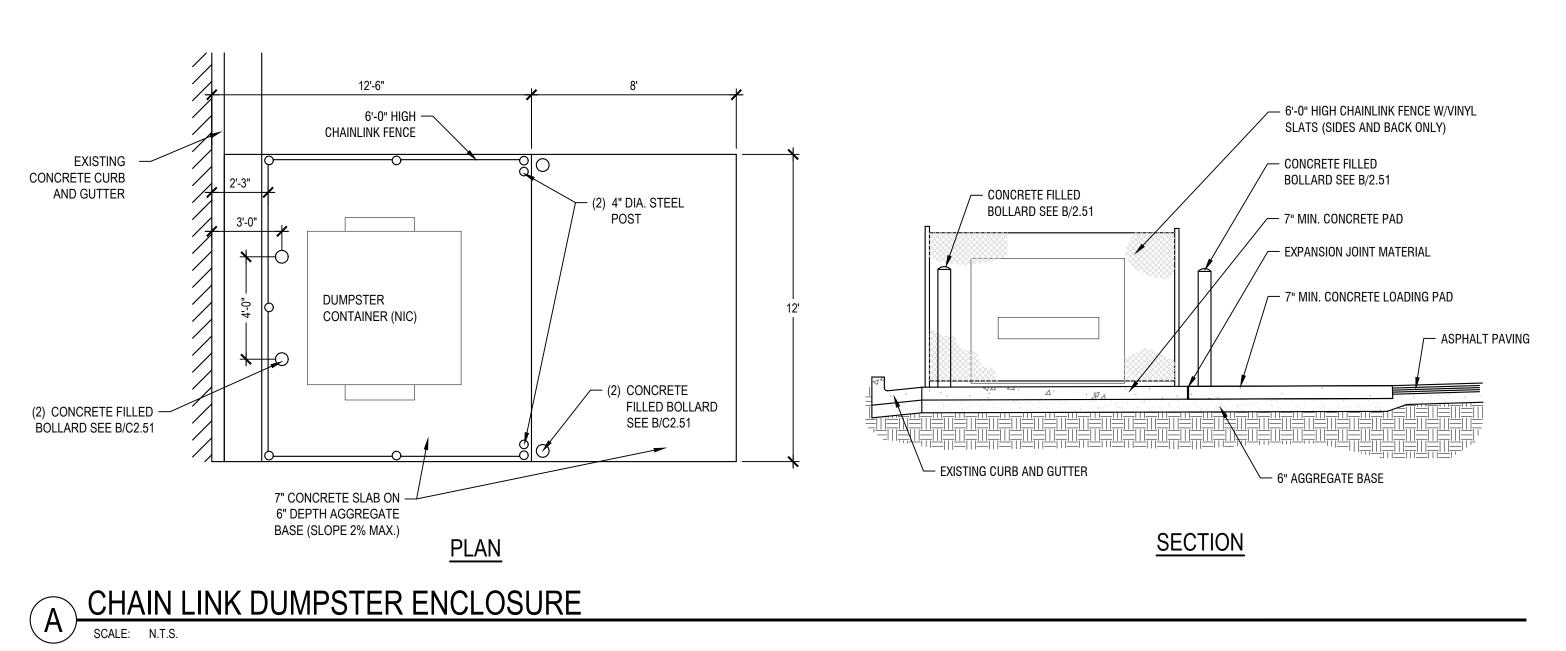

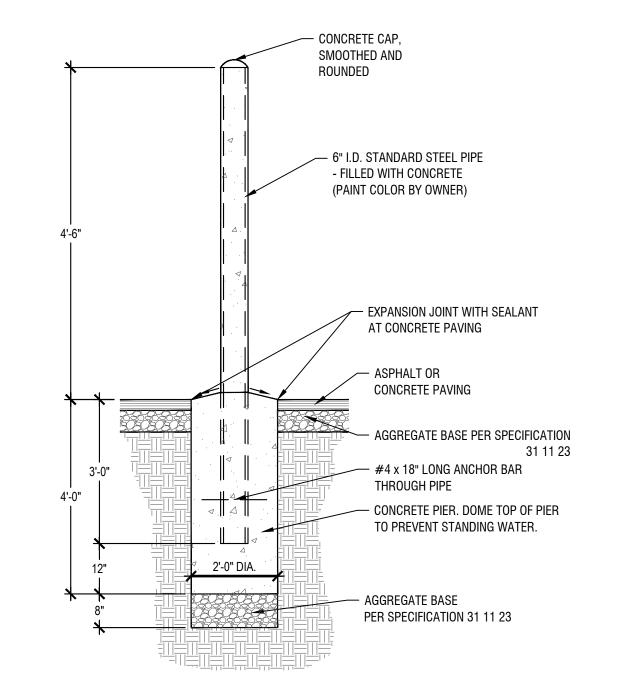

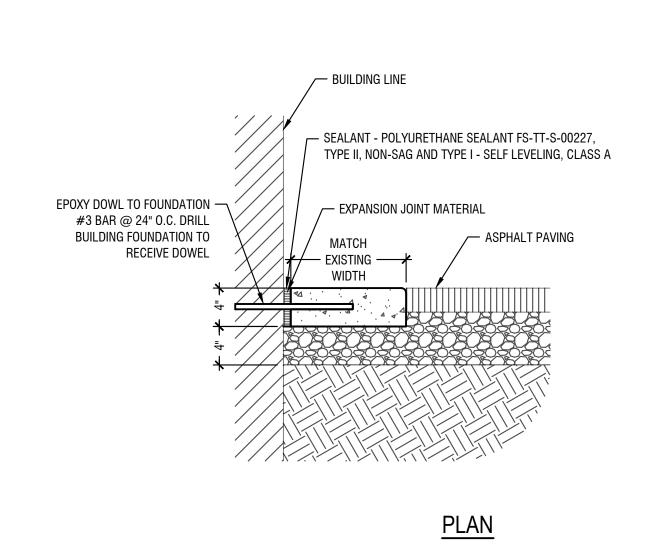

- 24" LONG, NO. 5 REBAR WITH POINTED TIP AND WELDED 1-1/2" DIAMETER WELDED WASHER CAP. - PRECAST CONCRETE PARKING BUMPER AS SPECIFIED, CENTER ON STALL. PAVING, PER PLANS — AGGREGATE BASE AS SPECIFIED COMPACTED SUBGRADE CENTER OF WHEEL STOPS TO BE LOCATED 3' FROM BACK EDGE OF SPUR OR EDGE OF ASPHALT.
 SEE PLANS FOR QUANTITIES AT INDIVIDUAL SITES.


CONCRETE CURB STRIP

SCALE: N.T.S.

CONCRETE PARKING STOP

SCALE: N.T.S.



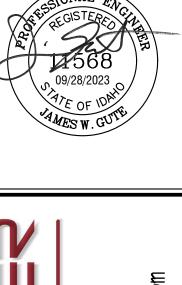

THE CHURCH OF JESUS CHRIST OF LATTER-DAY SAINTS

Site Details

PROJECT 22313




Engineer's Standard Notes:

- 1. THE CONTRACTOR SHALL AT ALL TIMES COORDINATE HIS WORK WITH THAT OF OTHERS ON THE SITE. THE CONTRACTOR SHALL HAVE A RESPONSIBLE PARTY WHO SHALL HAVE THE AUTHORITY TO REPRESENT AND ACT FOR THE CONTRACTOR ON THE JOB SITE DURING ALL WORKING HOURS.
- 2. THE CONTRACTOR IS RESPONSIBLE FOR PERFORMING ALL WORK INDICATED IN THESE PLANS AND SPECIFICATIONS. ANY ITEM INDICATED IN THESE PLANS, BUT NOT ITEMIZED IN THE BID SCHEDULE, WILL BE INCLUDED UNDER A BID SCHEDULE ITEM TO WHICH IT MOST PERTAINS.
- 3. THE CONTRACTOR SHALL EXAMINE THE SITE, COMPARE IT WITH THE PLANS AND SPECIFICATIONS, CAREFULLY EXAMINE ALL OF THE CONTRACT DOCUMENTS, AND SATISFY HIMSELF AS TO THE CONDITIONS UNDER WHICH THE WORK IS TO BE PERFORMED BEFORE ENTERING INTO CONTRACT. NO ALLOWANCE SHALL SUBSEQUENTLY BE MADE ON BEHALF OF THE CONTRACTOR ON ACCOUNT OF AN ERROR ON HIS PART AND/OR HIS NEGLIGENCE AND/OR FAILURE TO ACQUAINT HIMSELF WITH THE CONDITIONS OF THE SITE.
- 4. THE CONTRACTOR SHALL BE RESPONSIBLE FOR ANY DAMAGE TO THE EXISTING STREETS OR SIDEWALKS DURING THE CONSTRUCTION OF THIS PROJECT, AND SHALL REPAIR SUCH DAMAGE TO THE SATISFACTION OF THE GOVERNING AGENCY, AT NO EXTRA COST TO THE OWNER.
- 5. ALL MATERIALS AND FINISHES SHALL BE AS PER DRAWINGS, DETAILS AND SPECIFICATIONS. SOME MATERIALS MAY REQUIRE SEVERAL WEEK ORDER LEAD TIME. CONTRACTOR IS RESPONSIBLE FOR DETERMINING ANY AND ALL ORDERING LEAD TIMES, AND PROVIDING REQUIRED MATERIALS AT THE PROJECT SITE IN A TIMELY MANNER. NO UNAPPROVED SUBSTITUTIONS WILL BE ALLOWED. CONTACT THE DESIGN ENGINEER IMMEDIATELY IF A SPECIFIED MATERIAL IS NOT AVAILABLE.
- 6. ALL EXISTING CONDITIONS AND STRUCTURES, NOT SPECIFICALLY NOTED FOR REMOVAL, SHALL BE RETAINED AND PROTECTED. EXISTING CONDITIONS AND STRUCTURES THAT ARE DAMAGED DURING THE COURSE OF CONSTRUCTIONS SHALL BE REPLACED BY THE CONTRACTOR AT NO ADDITIONAL COST TO THE OWNER.
- 7. THE CONTRACTOR SHALL MAKE ARRANGEMENTS WITH UTILITY COMPANIES AND IS RESPONSIBLE FOR ALL COSTS ASSOCIATED WITH TEMPORARY UTILITIES NECESSARY DURING CONSTRUCTION. CONTRACTOR IS RESPONSIBLE TO PAY ALL UTILITY COSTS DURING CONSTRUCTION AND INCLUDING THE MAINTENANCE PERIOD. COSTS FOR TEMPORARY UTILITIES ARE A PART OF THE BASE BID.
- 8. THE CONTRACTOR SHALL PERFORM ALL CLEARING AND SITE PREPARATION NECESSARY FOR THE PROPER EXECUTION OF ALL WORK INDICATED ON THESE PLANS AND SPECIFICATIONS.
- ALL WORK IS TO BE PERFORMED BY LICENSED CONTRACTORS AND EXPERIENCED WORKERS.
- 10. CONTRACTOR SHALL OBTAIN AND PAY FOR ALL PERMITS NECESSARY TO COMPLETE THE WORK, UNLESS OTHERWISE NOTED.
- 11. CONTRACTOR SHALL CONFORM TO ALL LOCAL CODES.
- 12. THE LAND GROUP, INC. DOES NOT AND CANNOT GUARANTEE THE ACCURACY OF WORK DONE BY OTHERS AND INCLUDES THIS INFORMATION FOR THE CONVENIENCE OF THE CONTRACTOR ONLY. THE CONTRACTOR IS RESPONSIBLE TO CONTACT THE OWNER'S REPRESENTATIVE TO REQUEST CLARIFICATION OF DISCREPANCIES BETWEEN THE INFORMATION SHOWN ON THIS PLAN AND INFORMATION SHOWN ELSEWHERE. IN THE EVENT THE CONTRACTOR PROCEEDS WITH CONSTRUCTION WITHOUT OFFICIAL CLARIFICATION FROM THE OWNER'S REPRESENTATIVE, HE SHALL BE LIABLE FOR THE COST OF CORRECTIVE WORK AND SHALL REPAIR OR RECONSTRUCT THE FAULTY WORK TO THE SATISFACTION OF THE OWNER'S REPRESENTATIVE AT NO ADDITIONAL COST TO THE OWNER.
- 13. THE CONTRACTOR IS RESPONSIBLE FOR PROVIDING, ERECTING AND MAINTAINING THE REQUIRED MATERIALS, EQUIPMENT AND MANPOWER NECESSARY FOR PUBLIC SAFETY AND TRAFFIC CONTROL WITHIN THE PROJECT LIMITS AND ON THE APPROACHES TO THE PROJECT.
- 14. THE CONTRACTOR AGREES THAT IN ACCORDANCE WITH GENERALLY ACCEPTED CONSTRUCTION PRACTICES, CONTRACTOR SHALL BE REQUIRED TO ASSUME SOLE AND COMPLETE RESPONSIBILITY FOR JOB SITE CONDITIONS DURING THE COURSE OF CONSTRUCTION OF THE PROJECT, INCLUDING THE SAFETY OF ALL PERSONS AND PROPERTY, AND THAT THIS REQUIREMENT SHALL BE MADE TO APPLY CONTINUOUSLY AND NOT BE LIMITED TO NORMAL WORKING HOURS. CONTRACTOR FURTHER AGREES TO DEFEND, INDEMNIFY, AND HOLD DESIGN PROFESSIONAL HARMLESS FROM ANY AND ALL LIABILITY, REAL AND ALLEGED, IN CONNECTION WITH THE PERFORMANCE OF WORK ON THIS PROJECT, EXCEPTING LIABILITY ARISING FROM THE SOLE NEGLIGENCE OF THE DESIGN PROFESSIONAL.
- 15. IF ANY ARCHEOLOGICAL, CULTURAL OR HISTORICAL RESOURCES, OR ARTIFACTS OR OTHER FEATURES ARE DISCOVERED DURING THE COURSE OF CONSTRUCTION ANYWHERE ON THE PROJECT SITE, WORK SHALL BE SUSPENDED IN THAT LOCATION UNTIL A QUALIFIED PROFESSIONAL ARCHEOLOGIST ASSESSES THE SIGNIFICANCE OF THE DISCOVERY. THE OWNER SHALL BE NOTIFIED IMMEDIATELY OF ANY FINDS. IN CONSULTATION WITH THE ARCHEOLOGIST AND THE GOVERNING AGENCY. APPROPRIATE MEASURES FOR PRESERVATION SHALL BE ESTABLISHED PRIOR TO THE COMMENCEMENT OF WORK.
- 16. THE LOCATION OF EXISTING UNDERGROUND UTILITIES ON THESE PLANS ARE APPROXIMATE. A REASONABLE EFFORT HAS BEEN MADE TO LOCATE AND DELINEATE ALL UNDERGROUND FACILITIES, HOWEVER THE LAND GROUP, INC. OR IT'S CONSULTANTS ASSUMES NO LIABILITY FOR THE ACCURACY OR COMPLETENESS OF THE EXISTING FACILITIES SHOWN HERE OR FOR THE EXISTENCE OF OTHER UNDERGROUND UTILITIES OR OBJECTS WHICH MAY BE DISCOVERED BUT ARE NOT SHOWN ON THESE PLANS. THE CONTRACTOR SHALL DETERMINE THE EXACT LOCATION OF ANY EXISTING UTILITIES BEFORE COMMENCING WORK. AND AGREES TO BE FULLY RESPONSIBLE FOR ANY AND ALL DAMAGE DUE TO CONTRACTOR'S FAILURE TO EXACTLY LOCATE AND PRESERVE ANY AND ALL UNDERGROUND UTILITIES. THE CONTRACTOR SHALL CONTACT DIGLINE 48 HOURS PRIOR TO ANY EXCAVATION. 1-800-342-1585.
- 17. DURING THE COURSE OF THE WORK, THE CONTRACTOR SHALL COORDINATE AND ACCOMMODATE OTHER CONTRACTORS, OPERATIONS OF THE OWNER, AND LOCAL AGENCIES.
- 18. NOTIFY THE DESIGN ENGINEER OR ARCHITECT PRIOR TO CONSTRUCTION IF INCONSISTENCIES, ERRORS OR DISCREPANCIES ARE FOUND IN THESE PLANS.
- 19. CONTRACTOR SHALL KEEP AN APPROVED SET OF PLANS ON-SITE AT ALL TIMES AND RECORD ASBUILT INFORMATION DURING THE COURSE OF CONSTRUCTION. UPON COMPLETION OF THE PROJECT, THE CONTRACTOR SHALL PROVIDE THE MARKED UP AS-BUILT PLANS TO THE DESIGN ENGINEER FOR PREPARATION AND SUBMITTAL OF RECORD DRAWINGS.
- 20. PER IDAHO CODE 55-1613 (AT THE EXPENSE OF THE CONTRACTOR) THE SURVEYOR THAT PROVIDES THE CONSTRUCTION SURVEYING IS RESPONSIBLE FOR LOCATING ALL PUBLIC LAND CORNERS AND PROPERTY CORNERS PRIOR TO THE START OF CONSTRUCTION. ALL MONUMENTS AND ACCESSORIES DAMAGED OR REMOVED DURING THE COURSE OF CONSTRUCTION MUST BE REESTABLISHED BY OR UNDER THE DIRECTION OF THE SURVEYOR.

Grading & Drainage Notes:

- 1. ALL WORK SHALL BE DONE IN ACCORDANCE WITH THE LATEST EDITION OF THE IDAHO STANDARDS FOR PUBLIC WORKS CONSTRUCTION (CURRENT EDITION), THESE PLANS AND THE PROJECT SPECIFICATIONS.
- 2. CONTRACTOR TO VERIFY ALL EXISTING ELEVATIONS NOTED ON THIS PLAN AND NOTIFY OWNER'S REPRESENTATIVE WHEN ELEVATIONS DO NOT MATCH PLANS.
- 3. TEST PITS SHALL BE RE-EXCAVATED, REFILLED WITH STRUCTURAL FILL, AND COMPACTED TO DESIGN SPECIFICATIONS.
- 4. WASTE SOIL SHALL BE HAULED TO AN OFFSITE DISPOSAL SITE FURNISHED BY THE CONTRACTOR.
- 5. ALL FINISHED GRADES SHALL BE SMOOTH AND UNIFORM.
- 6. PROVIDE POSITIVE DRAINAGE TO ALL CATCH BASINS, DRAINAGE STRUCTURES, CURB CUTS, AND DRAINAGE SWALES.
- 7. CONTRACTOR IS RESPONSIBLE FOR SMOOTH TRANSITION BETWEEN ALL CURB, SIDEWALK AND OR CURB & GUTTER FOR PROPER STORM WATER CONVEYANCE.
- 8. ALL CONCRETE SIDEWALKS SHALL HAVE A MINIMUM OF ONE PERCENT (1%) AND MAXIMUM OF TWO PERCENT (2% MAX) CROSS SLOPE UNLESS OTHERWISE NOTED.
- CONCRETE COLLARS SHALL BE POURED AT ALL STORM DRAINAGE INLETS, LANDSCAPE AREA DRAINS, AND MANHOLES. COLLARS SHALL BE PLACED IN ACCORDANCE WITH ISPWC SD-616.
- 10. PIPE TRENCH SHALL CONFORM TO DIVISION 300 OF THE LATEST EDITION OF THE ISPWC AND SD-301. BEDDING AND BACKFILL SHALL BE CONSTRUCTED PER SECTIONS 305 AND 306 OF THE ISPWC.
- 11. THE CONTRACTOR SHALL TAKE ALL NECESSARY PRECAUTIONS TO PROTECT EXISTING UTILITIES AND IMPROVEMENTS. ANY DAMAGE TO EXISTING FACILITIES OR IMPROVEMENTS RESULTING FROM THE CONTRACTORS OPERATIONS, SHALL BE REPAIRED OR REPLACED AT CONTRACTORS EXPENSE.
- 12. CONTRACTOR IS RESPONSIBLE TO REMOVE ALL DEBRIS CREATED BY GRADING AND DRAINAGE OPERATIONS FROM LANDSCAPE PLANTER AREAS PRIOR TO INSTALLATION OF ANY LANDSCAPE MATERIALS BY THE LANDSCAPE CONTRACTOR.
- 13. ALL PROPOSED STORM DRAINAGE CATCH BASIN INLETS AND MANHOLES SHALL BE COVERED WITH FILTER FABRIC BY THE STORM DRAIN CONTRACTOR TO PREVENT CONTAMINATION OF STORM DRAINAGE FACILITIES. FABRIC SHALL NOT BE REMOVED UNTIL AFTER CONSTRUCTION IS COMPLETE AND LANDSCAPE TURF AREAS HAVE MATURED. COORDINATE WITH PROJECT ESC DOCUMENTS.
- 14. CARE SHALL BE TAKEN TO PREVENT DIRT AND OTHER SUPERFLUOUS MATERIALS FROM ENTERING STORM DRAINAGE FACILITIES DURING CONSTRUCTION.

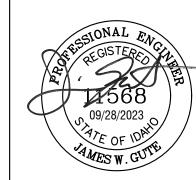



THE CHURCH OF JESUS CHRIST OF LATTER-DAY SAINTS

NUMBER: 22313

CHECKED BY:

SEPT. 29, 2023



