TFSD 2023 CAPITAL IMPROVEMENTS - PACKAGE 3, HALLWAY CEILING IMPROVEMENTS AT MORNINGSIDE ELEMENTARY SCHOOL

PROJECT LOCATION -

701 Morningside Dr. Twin Falls, ID 83301

CLIENT:

VICINITY MAP :

H.A.-JOB # 23010

TWIN FALLS SCHOOL DISTRICT #411

201 Main Ave. W. Twin Falls, ID 83301

HUMMEL

ARCHITECTS

205 N. 10th Street Suite 300 Suite 111 Suite 111

CONSULTANTS:

MECHANICAL / ELECTRICAL ENGINEER

CATOR RUMA

A: #1238, 420 S ORCHARD ST, BOISE, ID 83705

DRAWING SET:

NG SET:

ARCHITECTURAL FIRE PROTECTION ELECTRICAL DRAWING INDEX :

G0.00 COVER SHEET
G0.02 DRAWING INFORMATION

DEMOLITION
D9.01 LEVEL 01 - DEMO RCP

ARCHITECTURAL

A9.01 LEVEL 01 - COMPOSITE CEILING PLAN


A9.02 CEILING FINISH PLAN

FIRE PROTECTION


F0.01 FIRE PROTECTION LEGENDS & NOTES

F2.01 FIRE PROTECTION PLAN - HALLWAY IMPROVEMENTS

ELECTRICAL
E0.01 ELECTRICAL LEGENDS, SCHEDULES & NOTES
E2.01 LIGHTING PLAN - HALLWAY IMPROVEMENTS

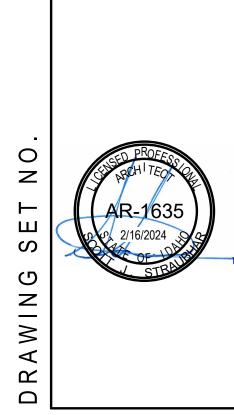



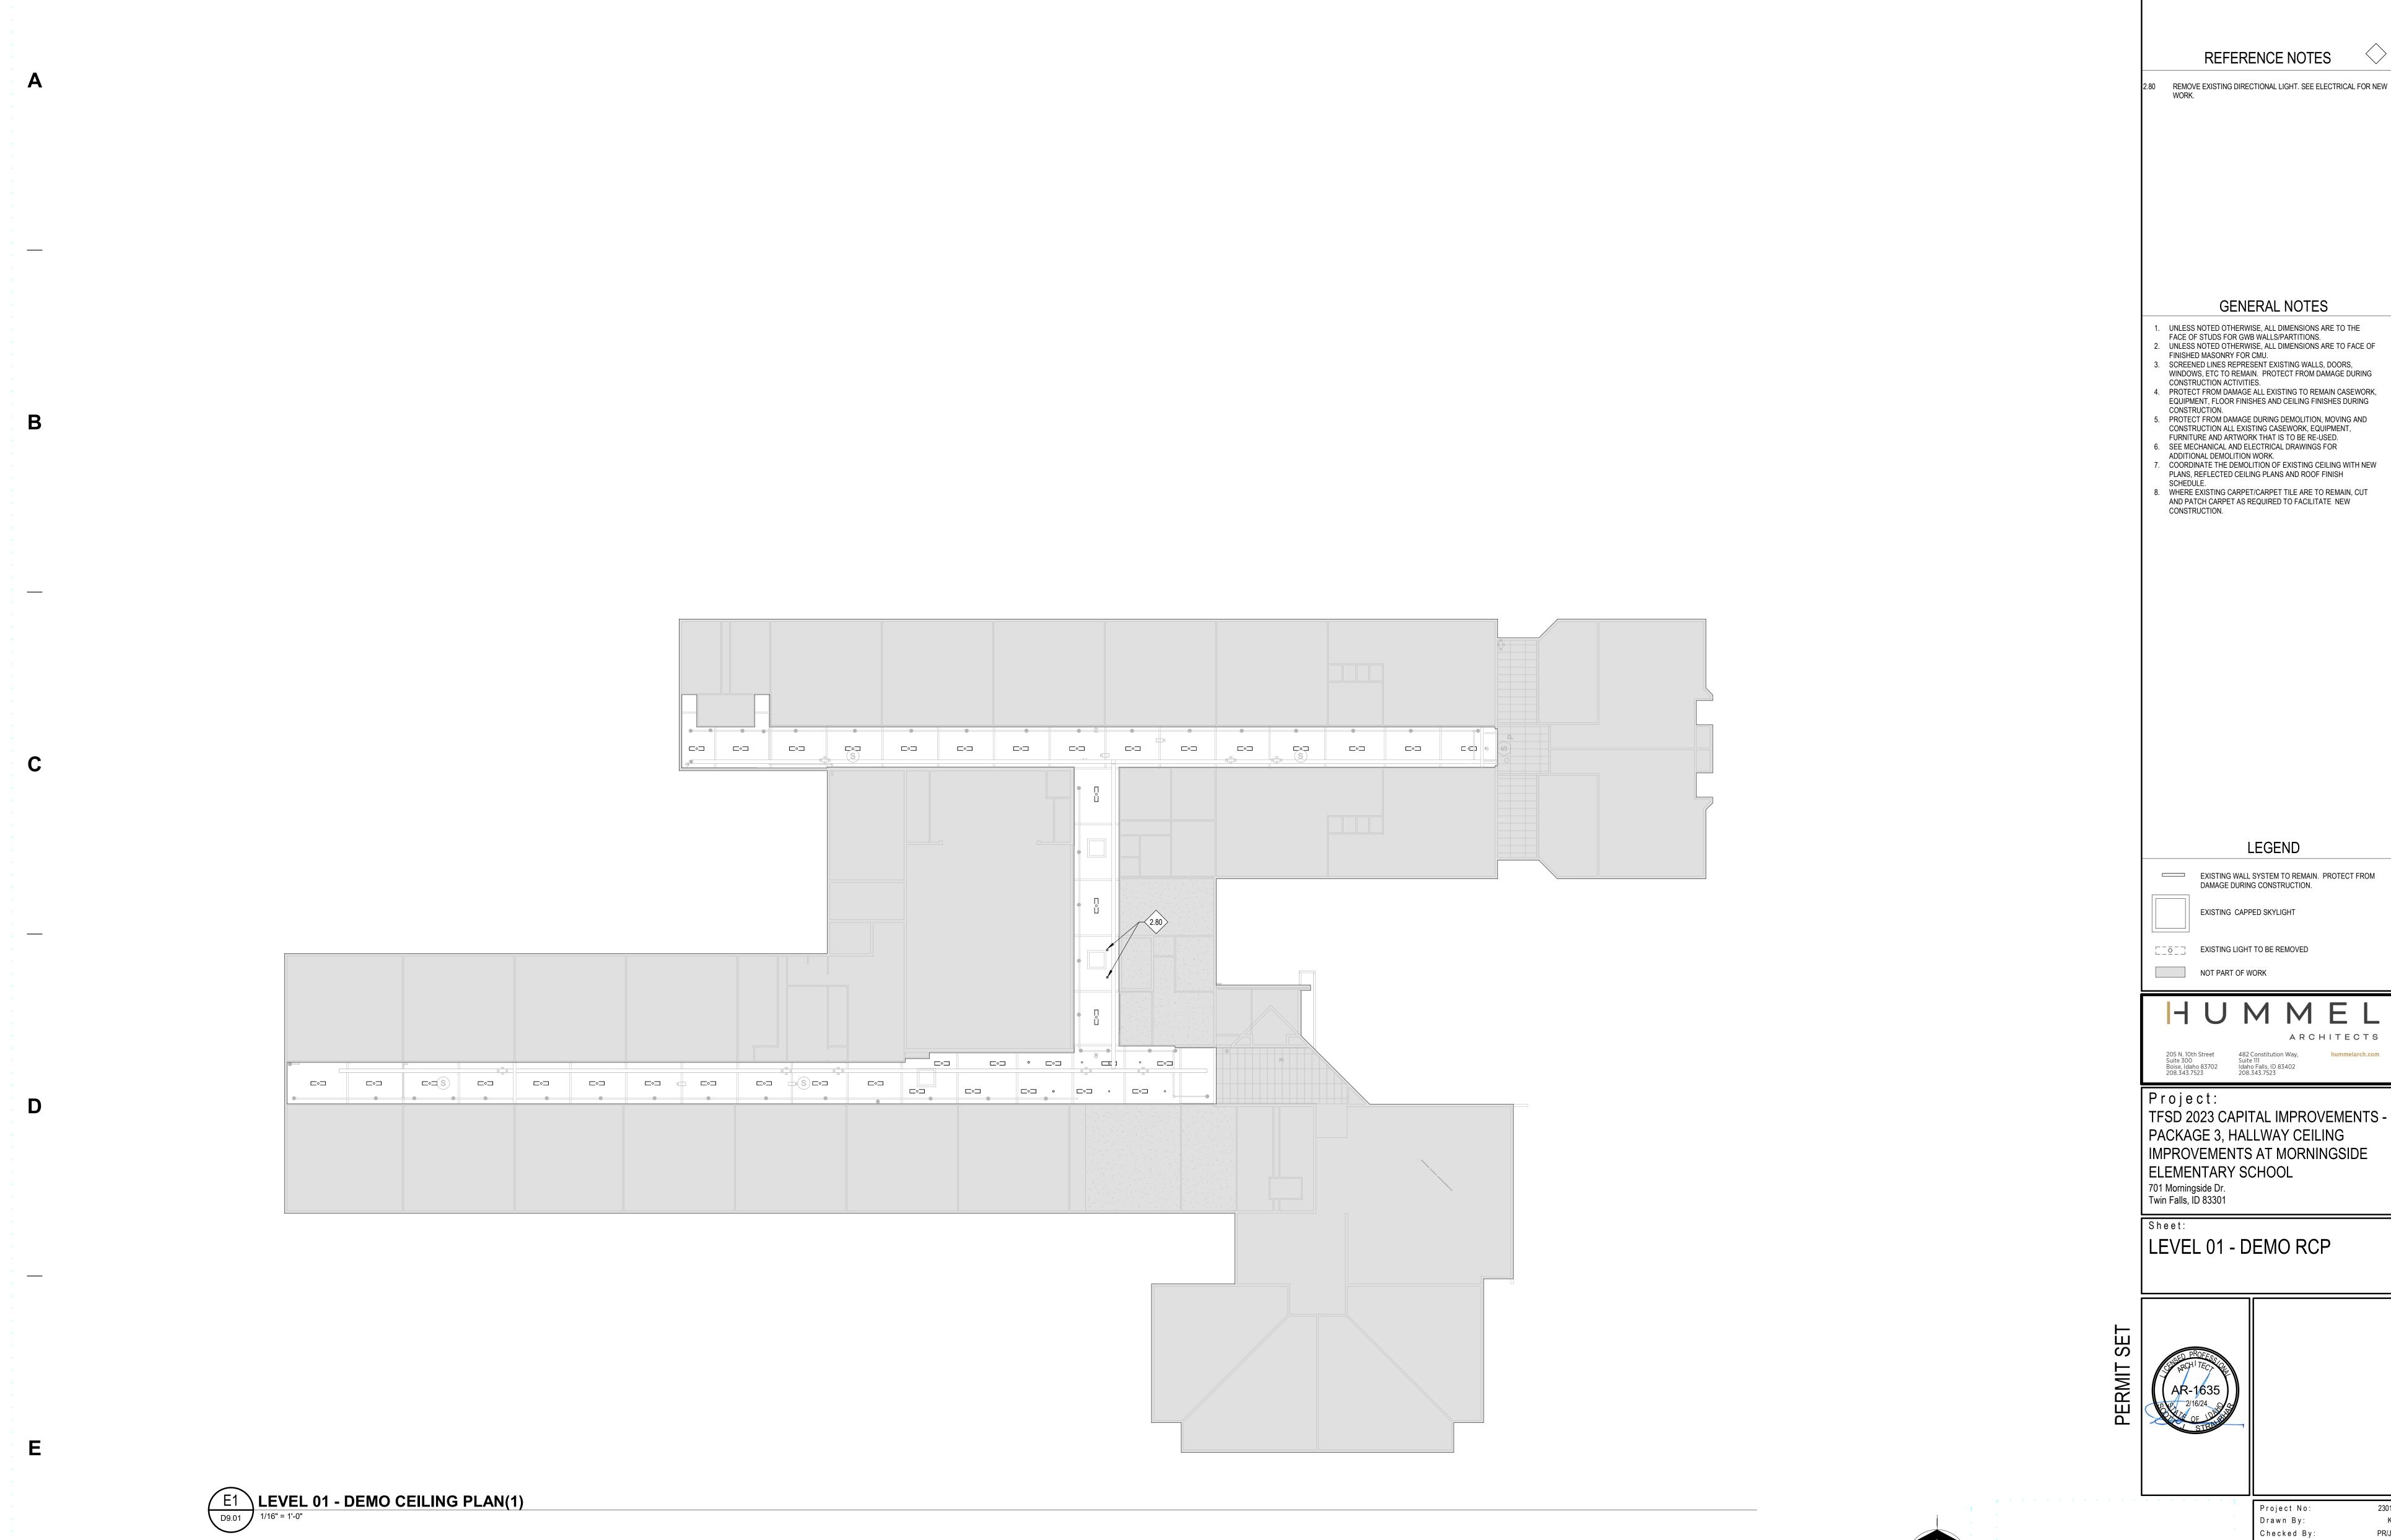


REMOVE EXISTING DIRECTIONAL LIGHT. SEE ELECTRICAL FOR NEW UNLESS NOTED OTHERWISE, ALL DIMENSIONS ARE TO FACE OF WINDOWS, ETC TO REMAIN. PROTECT FROM DAMAGE DURING . PROTECT FROM DAMAGE ALL EXISTING TO REMAIN CASEWORK, EQUIPMENT, FLOOR FINISHES AND CEILING FINISHES DURING 5. PROTECT FROM DAMAGE DURING DEMOLITION, MOVING AND CONSTRUCTION ALL EXISTING CASEWORK, EQUIPMENT, COORDINATE THE DEMOLITION OF EXISTING CEILING WITH NEW WHERE EXISTING CARPET/CARPET TILE ARE TO REMAIN, CUT EXISTING WALL SYSTEM TO REMAIN. PROTECT FROM DAMAGE DURING CONSTRUCTION.

KEYNOTES

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Sheet No:

D9.01

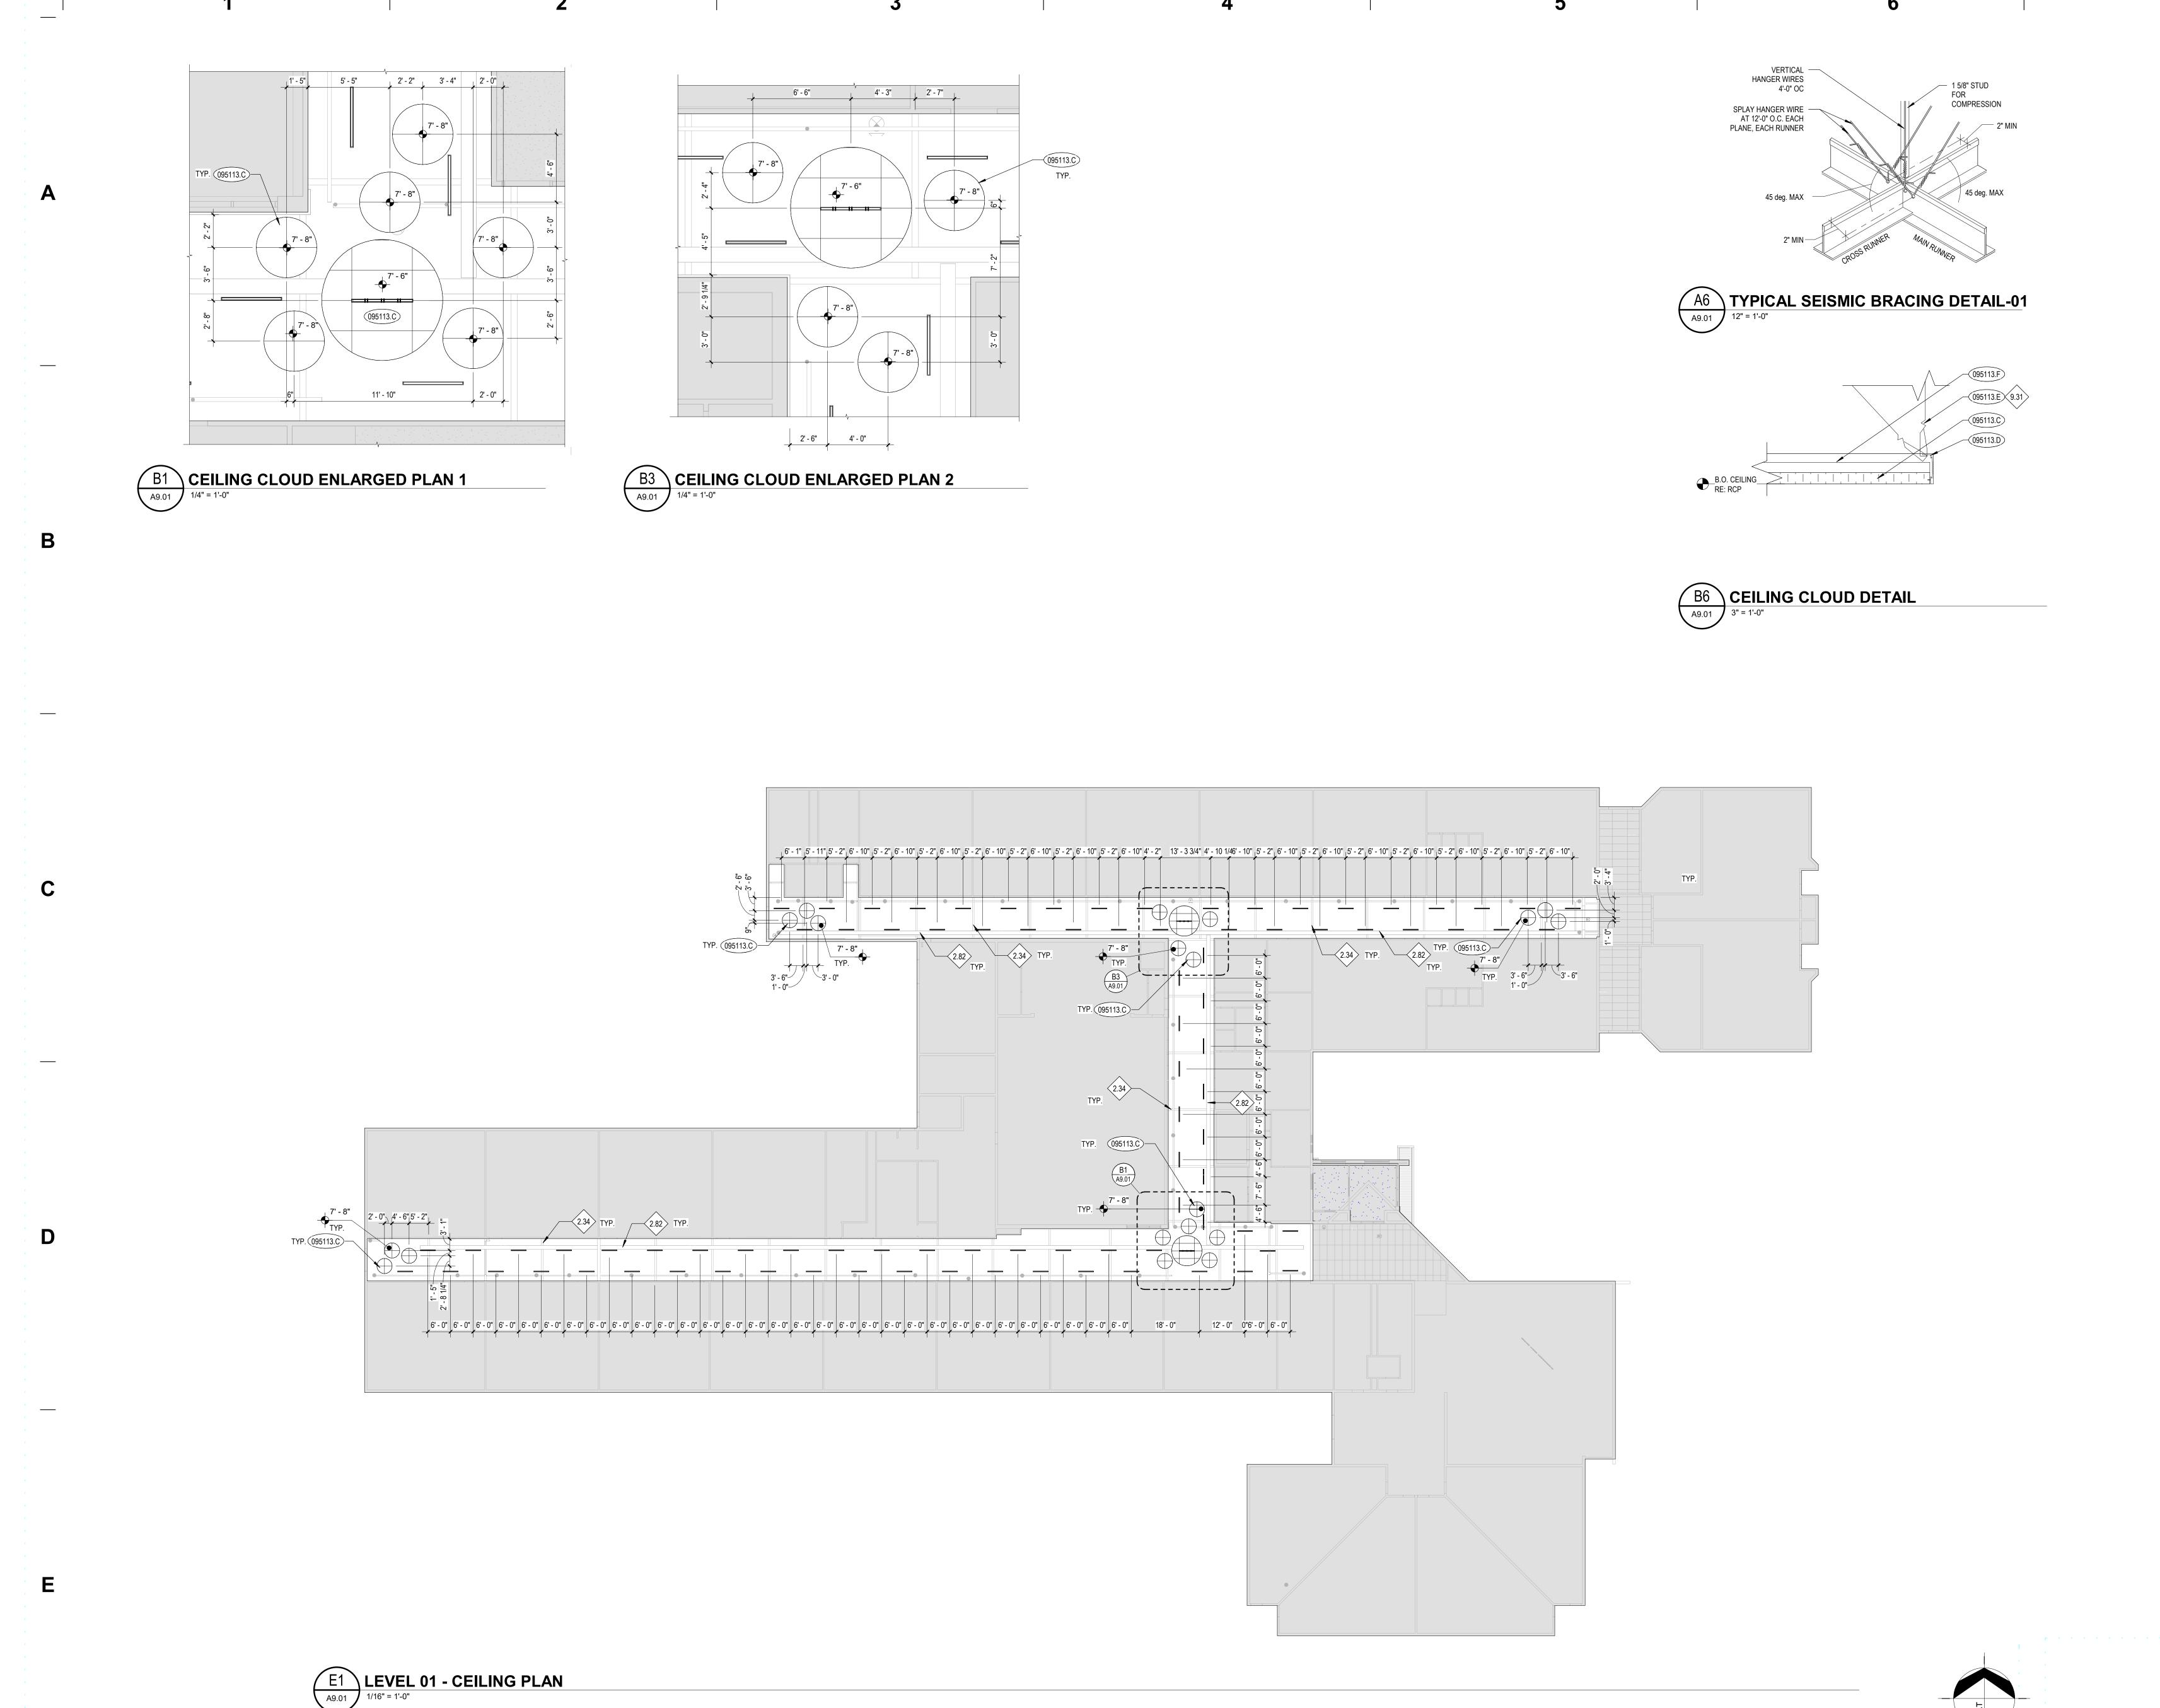

KEYNOTES 095113.D 2" CURBED TRIM, BASIS OF DESIGN: AXIOM VECTOR CURVED PERIMETER TRIM BY ARMSTRONG HANGER WIRE 095113.F T-BAR GRID SYSTEM REFERENCE NOTES EXISTING BEAM TO REMAIN EXISTING DATA TRAY TO REMAIN. PROTECT IN PLACE. SEE FINISH SCHEDULE FOR NEW WORK. CROSS BRACING PER MANUFACTURERS INSTRUCTIONS **GENERAL NOTES** 1. COORDINATE WITH MECHANICAL AND ELECTRICAL DRAWINGS AND SPECIFICATIONS FOR ADDITIONAL ITEMS TO BE PROVIDED AT THE CEILING PLANE AND IN THE WORK. . INSTALL ALL SUSPENSION SYSTEMS FOR ACOUSTICAL PANEL CEILINGS PER PROVISIONS OF ASTM C 635 AND ASTM C 636. . COORDINATE WITH MECHANICAL & ELECTRICAL DRAWINGS AND SPECIFICATIONS FOR PHYSICAL SIZES OF ALL CEILING GRILLES, DIFFUSERS, FIXTURES, CANS, AND ALL RELATED ITEMS. 4. PAINT ALL EXPOSED-TO-VIEW STRUCTURAL DECK, BEAMS AND ASSOCIATED STRUCTURAL ITEMS PAINT COLOR P-9, UNLESS OTHERWISE NOTED. RE: DIVISION 9 SECTION "INTERIOR PAINTING". 5. PAINT ALL EXPOSED-TO-VIEW MECHANICAL DUCTWORK AND ASSOCIATED ITEMS, ELECTRICAL CONDUIT, CABLE TRAYS AND ASSOCIATED ITEMS, PLUMBING AND FIRE PROTECTION LINES AND ALL ASSOCIATED ITEMS PAINT COLOR P-9, UNLESS OTHERWISE NOTED. RE: DIVISION 9 SECTION "INTERIOR 6. RE: DIVISION 9 SECTION "INTERIOR PAINTING" FOR ACOUSTIC CEILING TILE PAINT SYSTEM. NEW WORK SHALL ALLOW FOR CONTINUED FUNCTIONALITY OF THE EXISTING EXIT SIGNS AND SECURITY CAMERAS. ADJUST EXISTING EXIT SIGNS AND SECURITY CAMERAS WHERE NECESSARY AND OTHER ASSOCIATED ITEMS. SEE MECHANICAL, PLUMBING, ELECTRICAL AND FIRE PROTECTION DRAWGINS FOR OTHER ITEMS REQUIRING ADJUSTMENTS. 8'-0" DIAMETER CIRCLE

NOT PART OF WORK HUMMEL ARCHITECTS

LEGEND

4'-0" DIAMETER CIRCLE CLOUD

4'-0" RECESSED LINEAR LIGHT

4'-0" PENDANT LINEAR LIGHT

EXISTING FIRE SPRINKLER & PIPE

205 N. 10th Street Suite 300 Suite 111
Boise, Idaho 83702 Idaho Falls, ID 83402 208.343.7523 208.343.7523 Project:

TFSD 2023 CAPITAL IMPROVEMENTS -PACKAGE 3, HALLWAY CEILING IMPROVEMENTS AT MORNINGSIDE ELEMENTARY SCHOOL 701 Morningside Dr. Twin Falls, ID 83301

LEVEL 01 - COMPOSITE CEILING PLAN

Sheet:

Project No: Drawn By: Checked By

Sheet No:

A9.01

1 LEVEL 01 - CEILING FINISH PLAN
1/16" = 1'-0"

GENERAL NOTES

1. PAINT ALL EXISTING AND NEW ITEMS INCLUDING BUT NOT LIMITED TO STRUCTURAL, MECHANICAL, PLUMBING, FIRE PROTECTION AND ELECTRICAL ITEMS ABOVE NEW CEILING CLOUDS. SEE SHEET A9.01

CEILING FINISH LEGEND

NOT PART OF WORK

C-2, PANEL CEILING COLOR - SEE SPEC SECTION 095113 C-4, PANEL CEILING COLOR - SEE SPEC SECTION 095113

C-5, PANEL CEILING COLOR - SEE SPEC SECTION 095113

C-7, PANEL CEILING COLOR - SEE SPEC SECTION 095113

C-8, PANEL CEILING COLOR - SEE SPEC SECTION 095113

HUMMEL

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Project: TFSD 2023 CAPITAL IMPROVEMENTS -PACKAGE 3, HALLWAY CEILING IMPROVEMENTS AT MORNINGSIDE ELEMENTARY SCHOOL

Sheet: CEILING FINISH PLAN

701 Morningside Dr. Twin Falls, ID 83301

CONSOLIDATED 2/23/2024 SET

Project No: Drawn By: Checked By:

	2	3

		GENERA (Not all symbols listed belo	L LEGE ow are used on t	ND hese drawings)	
ABBR.	SYMBOL	DESCRIPTION	ABBR.	SYMBOL	DESCRIPTION
		CECTION DECICNATION	II		CAP END OF PIPE
	$\left(\begin{array}{c} X \\ X-X \end{array}\right)$	─ SECTION DESIGNATION ─ SECTION CUT ON THIS SHEET		SLOPE	PITCH DOWN IN DIRECTION OF ARROW
		— SECTION COT ON THIS SHEET		×	PIPE ANCHOR
	X	VIEW REFERENCE DESIGNATION		_=_	PIPE ALIGNMENT GUIDE
	X-X	- VIEW REFERENCE ON THIS SHEET			UNION OR FLANGE
	X	— EQUIPMENT UNIT IDENTIFICATION	1		CONCENTRIC PIPE REDUCER
	1-2-3	EQUIPMENT UNIT NUMBER (UNIT SERVED - FLOOR - SEQUENCE #)		-	ECCENTRIC PIPE REDUCER
	10	DIFFUSER IDENTIFICATION	PRV	-\$-	PRESSURE REDUCING VALVE
\boxtimes	A) 10 250	─ DIFFUSER NECK DIAMETER─ DIFFUSER CFM	PTRV	<u></u>	PRESSURE AND/OR TEMPERATURE RELIEF VALVE
		LINEAR DIFFUSER IDENTIFICATION	11		ISOLATION VALVE (RE: SPEC FOR TYPE)
	E)8ø/24"L	LINEAR DIFFUSER NECK DIAMETER LINEAR DIFFUSER LENGTH			VERTICAL PIPE VALVE
	9999	LINEAR DIFFUSER CFM	CV	_ _ \	CHECK VALVE
		FINNED TUBE RADIATOR ACTIVE ELEMENT LENGTH	11	— ぬ—	SOLENOID / MOTORIZED VALVE
	2'-6" FTR 28	EQUIPMENT UNIT IDENTIFICATION EQUIPMENT UNIT NUMBER		——₩—	SOLENOID VALVE
	3-0 20	RADIATOR ENCLOSURE LENGTH (OR W-W=WALL-TO-WALL)		—-дн	HOSE END DRAIN VALVE
		KEY NOTE REFERENCE	P/T		PRESSURE / TEMPERATURE TAP
	1	KITCHEN/OWNER/MEDICAL EQUIPMENT REFERENCE			STRAINER
	\Diamond	TYPICAL ROOM REFERENCE (TOP = RM #, BOTTOM = FLR)	1	 	STRAINER W/ BLOWDOWN
	•	POINT OF CONNECTION, NEW TO EXISTING	1	——————————————————————————————————————	BRAIDED FLEXIBLE PIPE CONNECTOR
		POINT OF DISCONNECTION, DEMO	1	<u>—</u> ————	DOUBLE-BOWL FLEXIBLE PIPE CONNECTOR
	-	DIRECTION OF FLOW IN PIPE	1	Т	THERMOMETER
	[::::::::::::::::::::::::::::::::::::::	DUCTWORK, PIPING AND EQUIPMENT TO BE REMOVED	1	9	PRESSURE GAUGE
(E)		EXISTING	11		SIGHT GLASS
(N)		NEW	C.A.P.		CEILING ACCESS PANEL
(R)		RELOCATED	11	-	PUMP
(F)		FUTURE	ТВ		THRUST BLOCK
DIA	Ø	DIAMETER	MAV		MANUAL AIR VENT
WAD		WALL ACCESS DOOR	AAV	<u></u>	AUTOMATIC AIR VENT
NIC		NOT IN CONTRACT			
AFF		ABOVE FINISHED FLOOR			
GC		GENERAL CONTRACTOR			
МС		MECHANICAL CONTRACTOR			
EC		ELECTRICAL CONTRACTOR			
UNO		UNLESS NOTED OTHERWISE	11		
С		COMMON	11		
NC		NORMALLY CLOSED	11		
NO		NORMALLY OPEN	11		

FIRE PROTECTION LEGEND (Not all symbols listed below are used on these drawings)										
ABBR. SYMBOL DESCRIPTION ABBR. SYMBOL DESCRIPTION										
F	——F——	FIRE SERVICE PIPING		•	NEW SPRINKLER HEAD					
O.S.&Y.		O.S.&Y. GATE VALVE W/ TAMPER SWITCH		0	EXISTING SPRINKLER HEAD					
FS		FLOW SWITCH		•	RELOCATED SPRINKLER HEAD					
PIV		POST INDICATOR VALVE		\triangleright	SIDEWALL SPRINKLER HEAD					
FDC	-	FIRE DEPARTMENT CONNECTION		D24	DRY SPRINKLER HEAD (SHAFT LENGTH)					
			FHC		FIRE HOSE CABINET					
			FVC		FIRE VALVE CABINET					
			A/S		AUTOMATIC FIRE SPRINKLER					

FIRE PROTECTION NOTES:


- FURNISH ALL LABOR, MATERIALS, EQUIPMENT AND SERVICES NECESSARY FOR THE INSTALLATION OF A COMPLETE AND PROPERLY FUNCTIONING FIRE PROTECTION SYSTEM.
- THE FIRE PROTECTION WORK INVOLVES ENGINEERING AND DESIGN BY THE CONTRACTOR TO DETERMINE THE EXTENT OF NEW WORK AND THE MODIFICATION AND EXTENSION OF EXISTING SYSTEMS TO PROVIDE FULL COVERAGE TO THE PROJECT AREA SHOWN ON THESE AND THE ARCHITECTURAL PLANS.
- 3. THE INFORMATION PRESENTED ON THESE DRAWINGS IS DIAGRAMMATIC. IT DOES NOT NECESSARILY REPRESENT ALL ELBOWS, OFFSETS, HANGERS, ETC., REQUIRED FOR A COMPLETE WORKING SYSTEM.
- 4. ALL FIRE PROTECTION SYSTEMS INSTALLED SHALL BE IN ACCORDANCE WITH NFPA-13, 14, 20, ETC. AND LOCAL BUILDING CODES AND ORDINANCES.
- 5. FIRE PROTECTION CONTRACTOR SHALL COORDINATE THE LOCATION OF ALL NEW FIRE PROTECTION EQUIPMENT AND PIPING WITH ALL OTHER TRADES PRIOR TO SUBMITTAL OF SHOP DRAWINGS AND SYSTEM INSTALLATION, SO AS NOT TO INTERFERE WITH THE ROUTING OF NEW DUCTWORK, PLUMBING PIPING, ETC.
- 6. PROVIDE ALL FITTINGS, RISER NIPPLES, ARM-OVERS, HANGERS, ETC. TO MAINTAIN CONFORMANCE WITH APPLICABLE STANDARDS AND TO POSITION THE SPRINKLERS IN THE PROPER LOCATIONS.
- SEAL ALL PIPE PENETRATIONS THROUGH FIRE RATED WALLS AND CEILINGS WITH FIRE STOPPING MATERIALS AS REQUIRED.
- 8. FOR REMODEL AREAS NEW SPRINKLERS SHALL MATCH EXISTING SPRINKLERS.
- PROVIDE WORKING DRAWINGS AND HYDRAULICALLY CALCULATE THIS FIRE SPRINKLER SYSTEM PER NFPA-13 WHERE REQUIRED BY THE LOCAL AUTHORITY HAVING JURISDICTION.
- 10. PROVIDE FIELD COORDINATION OF PIPING AND SPRINKLER INSTALLATIONS WITH DUCTWORK, LIGHTS, SMOKE DETECTORS, DIFFUSERS, ETC.





Project:
TFSD 2023 CAPITAL IMPROVEMENTS PACKAGE 3, HALLWAY (CEILING)
IMPROVEMENTS AT MORNINGSIDE
ELEMENTARY SCHOOL
600 Harrison St.
Twin Falls, ID 83301

FIRE PROTECTION LEGENDS & NOTES

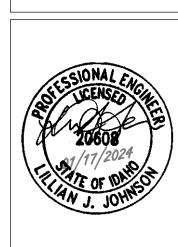

Project No: Drawn By: Checked By

Checked By: Date:

Sheet No:

F0.01

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/2024 10:33:46 AM aho\2023\2023-435 TFSD Capital FIRE PROTECTION PLAN - HALLWAY IMPROVEMENTS
SCALE: 1/16" = 1'-0"

IF LINE DOES NOT MEASURE 1 INCH, DRAWING IS NOT TO SCALE

KEYNOTES


F1 MODIFY THE EXISTING FIRE SPRINKLER LAYOUT PER NFPA 13 TO ACCOMMODATE NEW CLOUD CEILINGS. REFER TO ARCHITECTURAL CEILING PLANS FOR MORE INFORMATION. REPLACE EXISTING SPRINKLER HEADS WITH QUICK RESPONSE HEADS AS NEEDED. COORDINATE WORK WITH OTHER TRADES.



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Project: TFSD 2023 CAPITAL IMPROVEMENTS -PACKAGE 3, HALLWAY (CEILING) IMPROVEMENTS AT MORNINGSIDE ELEMENTARY SCHOOL 600 Harrison St. Twin Falls, ID 83301

FIRE PROTECTION PLAN -HALLWAY IMPROVEMENTS

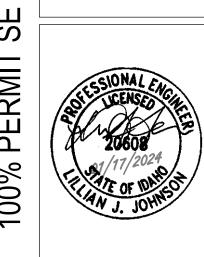

Project No: Drawn By: Checked By:

Sheet No:

	LIGHTING (Not all symbols listed below	G LEGEND w are used on these drawings)				
SYMBOL	DESCRIPTION	SYMBOL	DESCRIPTION			
a A	SHADING INDICATES EM SYSTEM, LOWER CASE SUBSCRIPT INDICATES SWITCHING, UPPER CASE SUBSCRIPT INDICATES LUMINAIRE TYPE (TYP)	0 .	PENDANT LUMINAIRE - SINGLE SUSPENSION			
	TROFFER - RECESSED	\odot	PENDANT LUMINAIRE - MULTIPLE SUSPENSION			
0	SURFACE LUMINAIRE	Ω	WALL MOUNTED LUMINAIRE			
	LINEAR LUMINAIRE - RECESSED	₽	IN-WALL LUMINAIRE			
A — B	FIELD MEASURED LUMINAIRE LENGTH AND SHAPE DENOTED BY LINEWORK SUBSCRIPT IN RECTANGLE INDICATES LUMINAIRE TYPE	구수	POLE LUMINAIRE - ARM MOUNTED			
Ø	DOWNLIGHT - RECESSED	なは	POLE LUMINAIRE - POST TOP			
0	DOWNLIGHT - SURFACE		BOLLARD			
⊗	EXIT SIGN - CEILING MOUNTED		TRACK HEAD AND TRACK			
⊗	EXIT SIGN - WALL MOUNTED (FLUSH TO WALL)	⋈	EXTERIOR STAKE MOUNTED			
₽ ₽	EXIT SIGN - WALL MOUNTED (PROJECTS FROM WALL)	4_	EMERGENCY LIGHTING UNIT - WALL MOUNTED			
* 3	INDICATES EXIT SIGN FACES - SINGLE OR DOUBLE	Σď	EMERGENCY LIGHTING UNIT - CEILING MOUNTED			
<u></u> — —	INDICATES EXIT SIGN CHEVRONS - LEFT/RIGHT OR BOTH	>	INDICATES DIRECTIONAL AIMING			

	CONTROLS LEGEND (Not all symbols listed below are used on these drawings)										
YMBOL	DESCRIPTION	SYMBOL	DESCRIPTION								
Sa	SINGLE POLE SWITCH (SUBSCRIPT DENOTES SWITCHING)	S _{VS}	VARIABLE SPEED/SPEED CONTROLLER SWITCH								
S ₂	TWO POLE SWITCH	S _{EP}	EXPLOSION PROOF SWITCH								
S ₃	THREE-WAY SWITCH	S _{TO}	THERMAL OVERLOAD SWITCH								
S ₄	FOUR-WAY SWITCH	S _{MC}	MOMENTARY CONTACT SWITCH								
s _K	KEY OPERATED SWITCH	Q S	COMBINATION SWITCH AND DUPLEX RECEPTACLE								
S _M	MANUAL SWITCH, HORSEPOWER RATE	P	PHOTOCELL								
S _D	DIMMER SWITCH	•	PUSH BUTTON								
S _{PI}	SWITCH WITH PILOT LIGHT (PILOT LIGHT IS 'ON' WHEN SWITCH IS 'ON')	TC	TIME CLOCK								
S _P	SWITCH WITH PILOT LIGHT LOCATOR (CONTINUOUSLY LIGHTED HANDLE)	Œ	OCCUPANCY SENSOR - WALL MOUNTED IR=INFRARED, US=ULTRASONIC, DT=DUAL TECHNOLOGY								
S _{LV}	LOW VOLTAGE SWITCH										

	REFERENCE SY (Not all symbols listed below		
SYMBOL	DESCRIPTION	SYMBOL	DESCRIPTION
\Leftrightarrow	KEY NOTE REFERENCE	1	KITCHEN/OWNER/MEDICAL EQUIPMENT REFERENCE
LPA-#	TYPICAL CIRCUIT NUMBER	Æ	EXISTING TO REMAIN
TG# (TYPICAL LUMINAIRE TYPE	R	EXISTING TO BE REMOVED
	TYPICAL ROOM REFERENCE (TOP = RM #, BOTTOM = FLR)	<u>RL</u>	EXISTING TO BE RELOCATED
UH	MECHANICAL EQUIPMENT REFERENCE	A	EXISTING TO REMAIN - REPLACE DEVICE
LC1	LIGHTING CONTROL / EQUIPMENT REFERENCE	<u></u> 	EXISTING TO BE REMOVED AND REPLACED
LC1	ELECTRICAL ACCESSORIES REFERENCE		

ABBREVIATIONS LEGEND

SYMBOL	DESCRIPTION	SYMBOL	DESCRIPTION
А	AMPERES	MCP	MOTOR CIRCUIT PROTECTOR
AC	ABOVE COUNTER, MOUNT HORIZONTALLY TO CENTERLINE OF DEVICE, +6" ABOVE COUNTER OR BACK SPLASH	MEC	SEE MECHANICAL EQUIPMENT SCHEDULE
AFF	ABOVE FINISHED FLOOR	MIN	MINIMUM
AFG	ABOVE FINISHED GRADE	MLO	MAIN LUGS ONLY
ANN	ANNUNCIATOR	MTS	MANUAL TRANSFER SWITCH
ARF	ABOVE RAISED FLOOR	NC	NORMALLY CLOSED
ASSD	AIR SAMPLING SMOKE DETECTION	NIC	NOT IN CONTRACT
ATS	AUTOMATIC TRANSFER SWITCH	NL	NIGHT LIGHT
BFG	BELOW FINISHED GRADE	NO	NORMALLY OPEN
С	CONDUIT	NTS	NOT TO SCALE
CATV	CABLE TELEVISION	ОС	ON CENTER
СВ	CIRCUIT BREAKER	OFCI	OWNER FURNISHED, CONTRACTOR INSTALLED
CCTV	CLOSED CIRCUIT TELEVISION	OFOI	OWNER FURNISHED, OWNER INSTALLED
(E)	EXISTING	OSWF	ON SITE WORK FORCE
EM	EMERGENCY	РВ	PULL BOX
EMDC	EMERGENCY MAIN DISTRIBUTION CENTER	SB	STAND-BY
EP	EXPLOSION PROOF	SDC	SUB-DISTRIBUTION CENTER
EPO	EMERGENCY POWER OFF	TP	TAMPER PROOF
EVO	EMERGENCY VENTILATION ON/OFF	TVSS	TRANSIENT VOLTAGE SURGE SUPPRESSER
EWC	ELECTRIC WATER COOLER	TYP	TYPICAL
FA	FIRE ALARM	UF	UNDER FLOOR
G	GROUND	UG	UNDER GROUND
GCP	GENERATOR CONTROL PANEL	UON	UNLESS OTHERWISE NOTED
GFCI	GROUND FAULT CIRCUIT INTERRUPTER	UPS	UNINTERRUPTIBLE POWER SUPPLY
HOA	HAND OFF AUTOMATIC	V	VOLTS
IG	ISOLATED GROUND	VFD	VARIABLE FREQUENCY DRIVE
MAX	MAXIMUM	W/	WITH
MCB	MAIN CIRCUIT BREAKER	W/O	WITHOUT
MCC	MOTOR CONTROL CENTER	WP	WEATHER PROOF
MDC	MAIN DISTRIBUTION CENTER	XFMR	TRANSFORMER

LIGHTING PLAN NOTES:

- REFER TO ARCHITECTURAL ELEVATIONS AND REFLECTED CEILING PLANS FOR EXACT MOUNTING LOCATIONS OF DEVICES AND LUMINAIRES.
- 2. COORDINATE LUMINAIRE LOCATIONS WITH MECHANICAL PIPING, DUCTWORK, ETC., TO AVOID CONFLICTS. SEE SPECIFICATIONS FOR COORDINATION

GENERAL NOTES:

- FOR REMODELING, WORK INCLUDED IS DENOTED IN BOLD. EXISTING CONDITIONS TO REMAIN ARE DENOTED LIGHTLY.
- 2. PROTECT STRUCTURE AND OWNER EQUIPMENT FROM DAMAGE. IMMEDIATELY REPLACE OR REPAIR, TO ORIGINAL CONDITION, DAMAGE CAUSED BY THE CONTRACTOR WHETHER EQUIPMENT APPEARS TO BE CURRENTLY IN USE OR NOT, UNLESS WRITTEN AUTHORIZATION FROM THE OWNER INDICATED OTHERWISE. PREPARE LISTING OF ALL EXISTING DAMAGED ITEMS AND SUBMIT TO OWNER PRIOR TO BEGINNING WORK.
- COORDINATE EXACT REQUIREMENTS AND LOCATIONS OF MECHANICAL EQUIPMENT WITH MECHANICAL DRAWINGS AND MECHANICAL CONTRACTOR PRIOR TO ROUGH-IN AND ORDERING MATERIALS OR EQUIPMENT.
- 4. EXISTING INFORMATION SHOWN ON THE DRAWINGS HAS BEEN TAKEN FROM OWNER FURNISHED DRAWINGS AND/OR LIMITED FIELD OBSERVATIONS. CATOR, RUMA & ASSOCIATES IS NOT RESPONSIBLE FOR THE ACCURACY OF ANY INFORMATION OR THE ADEQUACY, SAFETY AND CONFORMANCE TO CURRENT PREVAILING CODES OF ANY WORK SHOWN AS EXISTING ON THESE DRAWINGS.

DEMOLITION NOTES:


- UNLESS NOTED OTHERWISE, BOLD ITEMS INDICATE EQUIPMENT, DEVICES, ETC. TO BE REMOVED. SEE SPECIFICATION SECTION 260500 FOR REMODEL/DEMOLITION DETAILED REQUIREMENTS.
- 2. DEMOLITION DRAWINGS MAY NOT SHOW EVERY ITEM TO BE DEMOLISHED. CONTRACTOR SHALL VISIT SITE TO DETERMINE AND COORDINATE THE EXACT EXTENT OF DEMOLITION TO FACILITATE ALL WORK INDICATED BY THE CONTRACT DOCUMENTS PRIOR TO QUOTATION. NO EXTRAS WILL BE ALLOWED FOR WORK REQUIRED TO ACHIEVE THE END RESULT AS INDICATED BY THE CONTRACT DOCUMENTS. REWORK EXISTING TERMINATIONS, CONNECTIONS, CONDUIT, WIRING, ETC. TO ACCEPT NEW WORK. MAINTAIN CIRCUIT CONTINUITY TO EXISTING CIRCUITS AND DEVICES TO REMAIN OR REMODEL/DEMOLITION DETAILED REQUIREMENTS TO BE RELOCATED. PRIOR TO COMMENCEMENT OF ANY DEMO WORK, CONFIRM EXISTING CONDITIONS AND NOTIFY ENGINEER OF ANY DISCREPANCIES FOR RESOLUTION.
- 3. ALL ITEMS IDENTIFIED TO BE REMOVED SHALL BE REMOVED IN THEIR ENTIRETY INCLUDING ALL WIRING AND EXPOSED CONDUIT AND CONDUIT SUPPORTS BACK TO POINT OF ORIGIN OR NEXT DEVICE TO REMAIN. REMOVED ITEMS SHALL BE TURNED OVER TO THE OWNER, UNLESS NOTED OTHERWISE, AND STORED IN THE AREA DESIGNATED BY THE OWNER. REMOVE FROM SITE AND LEGALLY DISPOSE OF ALL ITEMS THE OWNER CHOOSES NOT TO ACCEPT.
- 4. REUSE EXISTING CONDUIT WHERE CURRENT NEC AND LOCAL CODE REQUIREMENTS ARE MAINTAINED. PROVIDE NEW CONDUIT AND WIRE FOR NEW INSTALLATIONS AND EXTENSION OF EXISTING INSTALLATIONS. REUSE EXISTING CONDUIT IN PLACE, DO NOT REINSTALL EXISTING CONDUIT. PROVIDE LABELING PER SPECIFICATIONS FOR REUSED CONDUIT.
- RELOCATED EQUIPMENT AND DEVICES ARE TO BE CLEANED OF ALL FOREIGN MATERIAL. REPLACE EQUIPMENT OR DEVICES WHICH ARE DEFECTIVE OR DAMAGED DURING RELOCATION.



Allowed Interior Lighting Power					
Α	В		C		D
Area Category	Floor Are (ft2)		Allowed Watts / f		llowed Watts
1-Corridor (School/University)	6433		0.81		5211
		Total	Allowed Wa	atts =	5211
Proposed Interior Lighting Power					
A		В	С	D	E
Fixture ID: Description / Lamp / Wattage Pe		mps/ xture	# of Fixture	Fixture Watt.	(C X D
Corridor (School/University, 6433 sq.ft.)					
LED: L1: RE: LUMINAIRE SCHEDULE: Other:		1	2	6	12
LED: L2: RE: LUMINAIRE SCHEDULE: Other:		1 To	88 tal Propose	17 ed Watts =	1496 1508
Interior Lighting PASSES			•		
Interior Lighting Compliance					
Statement					
Compliance Statement: The proposed interior lighting altera	tion project represented in t	nis docu	ıment is co	nsistent w	ith the
building plans, specifications, and other calculations submitted systems have been designed to meet the 2018 IECC requirer					
applicable mandatory requirements listed in the Inspection C		SOMETIC	ckvvcb and	a to compi	y with ally
Kyle Olson, PE - Electrical Engineer	/4 hOle		01/1	7/2024	
,	(- '		01/1	.,	

Project Title:	TFSD Morningside Elementary School	Report date: 01/17/24
Data filename:		Page 1 of 5

LUN	MINAIRE SCHEDULE											
	OMMON NOTES: A. CATALOG NUMBER REFERS TO FIRST NAME LISE EQUIVALENT PRODUCTS FOR THIS PROJECT AND CATALOG NUMBERS DO NOT NECESSARILY REBUILDED BE REFER TO LIGHTING SPECIFICATIONS FOR ADD C. PROVIDE UNIT PRICING FOR ALL LUMINAIRES BED. PROVIDE AN EMERGENCY BALLAST TEST SWITE. PROVIDE FLICKER FREE LED DRIVERS MEETING. CIFIC REMARKS: 1. SUSPEND FIXTURES SO THE BOTTOM OF FIXTURES	ND SHALL MEE PRESENT COM VITIONAL REQU BY TYPE AND S CH FOR RECE B IEEE 1789.	ET ALL CRITERIA IPLETE CATALOG JIREMENTS. UBMIT WITH BID SSED DOWNLIGH	LISTED INCL G NUMBERS. FORM. HTS ON CEILIN	UDING THAT CALI ALL ITEMS LISTEI NG ADJACENT TO	LED FOR BY THE D IN THE DESCR	SPECIFIC LUMINA	IRE CATALOG NUMBER.				
		L/	MP		BALLAST/DRIVE	:R	APPARENT					
TYPE	DESCRIPTION	COLOR	LUMENS	TYPE	DIM LEVEL	VOLTAGE	LOAD	MANUFACTURER	CATALOG SERIES	FINISH	MOUNTING	REMARKS
L1	4'LX2"W RECESSED MOUNTED LINEAR, DIRECT HIGH-EFFICIENCY LAMBERTIAN OPTIC, FLUSH LENS, STATIC WHITE, 80 CRI	3500K	200L/FT	0-10V	1%	120 V	6 VA	LUMENWERX FINELITE	VIA2R HP-2-R	WHITE	RECESSED	
L2	4'LX2"W SUSPENDED LINEAR, DIRECT HIGH-EFFICIENCY LAMBERTIAN OPTIC, INDIRECT WIDESPREAD OPTIC, FLUSH LENS, STATIC WHITE, 80 CRI	3500K	350L/FT D 200L/FT ID	0-10V	1%	120 V	17 VA	LUMENWERX FINELITE	VIA2P HP-2-P	WHITE	SUSPENDED	1

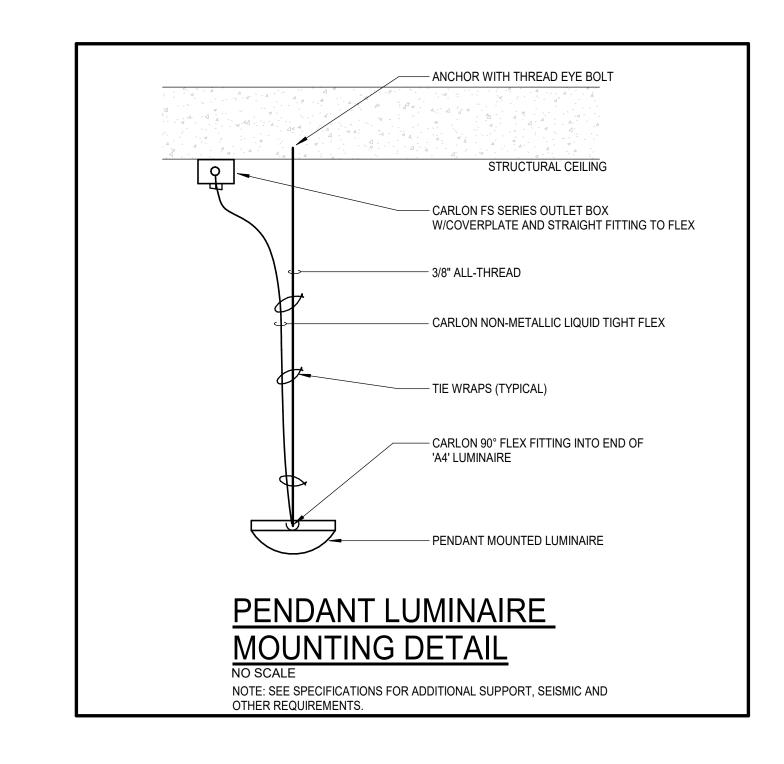





Project:
TFSD 2023 CAPITAL IMPROVEMENTS PACKAGE 3, HALLWAY (CEILING)
IMPROVEMENTS AT MORNINGSIDE
ELEMENTARY SCHOOL
600 Harrison St.
Twin Falls, ID 83301

ELECTRICAL LEGENDS, SCHEDULES & NOTES



Project No:
Drawn By:

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Drawn By:
Checked By:
Date: 01/1

Sheet No:

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