

PROJECT:

TFSD 2023 CAPITAL IMPROVEMENTS PACKAGE 6, SUPPORT SERVICE CLASSROOM TENANT IMPROVEMENT AT ROBERT STUART MIDDLE SCHOOL

644 Casewell Ave W
Twin Falls, ID 83301

CLIENT:

TWIN FALLS SCHOOL DISTRICT #411

201 Main Ave W
Twin Falls, ID 83301

VICINITY MAP :

H.A. - JOB # 23010-00



HUMMEL ARCHITECTS

205 N. 10th Street, Suite 300, Boise, Idaho 83702, 208.343.7523
 482 Constitution Way, Suite 111, Boise, Idaho 83702, 208.343.7523
 hummelarch.com

CONSULTANTS:

MECHANICAL/ELECTRICAL ENGINEER
CATOR RUMA

A : #1238, 420 S Orchard St, Boise, ID 83705
P : 208.343.3663

DRAWING SET:

ARCHITECTURAL
MECHANICAL
PLUMBING
ELECTRICAL

- GENERAL
 - G0.00 COVER SHEET
 - G0.01 DRAWING INFORMATION
 - G0.02 ACCESSIBILITY COMPLIANCE
- ARCHITECTURAL
 - A2.01 SUPPORT SERVICE CLASSROOM TI - PLANS
 - A2.02 SUPPORT SERVICE CLASSROOM TI - DOORS & FINISHES
- MECHANICAL
 - M0.01 MECHANICAL LEGENDS, NOTES & SCHEDULES
 - M2.01 LEVEL 1 HVAC PLANS
 - M2.11 LEVEL 1 HVAC PIPING PLANS
- PLUMBING
 - P0.01 PLUMBING LEGENDS, NOTES & SCHEDULES
 - P2.01 LEVEL 1 DOMESTIC WATER PLANS
 - P2.11 LEVEL 1 WASTE & VENT PLANS
- ELECTRICAL
 - E0.01 ELECTRICAL LEGENDS, DETAILS & NOTES
 - E0.02 ELECTRICAL SCHEDULES
 - E2.01 LEVEL 1 LIGHTING PLANS
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 - E3.01 ELECTRICAL DETAILS
 - E4.01 ELECTRICAL PANEL SCHEDULES

PERMIT SET

DRAWING SET NO.



SYMBOLS:

Table of symbols for keynotes, reference tags, accessory tags, grid level heads, wall type tags, window tags, door tags, room tags, case work tags, wall sections, building sections, detail or enlarged plan callouts, interior elevations, level names, and view titles.

MASTER KEYNOTES:

Table of keynotes with keynotes # and keynotes text, listing materials like cast-in-place concrete, dimension lumber, plastic laminate, etc.

ABBREVIATIONS:

Table of abbreviations for various construction materials and components, including anchors, acoustic panels, masonry, concrete, and structural elements.

WALL TYPES:

Table of wall types (W4, W6, W68) showing fire ratings, fire tests, wall heights, and exterior/interior details.

APPLICABLE CODES:

- List of applicable codes including 2017 National Electrical Code, 2017 Idaho State Plumbing Code, 2018 International Building Code, etc.

Robert Stuart Middle School


Project Description: An addition of a security vestibule, remodel of the adjacent Administration area and remodel of two classrooms.

Existing School Area A: Occupancy Type: E, Construction Type: V-A (Non-sprinklered), Actual Area = 77,570 sqft.

Existing School Area B: Occupancy Type: E, Construction Type: V-A (Fully Sprinklered), Allowable Area = 26,270 sqft, Actual Area = 15,200 sqft.

New Vestibule: Added Sqr: 2,700 sqft, Occupancy Type: E-U, Construction Type: V-B (Fully Sprinklered), Occupant Load: Unchanged.

LIFE SAFETY PLAN:

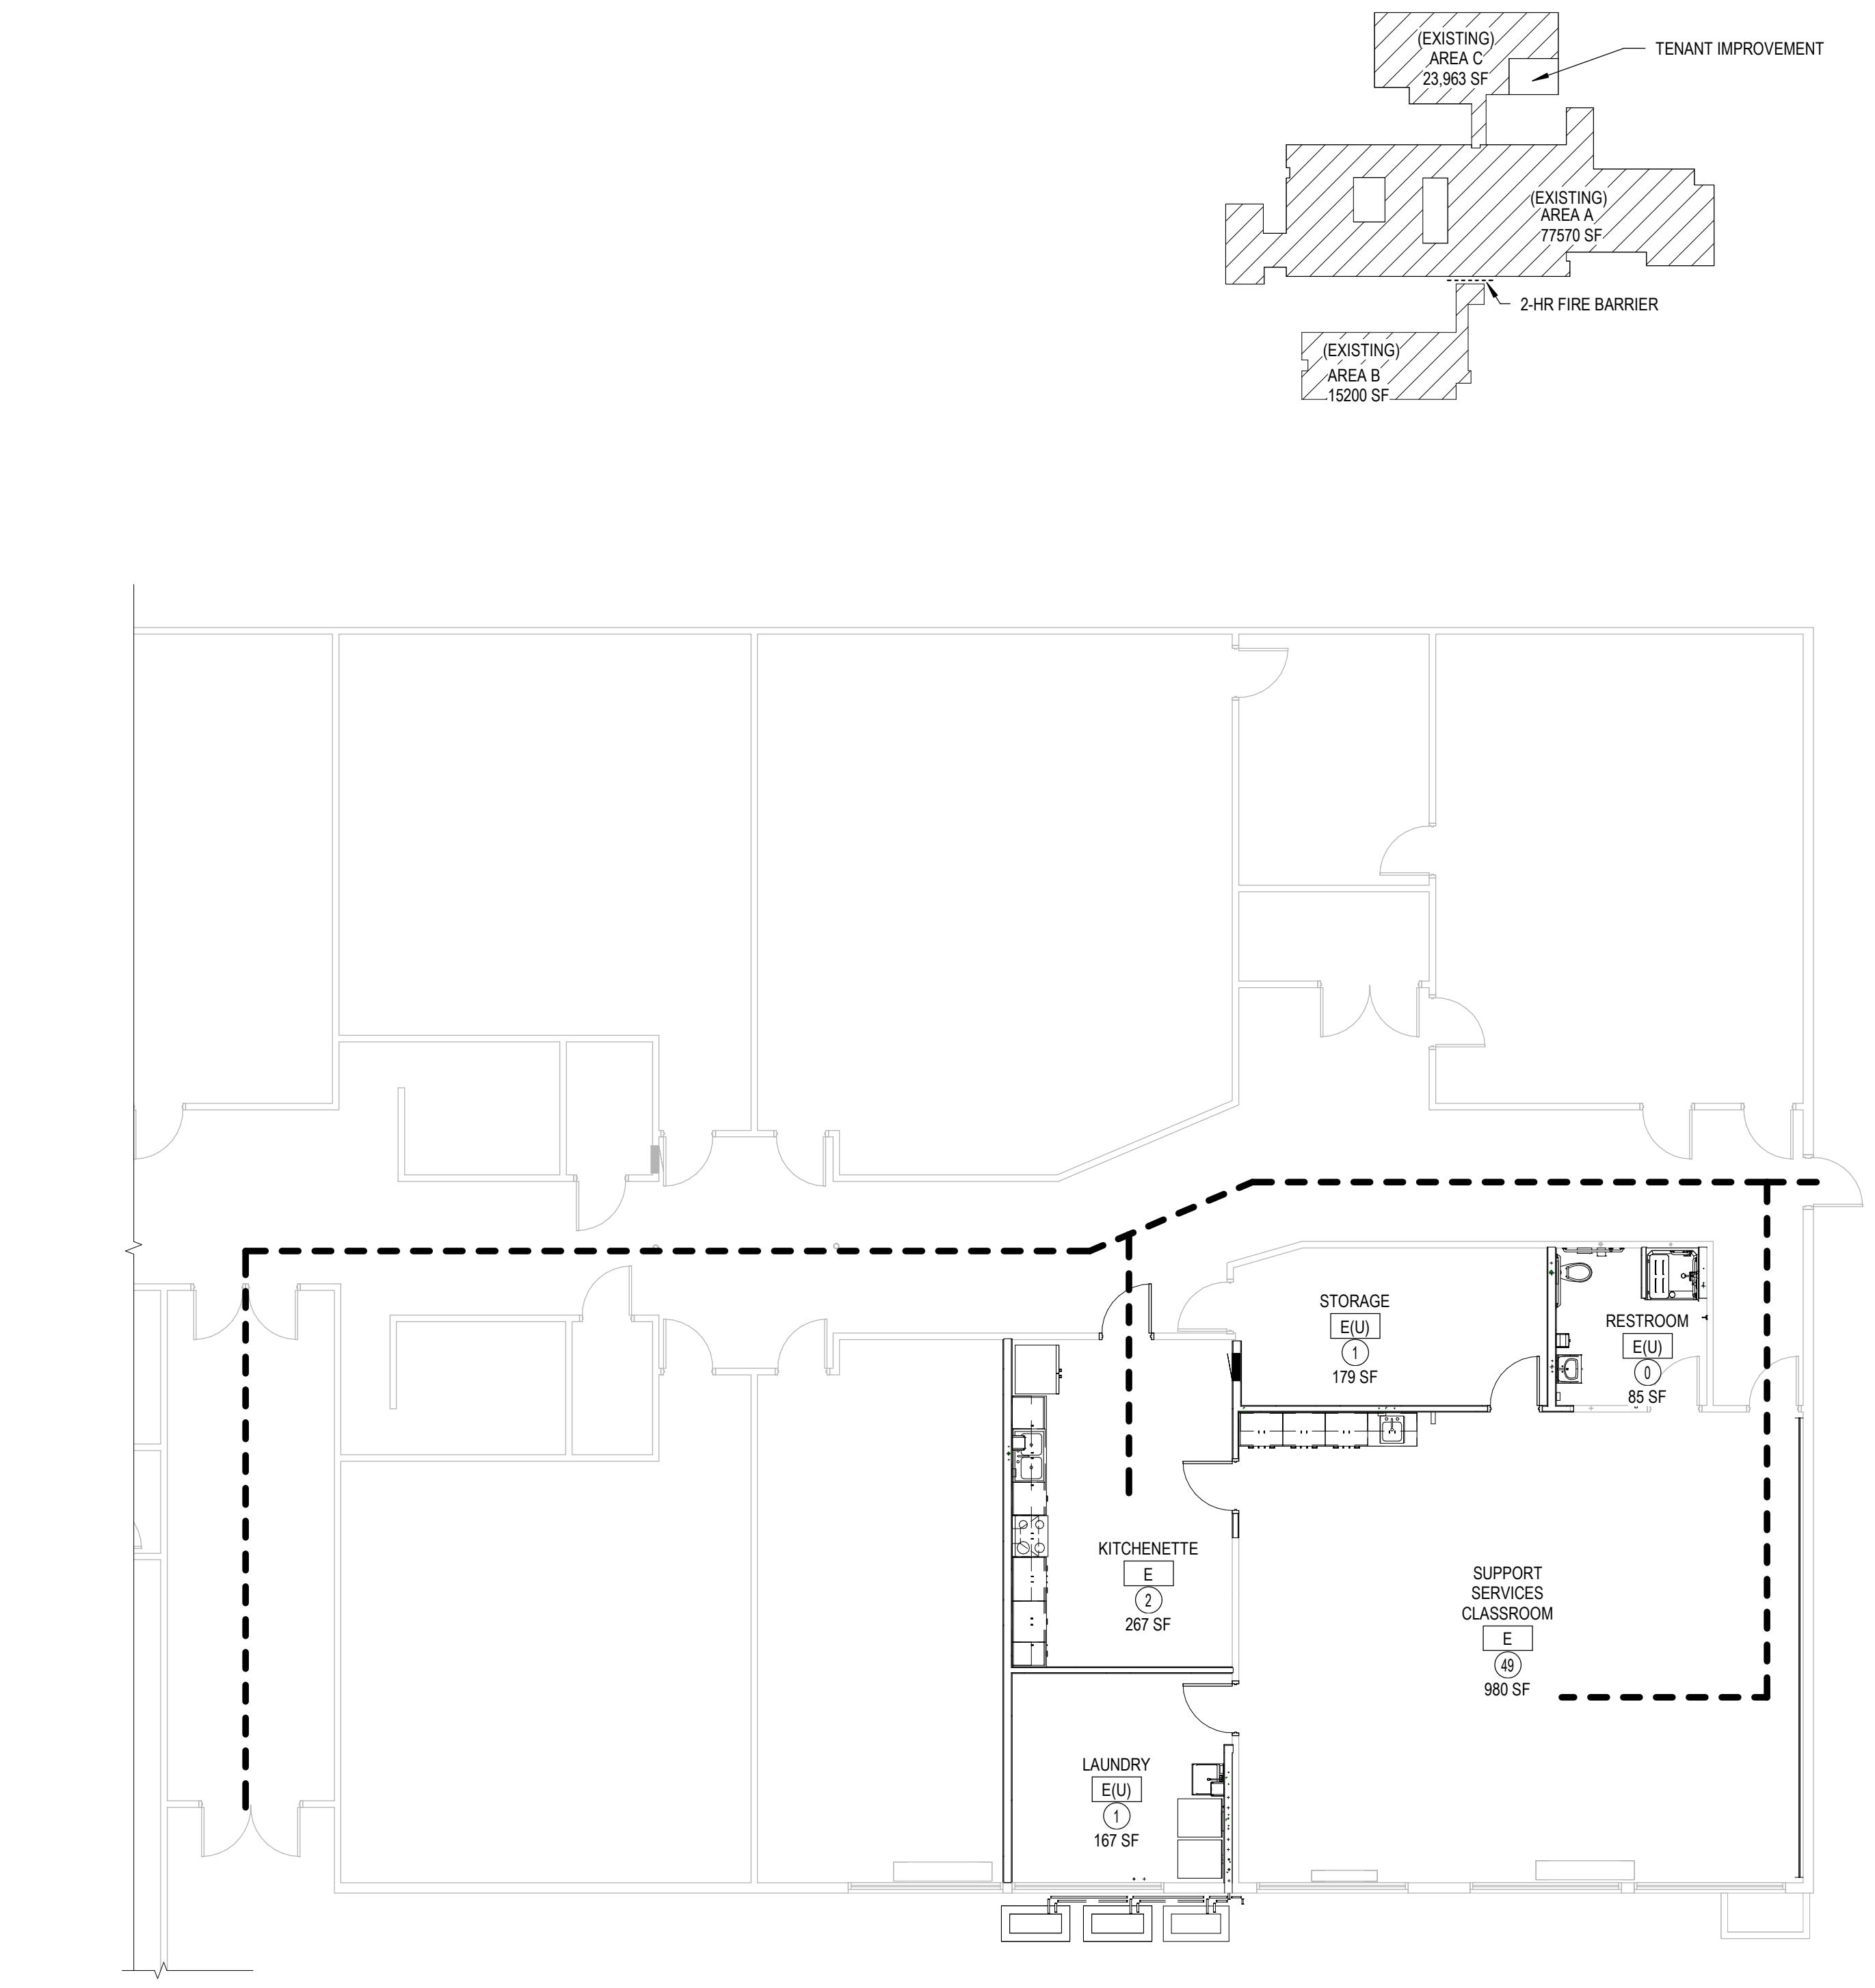

KEYNOTES

Table of keynotes for materials: 061000.A DIMENSION LUMBER, 072100.D SOUND ATTENUATION BLANKET INSULATION, 092900.D GYPSUM BOARD TYPE X.

REFERENCE NOTES

LEGEND

- Legend symbols for room names, occupancy classification, room occupant load, width of egress component, direction of exiting, occupant capacity, occupant exiting, and exiting travel distance.

HUMMEL ARCHITECTS logo and contact information: 205 N. 10th Street, Suite 300, Boise, Idaho 83702.

Project: TFSD 2023 CAPITAL IMPROVEMENTS PACKAGE 6, SUPPORT SERVICE CLASSROOM TENANT IMPROVEMENT AT ROBERT STUART MIDDLE SCHOOL, 644 Casewell Ave W, Twin Falls, ID 83301.


DRAWING INFORMATION

Table with drawing information: Agency Review 1, 2/16/2024.

Professional Engineer seal for AR-1635, State of Idaho, dated 2/16/24.














Project No: 23010-00, Drawn By: KT, Checked By: PR, Date: 2/23/2024.

Sheet No: G0.01

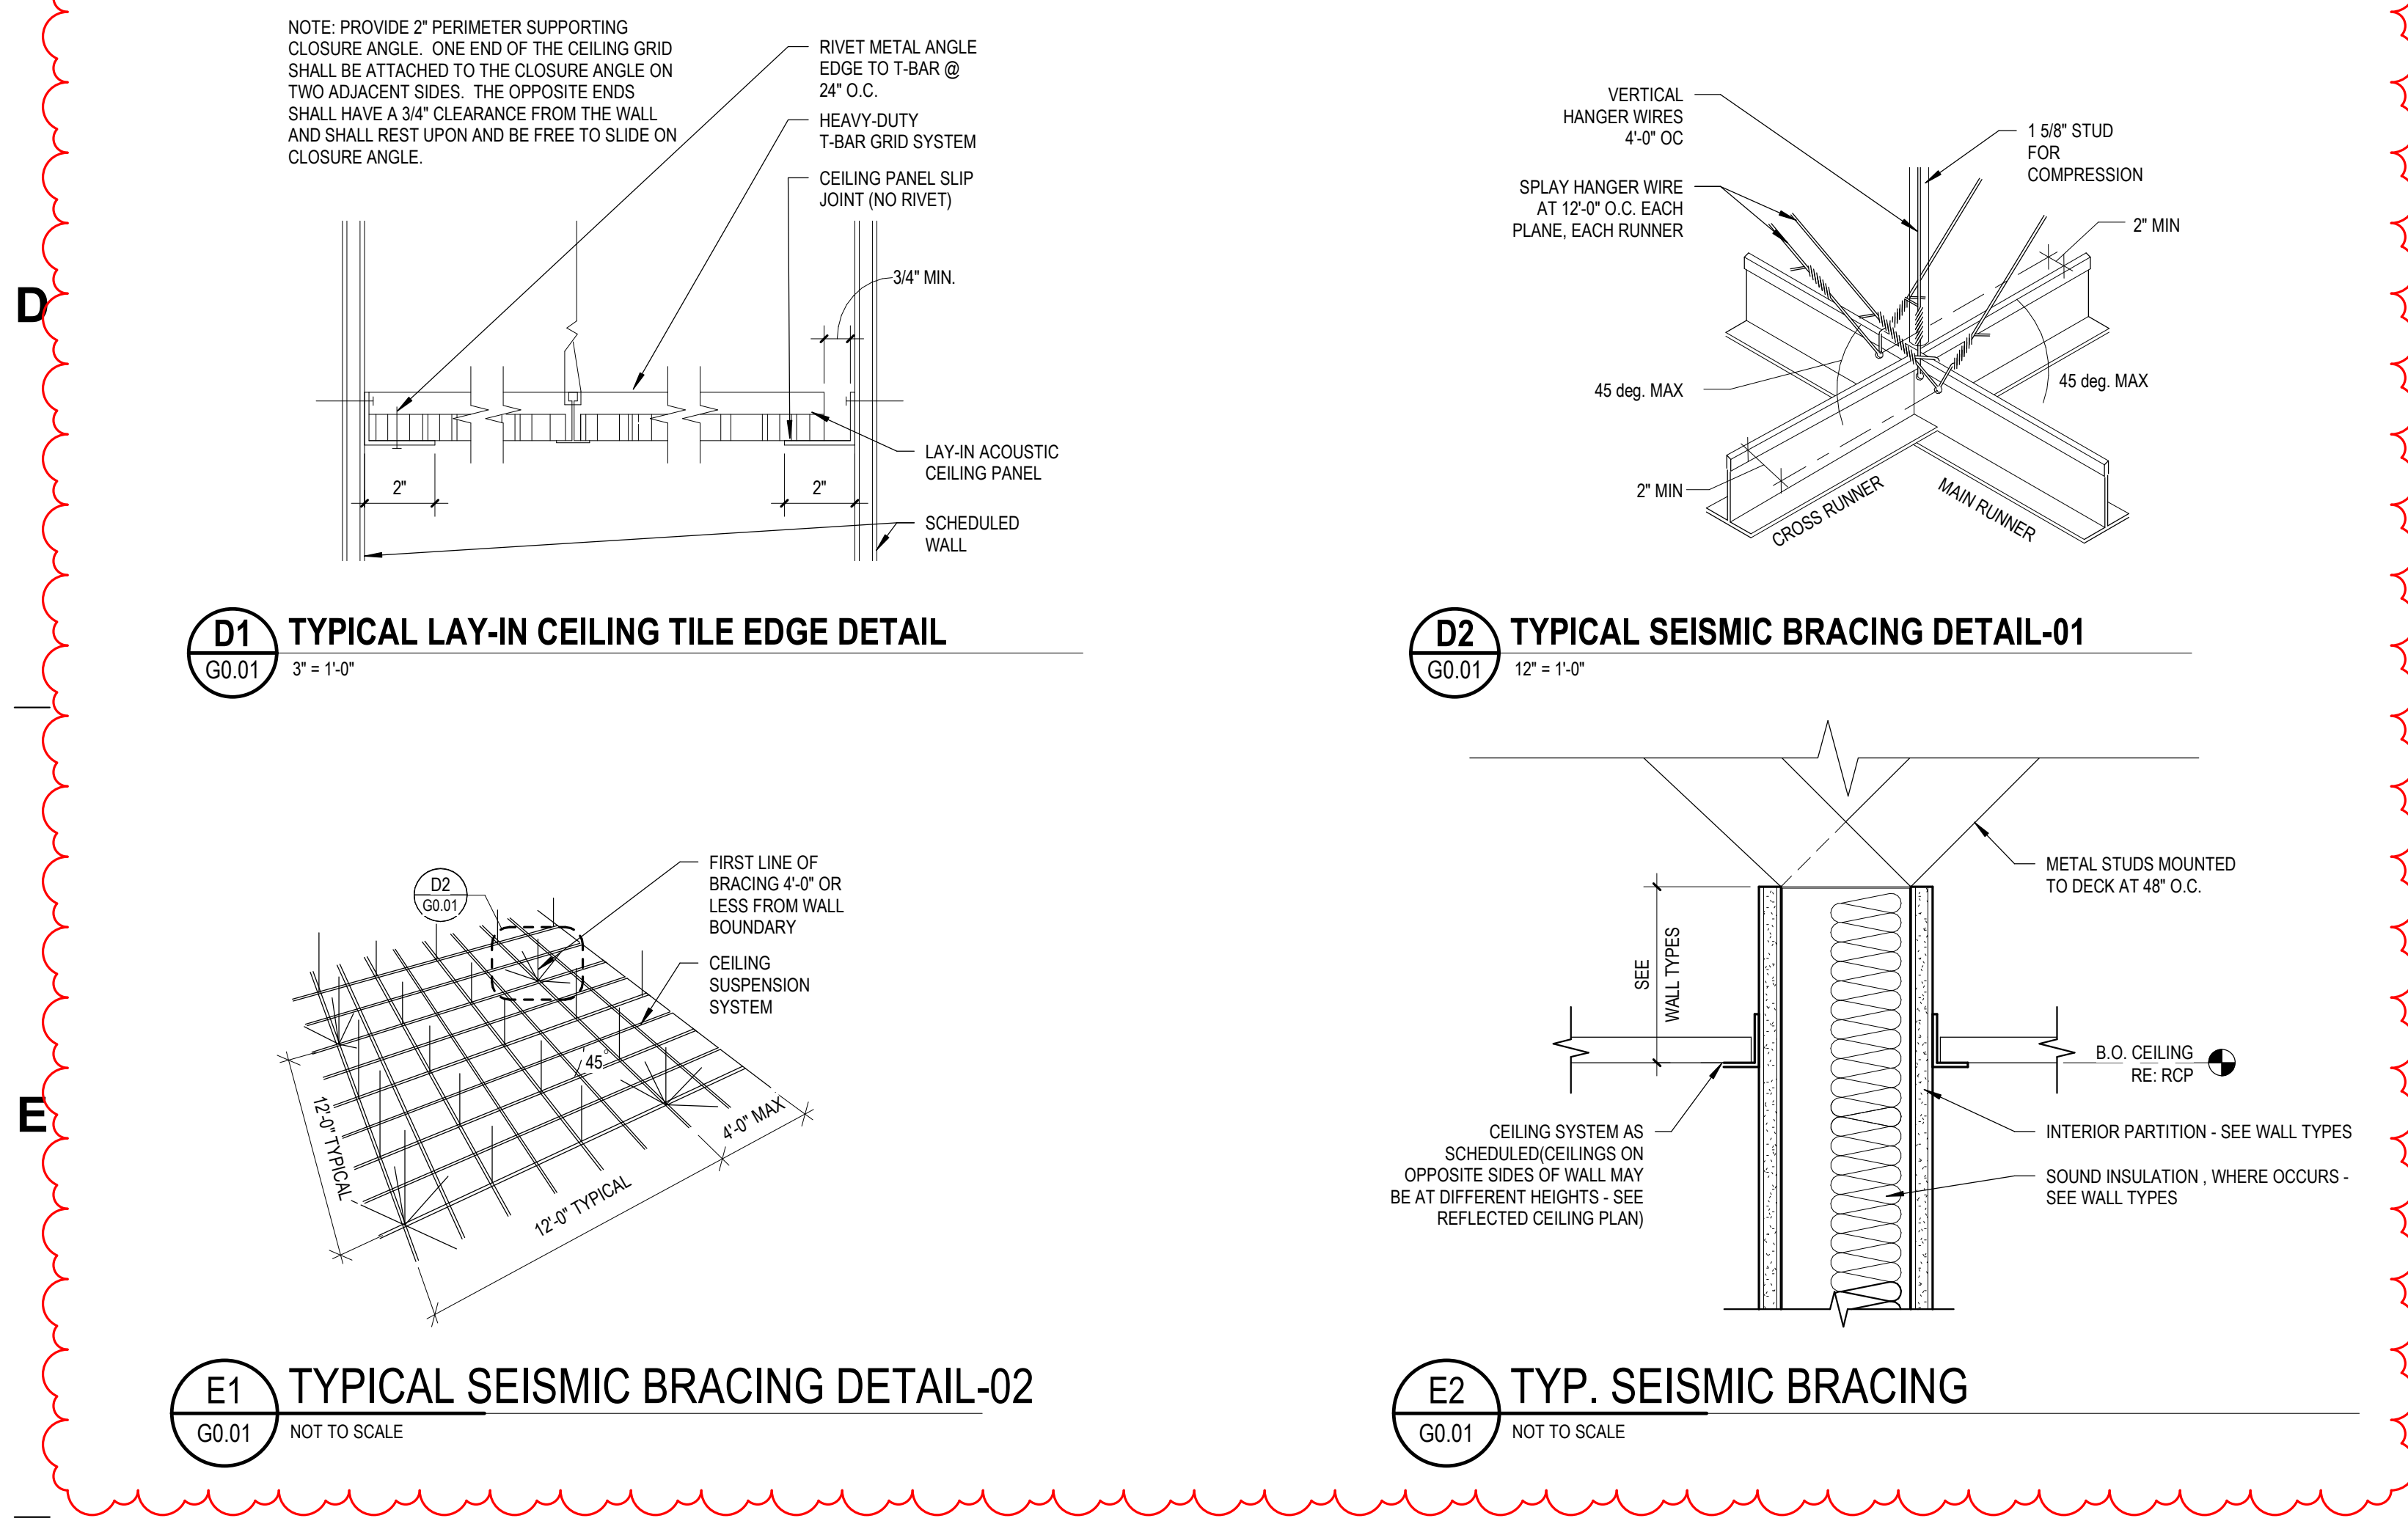

Labels for details: D1 TYPICAL LAY-IN CEILING TILE EDGE DETAIL, D2 TYPICAL SEISMIC BRACING DETAIL-01, E1 TYPICAL SEISMIC BRACING DETAIL-02, E2 TYP. SEISMIC BRACING, E6 EXITING AND OCCUPANCY PLAN.

PERMIT SET

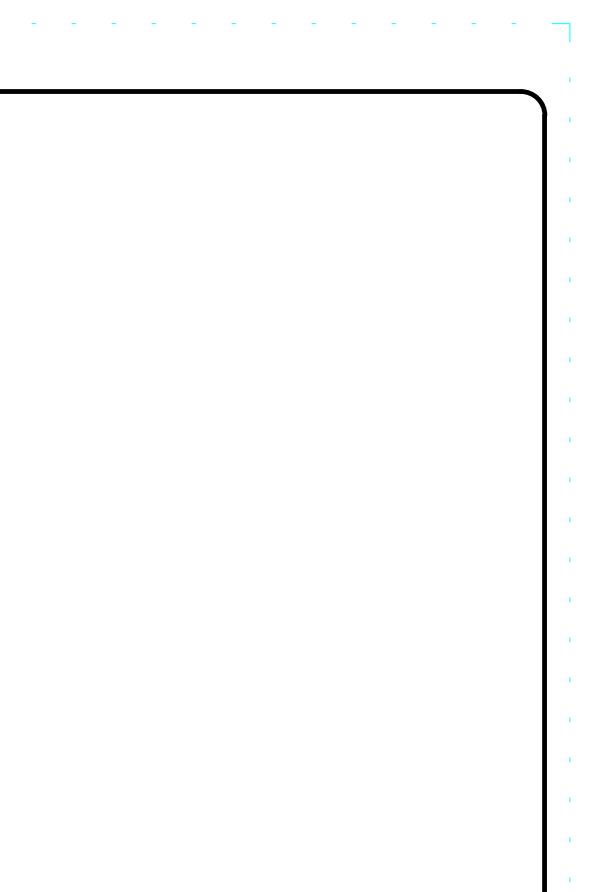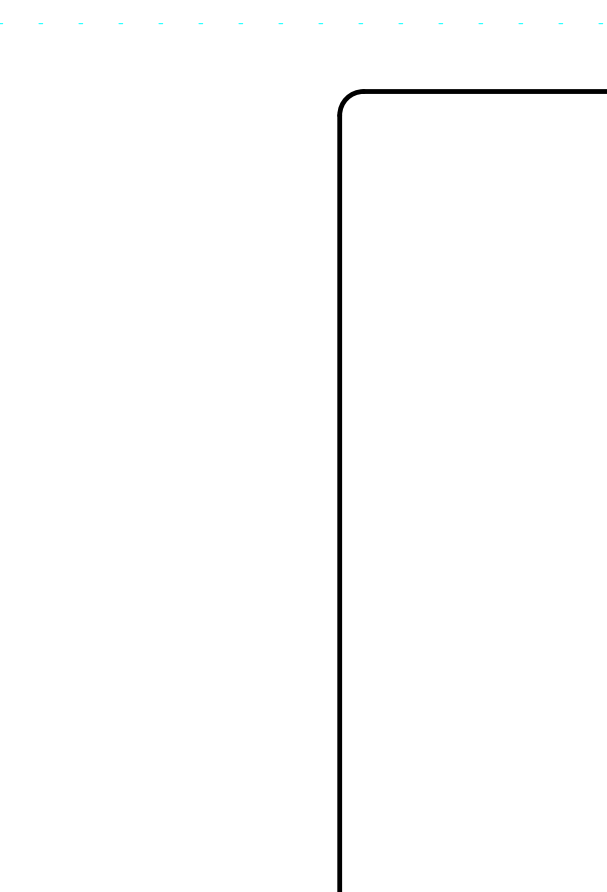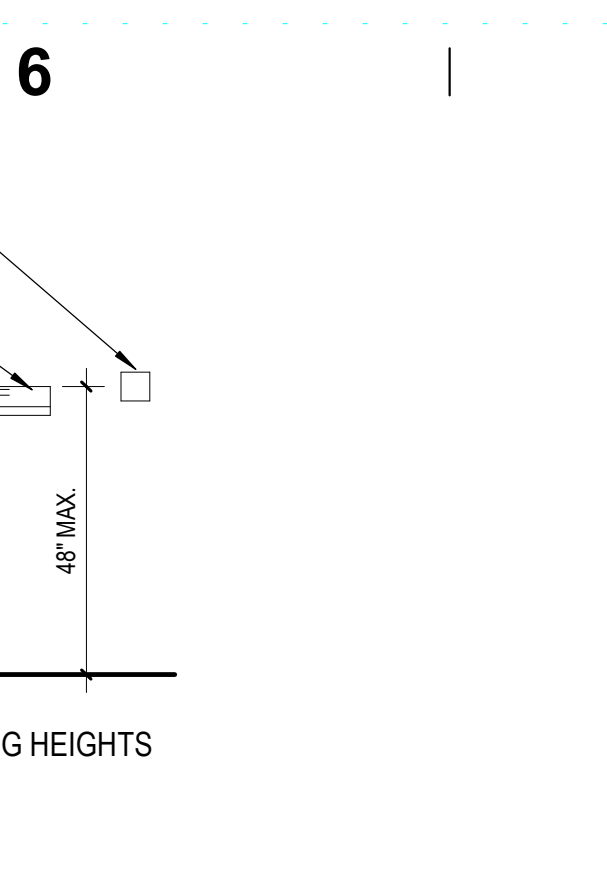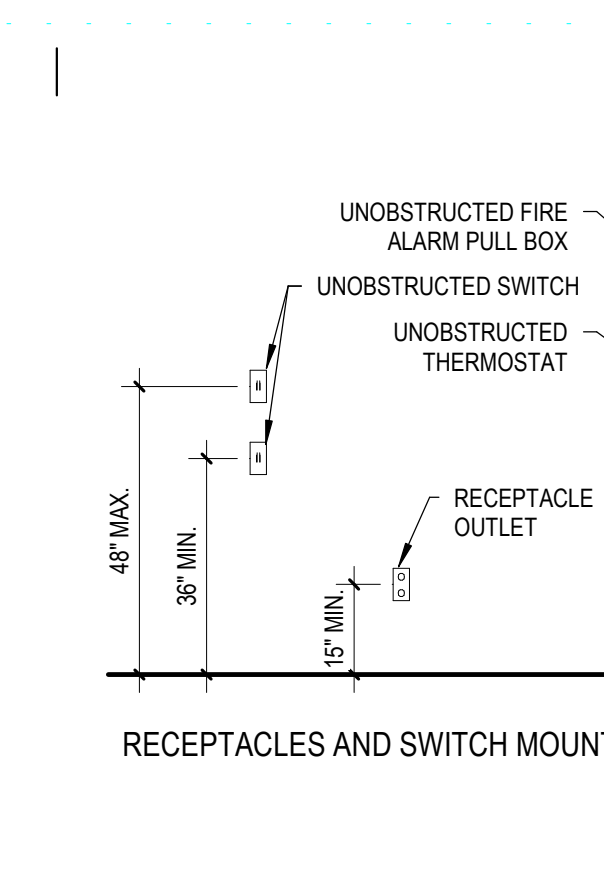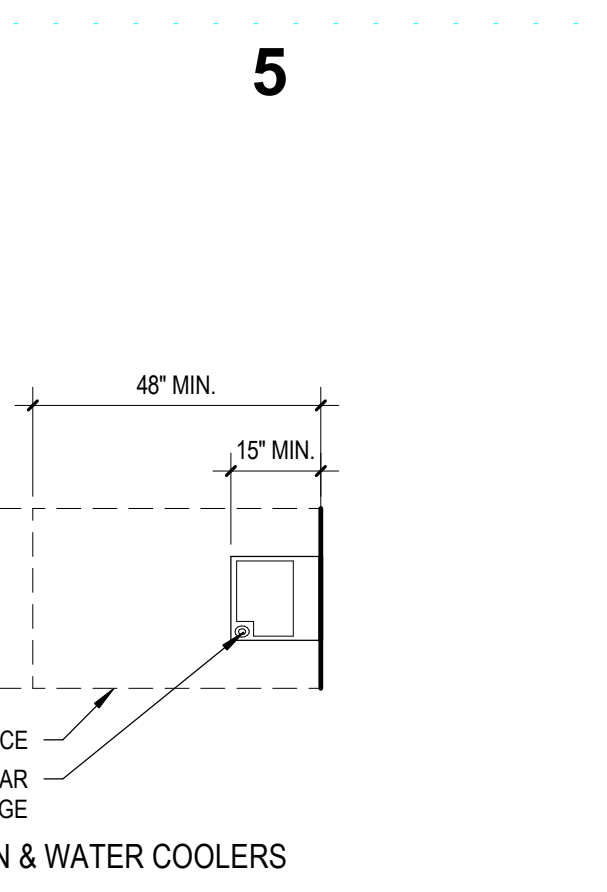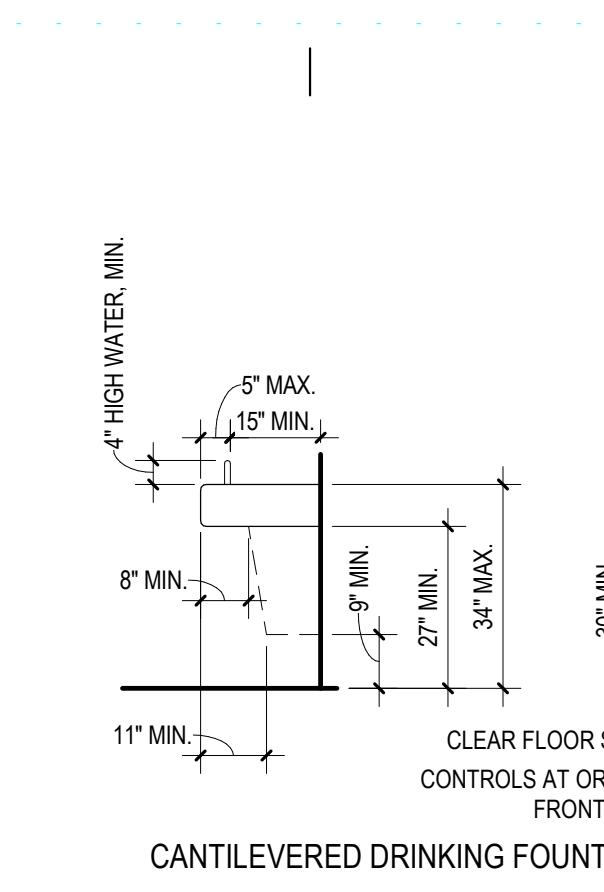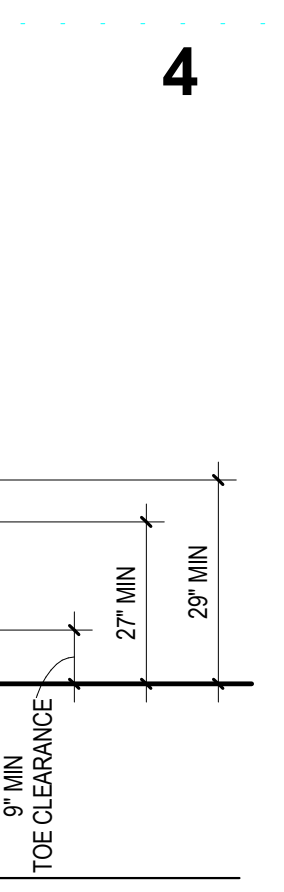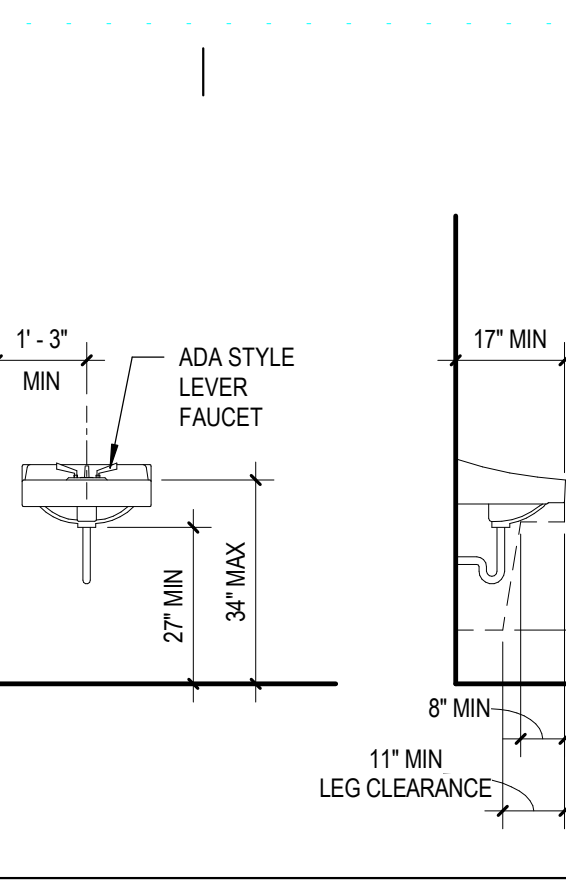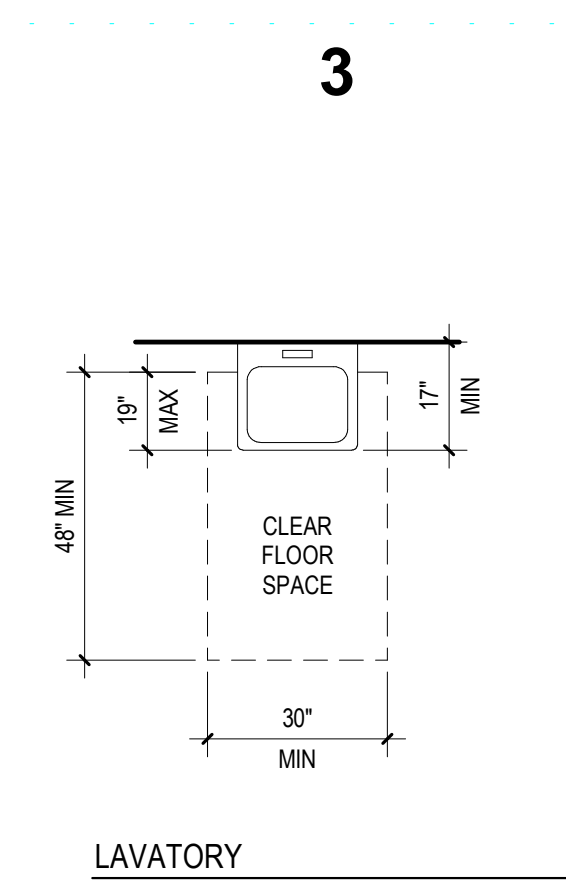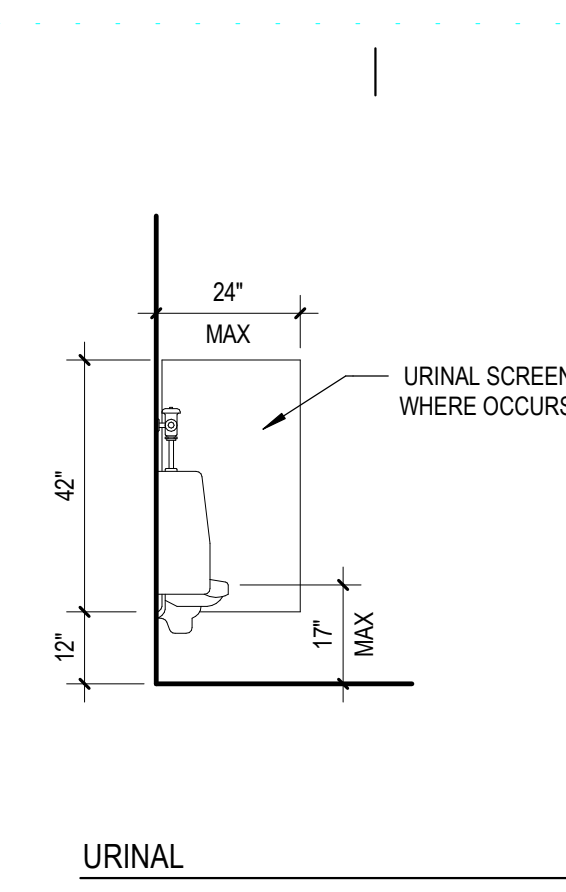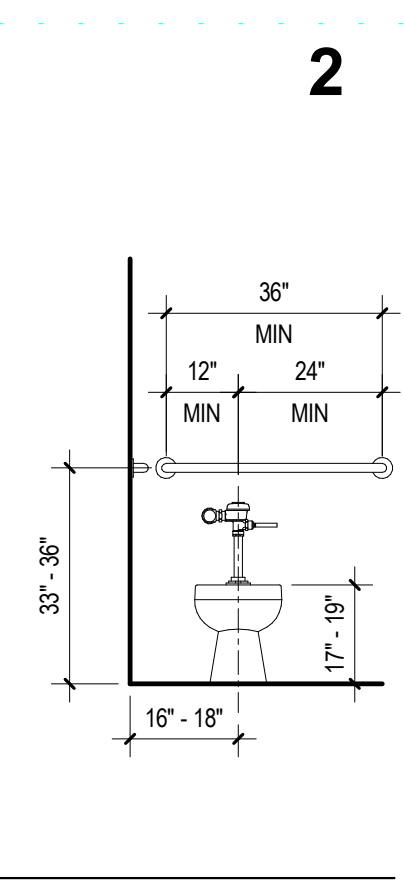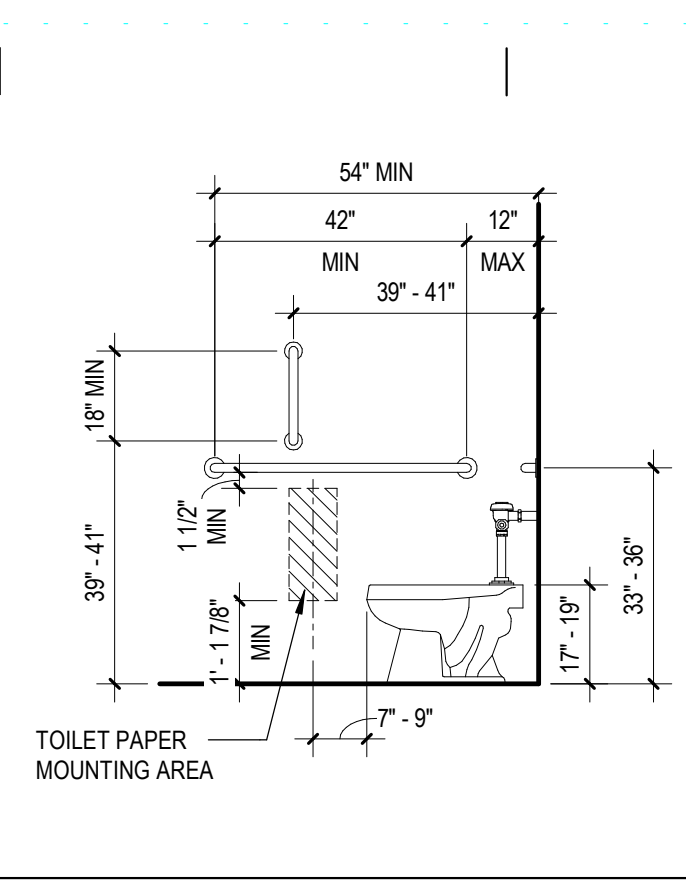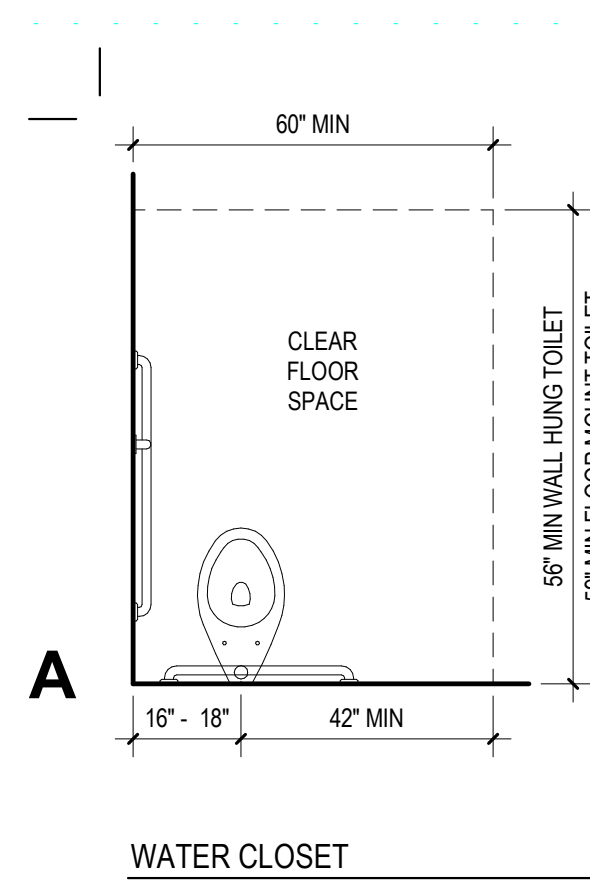

A1 ACCESSIBLE FIXTURE CLEARANCE REQUIREMENTS
G0.02 3/8" = 1'-0"

A4 DRINKING FOUNTAINS
G0.02 3/8" = 1'-0"

A6 MISC. MOUNTING HEIGHTS
G0.02 3/8" = 1'-0"

B1 TYPICAL ACCESSORIES MOUNTING HEIGHTS
G0.02 3/8" = 1'-0"

B4 RESTROOM SIGNAGE
G0.02 3/8" = 1'-0"

C1 SIGN - RESTROOM WALL
G0.02 3" = 1'-0"

C2 SIGN - TACTILE EXIT
G0.02 6" = 1'-0"

C3 SIGN - BUILDING ENTRANCE
G0.02 3" = 1'-0"


C4 RESTROOM DOOR SIGNAGE
G0.02 1 1/2" = 1'-0"

C6 CHANGE IN LEVELS
G0.02 6" = 1'-0"



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TFSD 2023 CAPITAL IMPROVEMENTS
PACKAGE 6, SUPPORT SERVICE
CLASSROOM TENANT IMPROVEMENT
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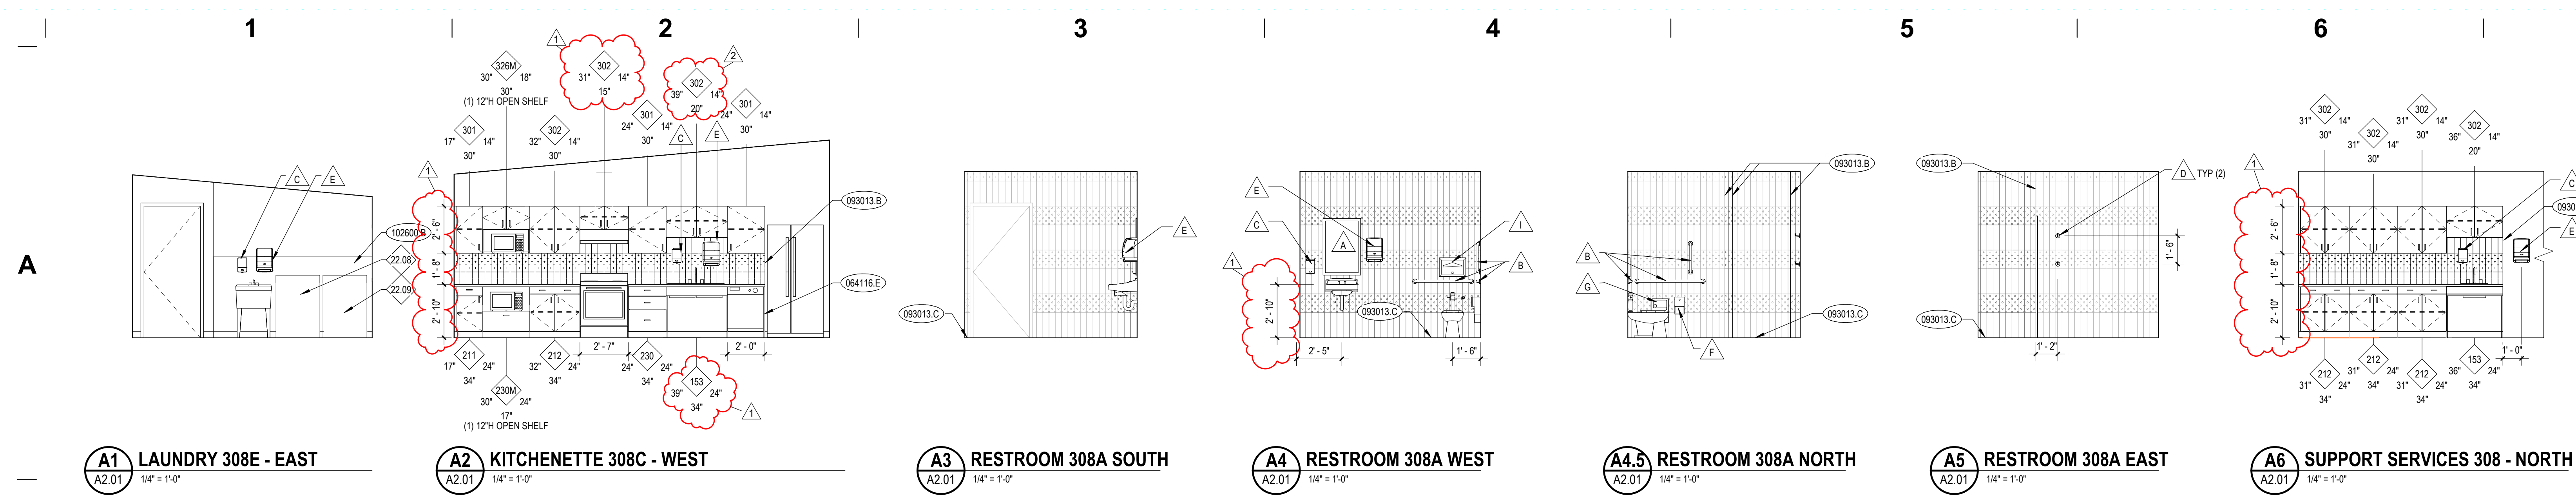
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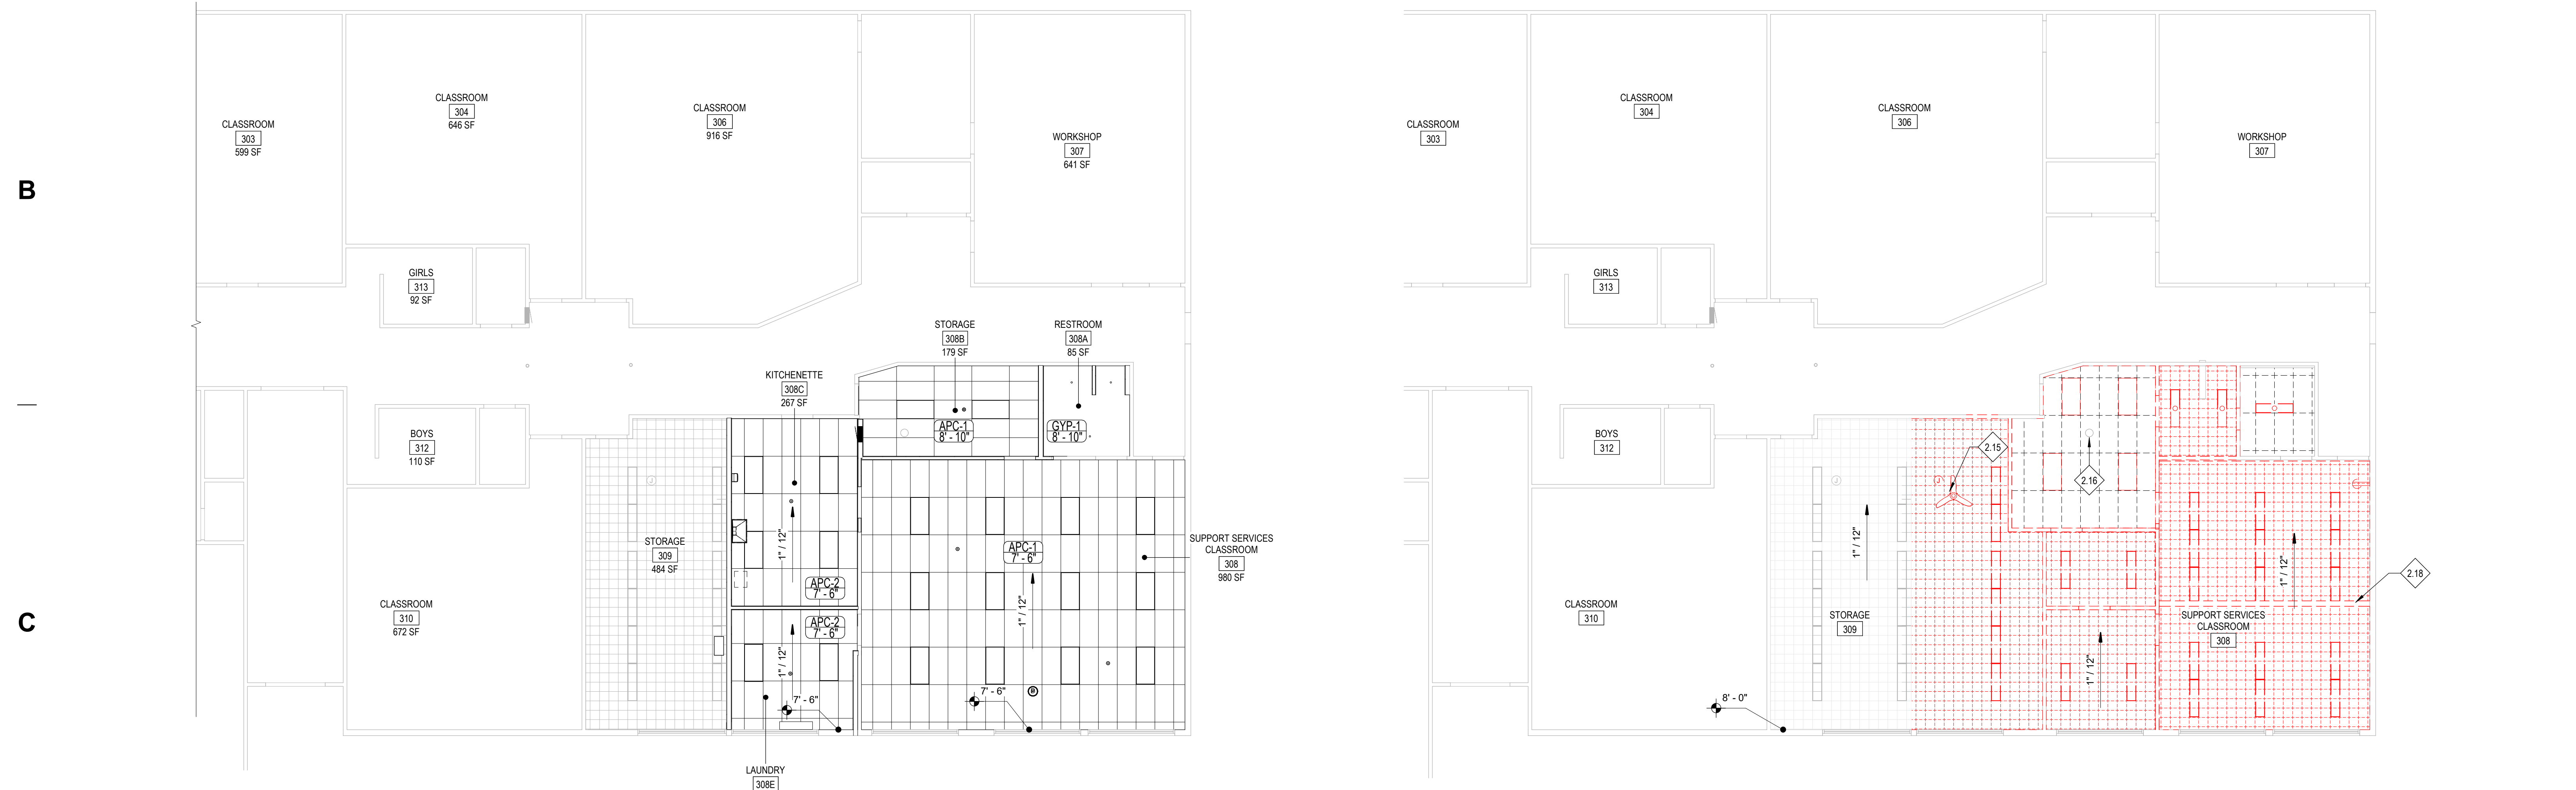
PERMIT SET

Project No: 23010-00
Drawn By: KT
Checked By: PR
Date: 2/23/2024

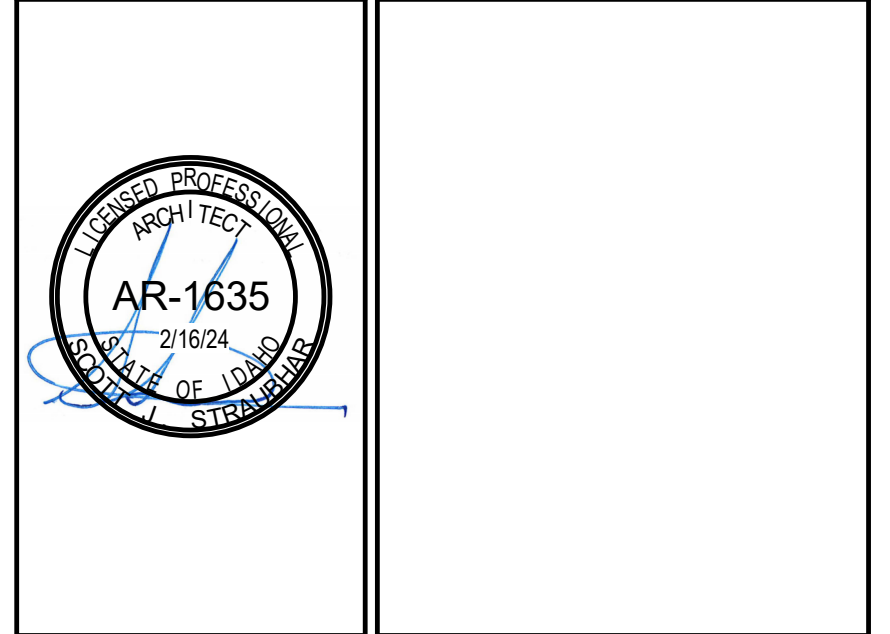Sheet No: G0.02




- ### KEYNOTES
- 054116.E PLASTIC LAMINATE END PANEL
 - 093013.B METAL EDGE STRIP ACCESSORY
 - 093013.C METAL COVE BASE
 - 102600.B FIBER REINFORCED PANEL
- ### REFERENCE NOTES
- 1.03 SEE PLUMBING DRAWINGS FOR REMOVAL OF EXISTING PLUMBING FIXTURE
 - 1.06 SEE ARCHITECTURAL AND PLUMBING PLANS FOR NEW WORK ON OTHER SIDE OF WALL. PREP TO INSTALL NEW FIXTURES
 - 1.15 ALIGN NEW WALL WITH EXISTING WALL
 - 1.16 NEW WALL TO BE CENTERED AT MULLION BETWEEN THE EXISTING WINDOWS
 - 2.05 DEMO PLYWOOD ON WALL AND CLEAN BRICK
 - 2.14 DEMO EXISTING WALL HEATER
 - 2.15 OWNER TO REMOVE EXISTING CEILING FAN
 - 2.16 REINSTALL EXISTING CEILING SPEAKER IN NEW CEILING
 - 2.18 REMOVE EXISTING BEAM THAT IS ATTACHED TO THE WALLS
 - 2.27 SAW OUT AS NECESSARY TO CONNECT NEW PLUMBING
 - 2.28 EXISTING WINDOW AC UNIT
 - 2.29 EXISTING RADIANT HEATER
 - 2.30 REMOVE SCREWS THAT ARE PREVENTING WINDOWS FROM OPERATING AND RESTORE WINDOWS TO AN OPERABLE STATUS
 - 2.44 DEMOLISH EXISTING CABINETS, COUNTER TOP AND UPPER CABINETS
 - 3.04 CONTRACTOR TO PATCH EXISTING CONCRETE FLOOR AFTER REMOVAL OF PLUMBING ITEMS FOR A FLUSH FINISH. TO INSTALL NEW FLOORING.
 - 22.08 O.F.I. WASHER
 - 22.09 O.F.I. DRYER



- ### FINISH WALL LEGEND
- CWT-1 [Pattern]
 - CWT-2 [Pattern]
 - CWT-3 [Pattern]
- ### GENERAL NOTES
1. UNLESS NOTED OTHERWISE, ALL DIMENSIONS ARE TO THE FACE OF STUDS FOR GWB WALLS / PARTITIONS.
 2. DIMENSIONS CALLED OUT AS "CLEAR" INDICATE A MEASUREMENT FROM FACE OF FINISH.
 3. UNLESS NOTED OTHERWISE, ALL INTERIOR PARTITION WALLS ARE WALL TYPE: WK. REFER TO WALL ASSEMBLY SHEET.
 4. FOR ROOM FINISH SCHEDULE AND FINISH PLANS, RE: SHEETS A2.02
 5. UNLESS NOTED OTHERWISE ALL GWB WALLS SHALL HAVE A 6" STUD FRAME RETURN AT ALL DOOR AND WINDOW JAMS.
 6. COORDINATE WITH MECHANICAL AND ELECTRICAL DRAWINGS FOR LOCATION AND NUMBER OF OTHER ROOF PENETRATIONS (I.E. VENT STACKS, VENT PIPES, CONDUIT PENETRATIONS, ETC.). FLASH ALL PENETRATIONS WEATHER TIGHT. COORDINATE WITH ROOF DETAILS.
 7. ALL METAL ROOF FLASHING DETAILS SHALL BE PER MANUFACTURERS' RECOMMENDATIONS AND REVIEWED BY THE ARCHITECT FOR DESIGN INTENT.
 8. SEE G0.01 FOR CEILING DETAILS

- ### LEGEND
- [Symbol] TOILET AND BATH ACCESSORY, RE: SHEET G0.02
 - [Symbol] DOOR SYMBOL, RE: DOOR SCHEDULE, SHEET A7.01
 - [Symbol] WALL TYPE, RE: SHEET G0.01
 - [Symbol] WINDOW TYPE, RE: WINDOW FRAME TYPE SHEETS, SHEET A7.01
 - [Symbol] FIRE EXTINGUISHER CABINET, RE: DIVISION 10 - SPECIALTIES 10 AND SHEET A6.91
 - [Symbol] FLOOR DRAIN, COORDINATE WITH PLUMBING DRAWINGS.
 - [Symbol] WOOD/STEEL STUD WALL AND GYPSUM BOARD WALL, RE: WALL TYPES.

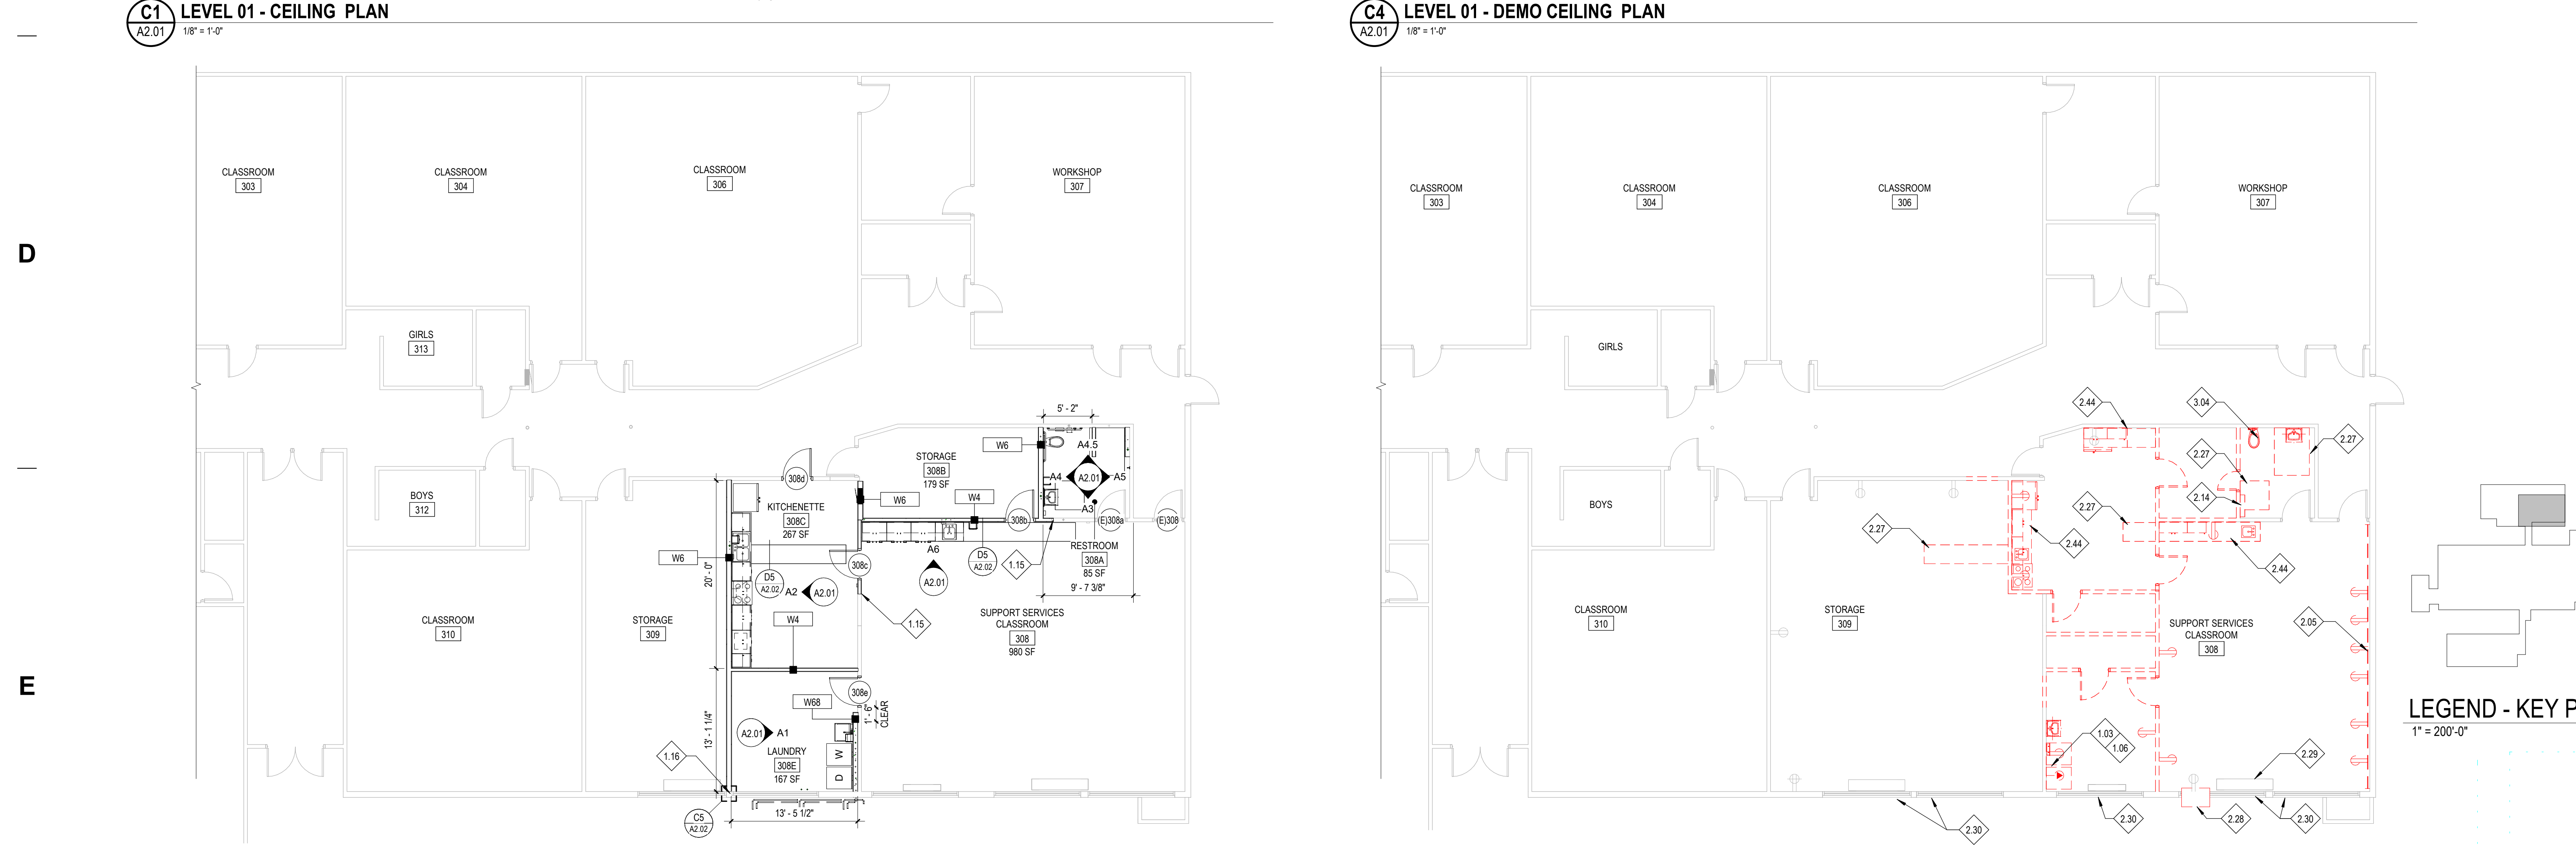

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Sheet:
SUPPORT SERVICE
CLASSROOM TI - PLANS

1	Agency Review 1	2/16/2024
2	Consolidated Set	2/23/2024


PERMIT SET

Project No: 23010-00
Drawn By: KT
Checked By: PR
Date: 2/23/2024

Sheet No: **A2.01**

SCHEDULE - ROOM FINISH												
ROOM NO.	ROOM TITLE	FLOOR		WALLS				CASEWORK		CEILING FINISH	REMARKS	
		MAT.	BASE	NORTH	EAST	SOUTH	WEST	CABINETRY	COUNTER TOP			
308	SUPPORT SERVICES CLASSROOM	CPT-1	RWB-1	P-6, CWT-1, CWT-2	P-6	P-6	P-6	P-6	PL-1	PL-2	-	2, 4
308A	RESTROOM	PFT-1, CFT-1	MCB-1	CWT-1, CWT-2, CWT-3	CWT-1, CWT-2, CWT-3	CWT-1, CWT-2, CWT-3	CWT-1, CWT-2, CWT-3	-	-	-	P-9	2, 3, 4
308B	STORAGE	LVT-1	RWB-1	P-1	P-1	P-1	P-1	-	-	-	-	-
308C	KITCHENETTE	LVT-1	RWB-1	P-1	P-1	P-1	P-1, CWT-1, CWT-2	PL-1	PL-2	-	-	2, 4
308E	LAUNDRY	LVT-1	RWB-1	P-1	P-1, FRP-1	P-1	P-1	-	-	-	-	1

A

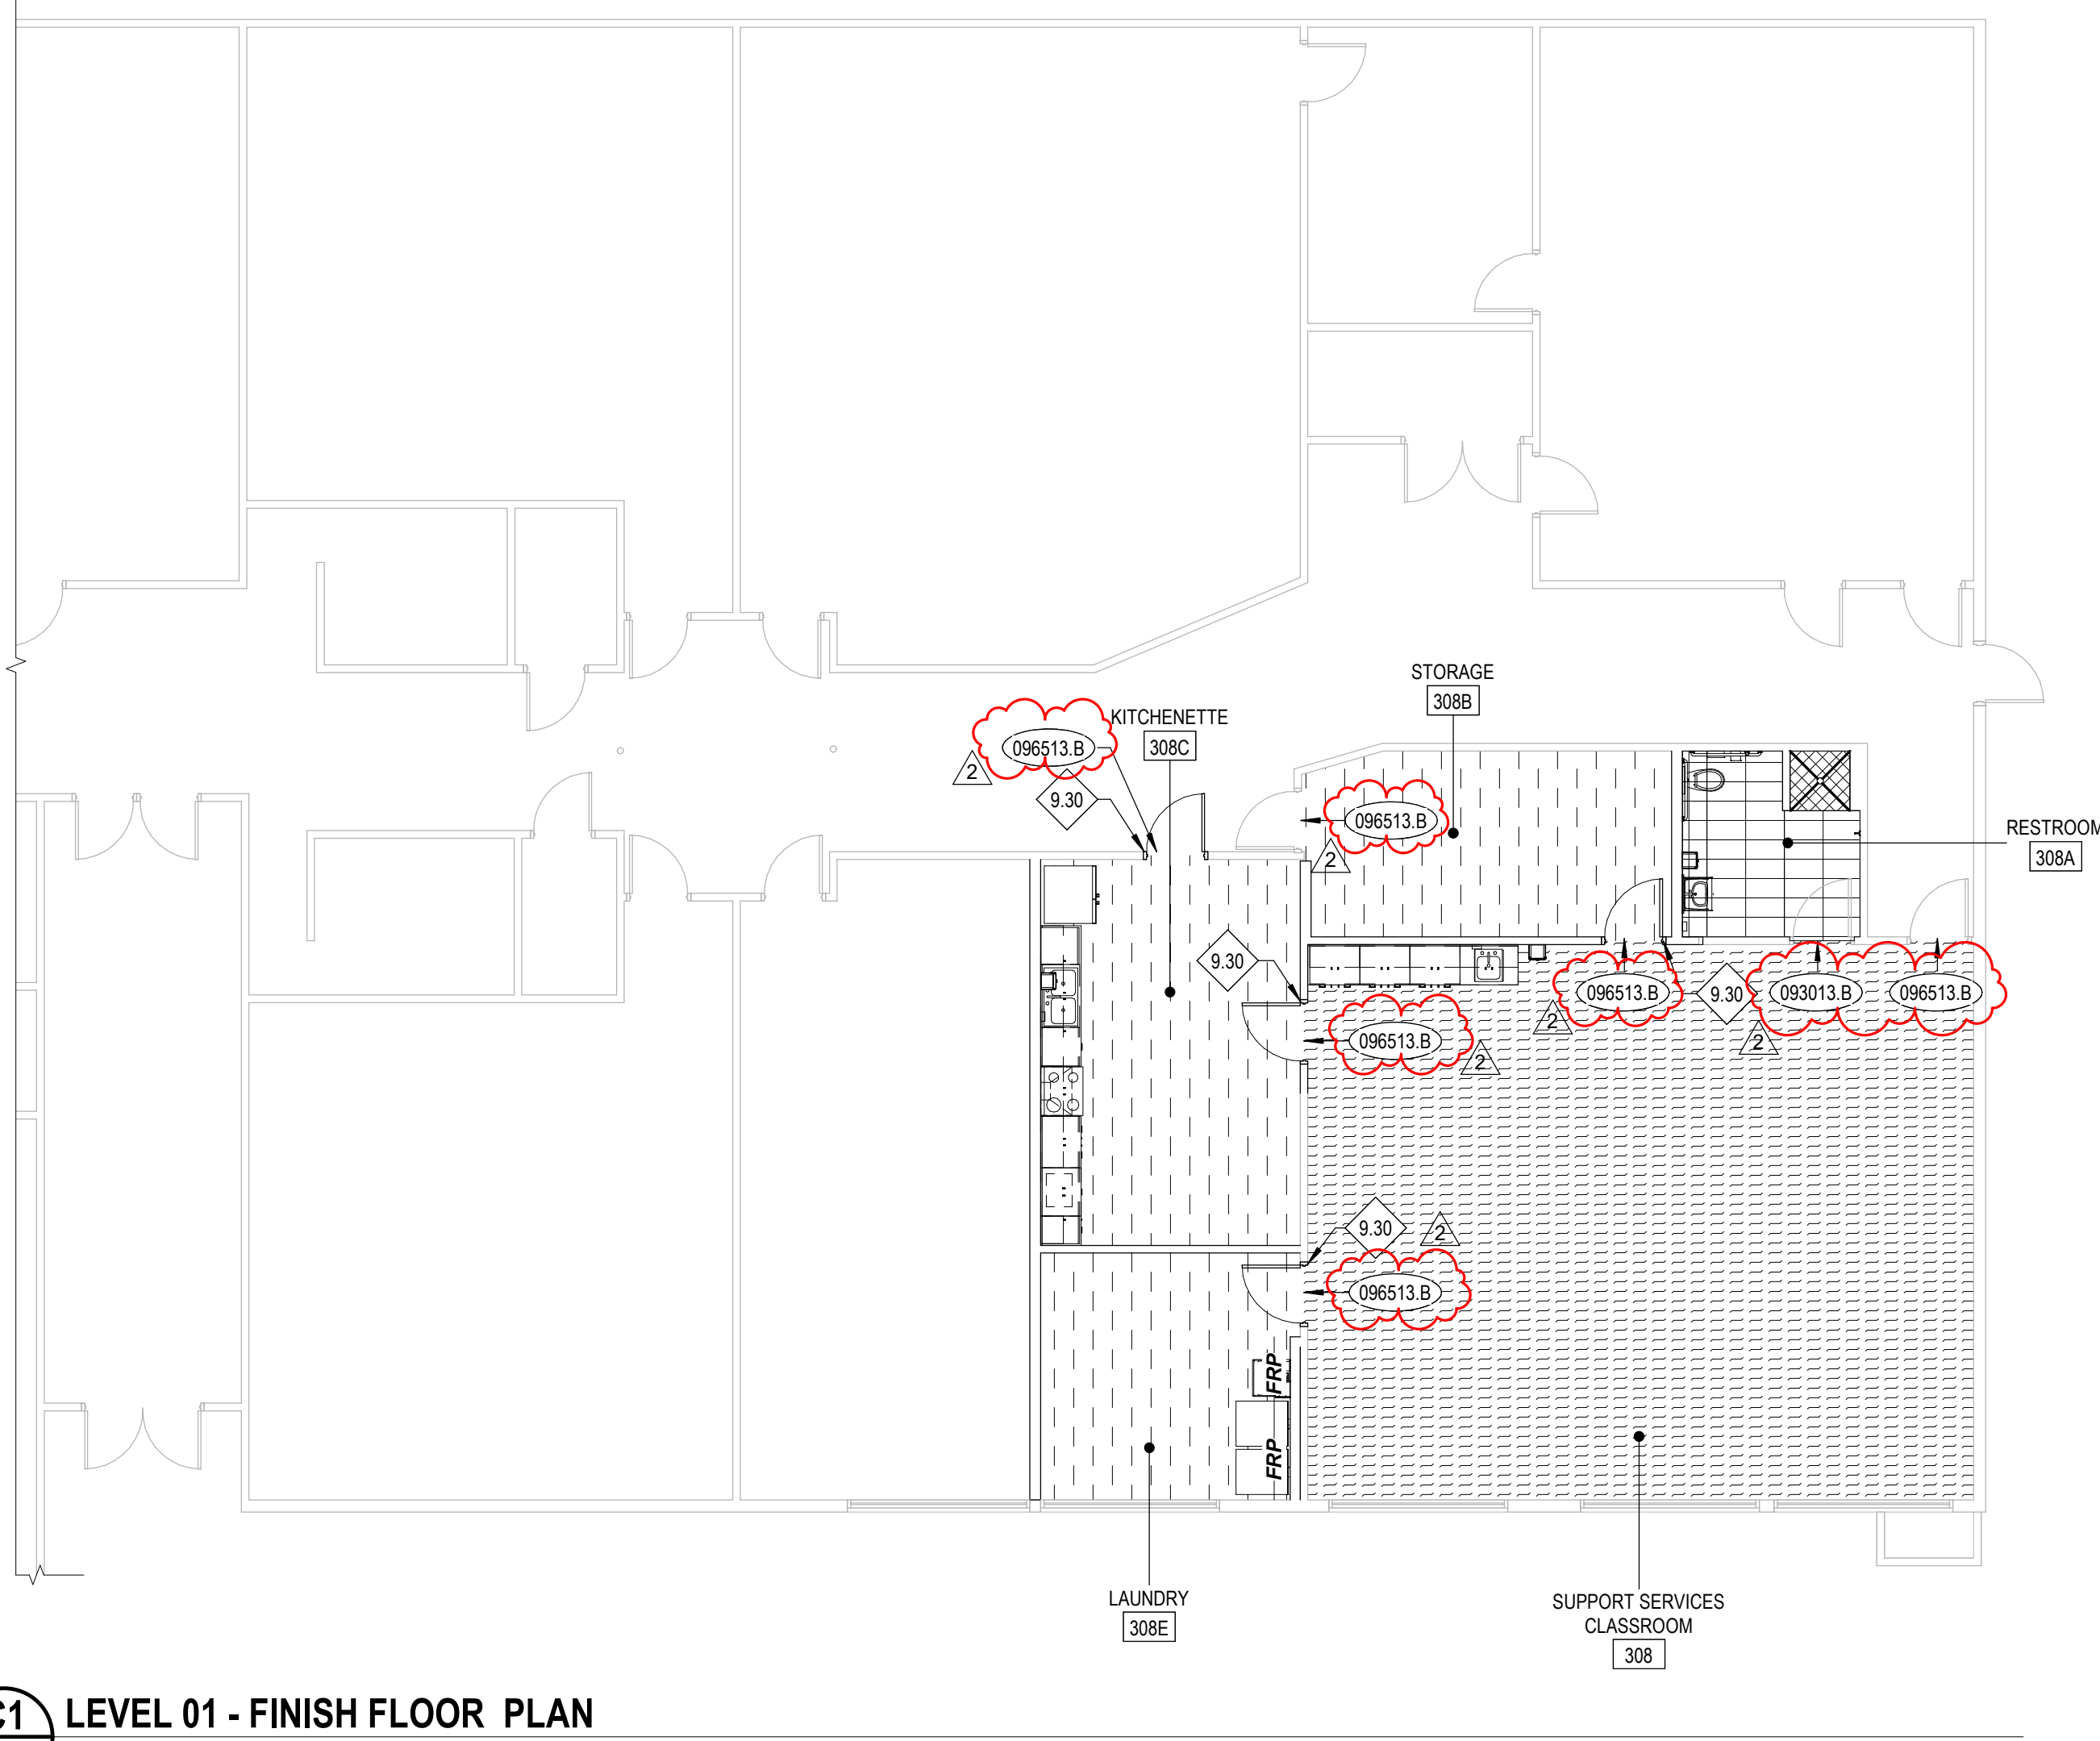

C1 LEVEL 01 - FINISH FLOOR PLAN
 A2.02 1/8" = 1'-0"

B

C


D

E



SCHEDULE - DOOR												
DOOR #	TYPE	WIDTH	HEIGHT	DOOR			FRAME			Fire Rating	DOOR HARDWARE	REMARKS
				MATERIAL	FINISH	EXIST	MATERIAL	FINISH	EXIST			
(E)308	F	3'-0"	7'-0"	EXIST	EXIST	EXIST	EXIST	EXIST	ETR		HW-11	
(E)308a	F	3'-0"	7'-0"	EXIST	EXIST	EXIST	EXIST	EXIST	ETR		HW-15	PROVIDE SIGNAGE PER CAG30.02 & C100.02
308b	F	3'-0"	7'-0"	WD	MATCH EXIST	HM-02	HM	P-11			HW-10	
308c	F	3'-0"	7'-0"	WD	MATCH EXIST	HM-02	HM	P-11			HW-12	
308d	F	3'-0"	7'-0"	WD	MATCH EXIST	HM-02	HM	P-11			HW-13	
308e	F	3'-0"	7'-0"	WD	MATCH EXIST	HM-02	HM	P-11			HW-11	

HW SET: 10				HW SET: 11							
For use on Door #s): 308B				For use on Door #s): 308E							
Each to have:				Each to have:							
3	EA	HINGE	58B1 4.5 X 4.5	652	IVE	3	EA	HINGE	58B1 4.5 X 4.5 NRP	652	IVE
1	EA	STOREROOM LOCKSET	9K37U 1SD PATD S3	626M	BES	1	EA	ENTRANCE LOCKSET	9K37UA 1SD PATD S3	626M	BES
1	EA	SURFACE CLOSER	4040XP HEDA	689	LCN	1	EA	SURFACE CLOSER	4040XP HEDA	689	LCN
1	EA	KICK PLATE	8400 10" X 2" LDW B-CS	630	IVE	1	EA	KICK PLATE	8400 10" X 2" LDW B-CS	630	IVE
1	EA	WALL STOP	WS406407CCV	630	IVE	1	EA	WALL STOP	WS406407CCV	630	IVE
1	EA	GASKETING	4885BK PSA	6K	ZER	1	EA	GASKETING	4885BK PSA	6K	ZER

FRAME TYPES
 1/2" = 1'-0"

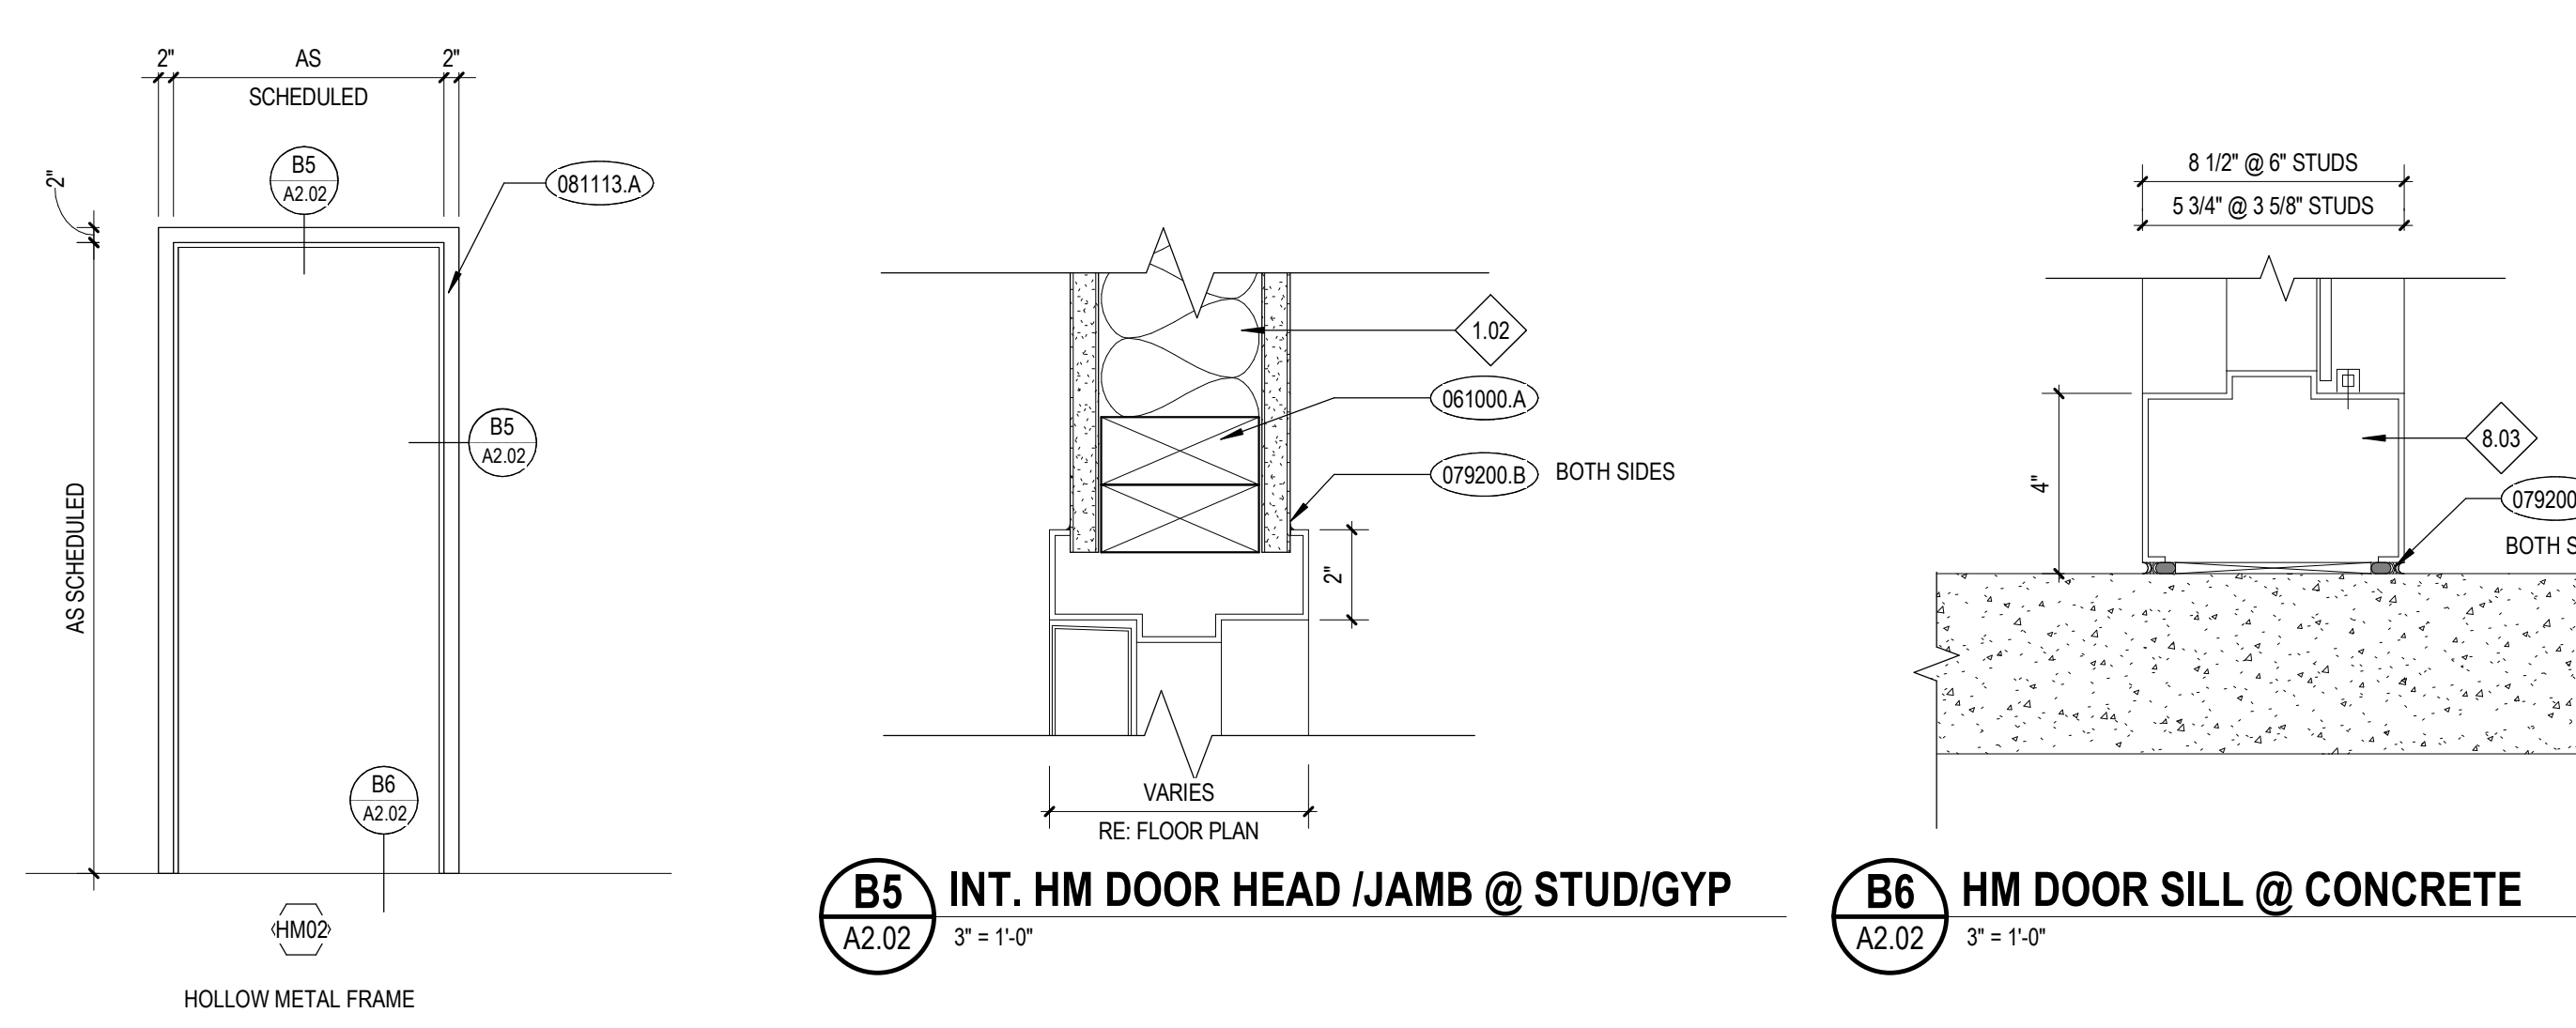

DOOR TYPES
 1/2" = 1'-0"

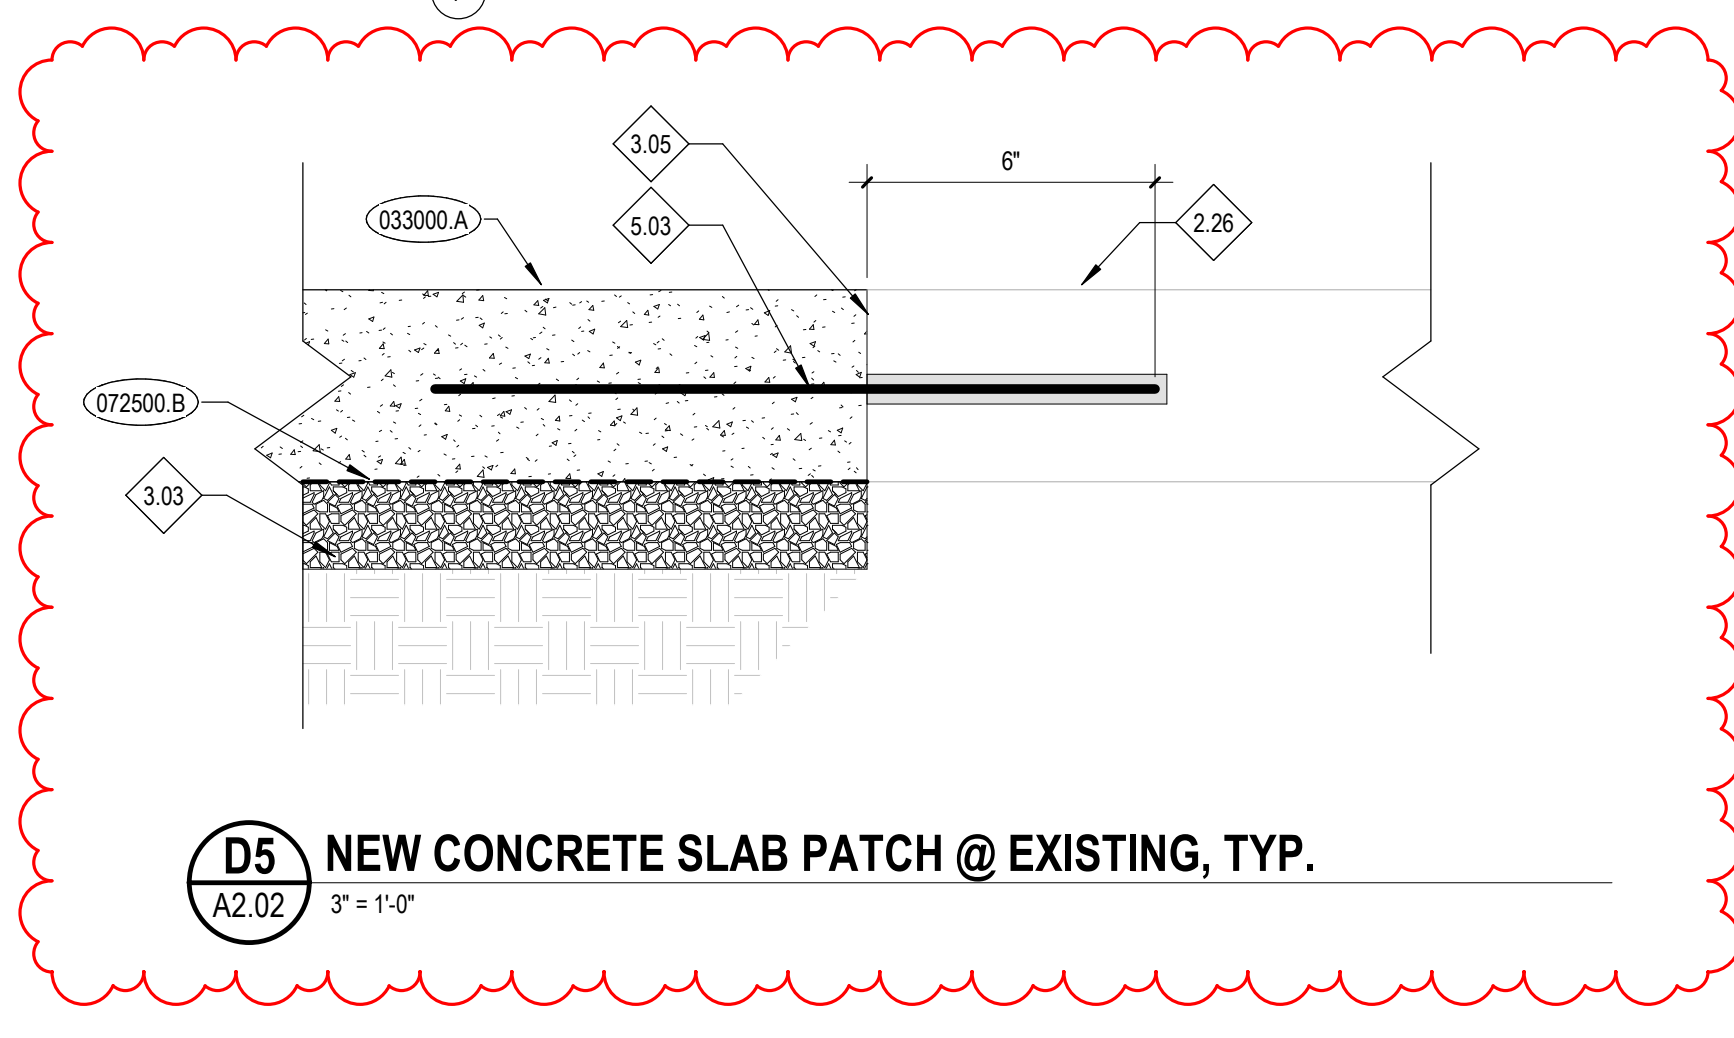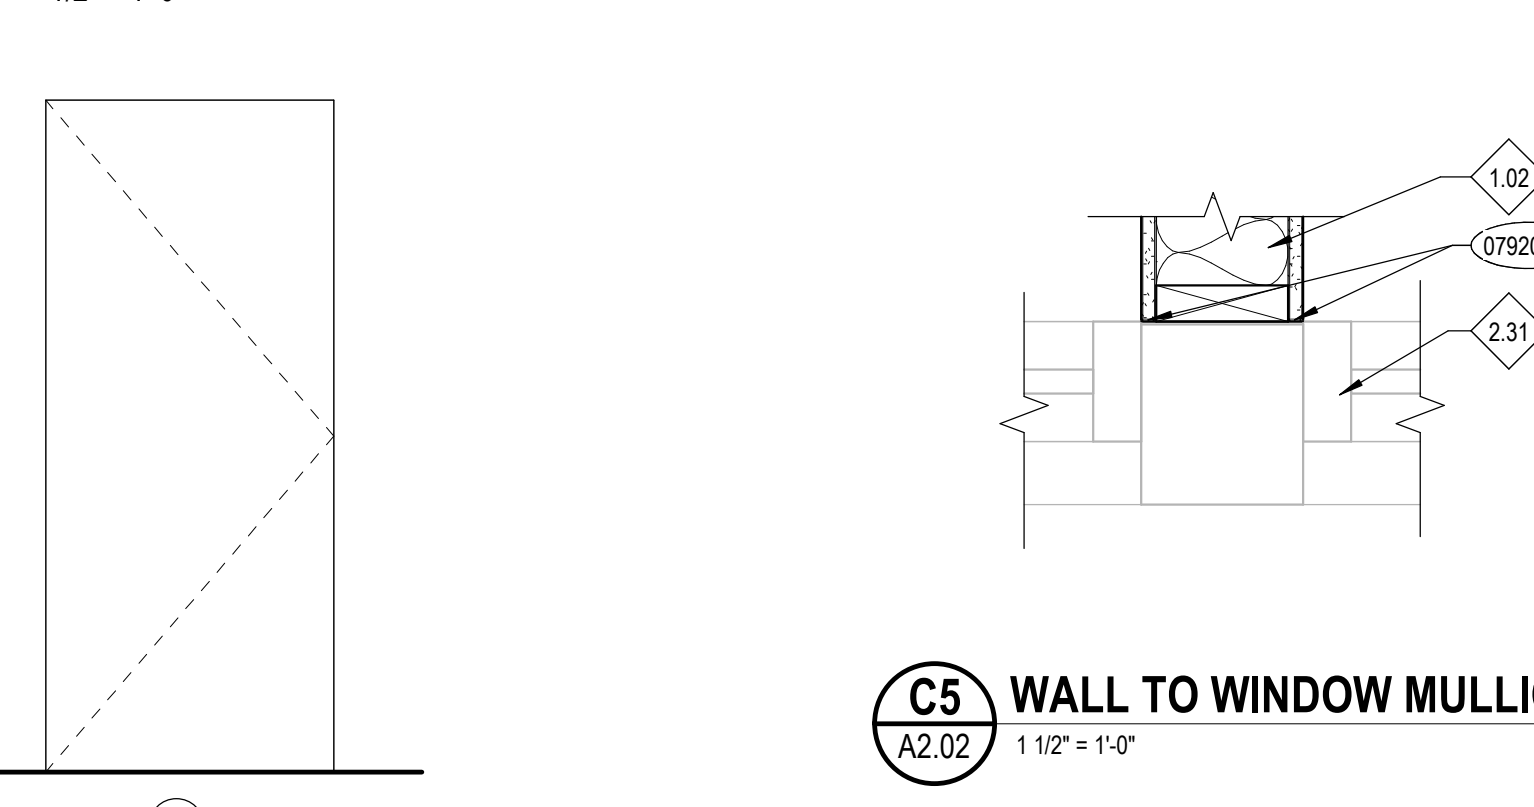

KEYNOTES

- 033000 A CAST-IN-PLACE CONCRETE.
- 061000 A DIMENSION LUMBER
- 072500 B VAPOR BARRIER
- 079200 B JOINT SEALANT
- 079200 C JOINT SEALANT BACKING
- 081113 A HOLLOW METAL FRAME
- 093013 B METAL EDGE STRIP ACCESSORY
- 096513 B RESILIENT MOLDING ACCESSORY

REFERENCE NOTES

- RE: FLOOR PLAN FOR WALL TYPES.
- EXISTING CONCRETE SLAB ON GRADE.
- EXISTING WINDOW SYSTEM TO REMAIN.
- MATCH ADJACENT EXISTING SUBGRADE/PREP, INCLUDING GRAVEL AND VAPOR RETARDER. PATCH ALL SEAMS PER MANUF. INSTRUCTIONS.
- SEAL BETWEEN EXISTING AND NEW #4 X 24" LONG DOWEL (CORE AND EPOXY) AT 24" O.C. AROUND PERIMETER INTO THE EXISTING SLAB.
- WINDOW SYSTEM AND/OR DOOR SYSTEM. RE: FLOOR PLANS AND WINDOW/DOOR TYPES.
- MATCH COLOR OF EXISTING DOOR FRAMES. P-11 RE: SECTION 09123, "INTERIOR PAINTING."

FINISH SCHEDULE REMARKS

- RE: INTERIOR ELEVATIONS FOR CERAMIC WALL TILE LOCATIONS.
- SEE FLOOR FINISH PLAN FOR LOCATIONS OF FLOOR MATERIALS.
- FLOOR AND WALL TILES TO BE EQUAL AT PERIMETERS OF SURFACE.
- PROVIDE CONTINUOUS SEALANT BETWEEN DISSIMILAR FINISHES. SEE FLOOR FINISH PLANS FOR FLOOR TRANSITIONS.
- PAINT ALL EXISTING AND NEW EXPOSED TO VIEW ITEMS THAT ARE NOT PREFINISHED, INCLUDING AND NOT LIMITED TO CONDUITS, GRILLES, PIPING AND COVER PLATES.

FINISH FLOOR LEGEND

- CPT-1 CARPET TILE
- PFT-2 PORCELAIN FLOOR TILE
- PFT-1 PORCELAIN FLOOR TILE
- LVT-1 LUXURY VINYL TILE

FINISH ABBREVIATIONS

FLOOR FINISHES

- CPT CARPET TILE
- CFT CERAMIC FLOOR TILE
- PFT PORCELAIN FLOOR TILE
- LVT LUXURY VINYL TILE

WALL BASE

- RWB RESILIENT WALL BASE
- MCB METAL COVE BASE

WALL FINISHES

- P PAINT
- CWT CERAMIC WALL TILE

CEILING

- APC ACOUSTICAL PANEL CEILING
- GYP GYPSUM BOARD
- O.T.S. OPEN TO STRUCTURE

CASEWORK

- PL PLASTIC LAMINATE

GENERAL NOTES

- PAINT ALL METAL FRAMES & ACCESSORIES P-11.
- ALL HOLLOW METAL FRAME GLAZING STOPS TO BE PLACED ON ROOM SIDE OPPOSITE FROM HALLWAY / CORRIDOR.
- CORNER GUARDS TO BE INSTALLED AT ALL OUTSIDE CORNERS. RE: SECTION 100500, "WALL AND DOOR PROTECTION".
- WHERE WALL TILE IS TO BE INSTALLED, PREPARE WALL WITH CEMENT BACKERBOARD.

ABBREVIATIONS

- ALUM ALUMINUM
- FF FACTORY FINISH AS SPECIFIED
- HM HOLLOW METAL
- HPC HIGH PERFORMANCE COATING
- PH PAINT COLOR NUMBER (RE: DIVISION 9 SECTION "INTERIOR PAINTING")
- WD WOOD
- AN ANODIZED
- ETR EXISTING TO REMAIN

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 644 Casewell Ave W
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Sheet:
 SUPPORT SERVICE CLASSROOM TI - DOORS & FINISHES

1	Agency Review 1	2/16/2024
2	Consolidated Set	2/23/2024

AR-1635
 2/16/24
 PERMIT SET

Project No: 23010-00
 Drawn By: CW
 Checked By: PR
 Date: 2/23/2024

Sheet No: **A2.02**

UNLESS NOTED OTHERWISE ALL SCHEDULED DATA IS LISTED AT ELEVATION 3700 FT

GENERAL LEGEND (Not all symbols listed below are used on these drawings)

HVAC LEGEND (Not all symbols listed below are used on these drawings)



Project Information

Energy Code: 2018 IECC
Proposed Project: TFSD Capital Improvements - Robert Stuart Middle School
Location: Twin Falls, Idaho
Climate Zone: 5B
Project Type: Alteration

Construction Site

Twin Falls, ID
Owner/Agent: Twin Falls School District
Boise, ID 83301
Designer/Contractor: Lily Johnson, P.E.
CATOR RUMA
BOISE, ID
2083433663

Mechanical Systems List

- Quantity System Type & Description
1. DX-1 and CU-1 (Single Zone):
Cooling: 1 each - Split System, Capacity = 42 kBtu/h, Air-Cooled Condenser, No Economizer, Economizer exception: None
Proposed Efficiency = 13.00 SEER, Required Efficiency: 13.00 SEER
Fan System: Unspecified
2. DX-2.3 and CU-2.3 (Single Zone):
Split System Heat Pump
Heating Mode: Capacity = 27 kBtu/h,
Proposed Efficiency = 8.20 HSPFP, Required Efficiency = 8.20 HSPFP
Cooling Mode: Capacity = 24 kBtu/h,
Proposed Efficiency = 14.00 SEER, Required Efficiency: 14.00 SEER
Fan System: Unspecified

Mechanical Compliance Statement

Compliance Statement: The proposed mechanical alteration project represented in this document is consistent with the building plans, specifications, and other calculations submitted with this permit application. The proposed mechanical systems have been designed to meet the 2018 IECC requirements in COMcheck Version 4.1.5.5 and to comply with any applicable mandatory requirements listed in the Inspection Checklist.

Lily Johnson, P.E.
Name - Title Signature Date 2.16.24

GENERAL NOTES:

- 1. WORK INCLUDED IN THE CONTRACT IS DENOTED IN BOLD. EXISTING CONDITIONS TO REMAIN ARE DENOTED LIGHTLY.
2. A DETAILED METHOD OF PROCEDURE IS REQUIRED WHEN A CONSTRUCTION ACTIVITY AFFECTS THE SAFETY OF THE OCCUPANTS, OWNERS EQUIPMENT OR VALUABLE CONTENTS OR ANY SYSTEM WHICH SUPPORTS THESE SYSTEMS. OR ESSENTIALLY AFFECTS THE BUILDING MANAGEMENT, OPERATIONS OR SECURITY.
3. CONTRACTOR IS RESPONSIBLE FOR FIELD VERIFICATION OF ALL EXISTING CONDITIONS PRIOR TO COMMENCEMENT OF ANY WORK AND SHALL NOTIFY THE ENGINEER/ARCHITECT OF ANY DISCREPANCIES FOR RESOLUTION.
4. COORDINATE WORK WITH ALL TRADES.
5. CONTRACTOR IS RESPONSIBLE FOR SECURING AND WEATHERPROOFING ANY ROOF OPENING NOT COMPLETED DURING WORKING HOURS.
6. COORDINATE ALL DUCTWORK AND PIPING WITH EQUIPMENT, STRUCTURE, ETC.
7. CONTRACTOR SHALL BE RESPONSIBLE FOR DEACTIVATION OF ROOF-MOUNTED EQUIPMENT AND ASSOCIATED INDOOR EQUIPMENT. ONLY ONE UNIT SHALL BE TAKEN OUT OF SERVICE AT ANY TIME, WITH REMAINDER OF UNITS LEFT OPERATIONAL.
8. CONTRACTOR SHALL NOT SHUT DOWN / TAKE OUT OF SERVICE ANY SYSTEMS WITHOUT FIRST COORDINATING WITH OWNER AND PREPARING M.O.P.

DEMOLITION GENERAL NOTES:

- 1. EXISTING ITEMS TO REMAIN ARE DENOTED LIGHTLY UNLESS OTHERWISE NOTED. ALL ITEMS SHOWN DASHED & BOLD SHALL BE REMOVED UNLESS OTHERWISE NOTED.
2. CONTRACTOR SHALL NOT SHUT-OFF OR PUT-OUT OF SERVICE ANY SYSTEMS OR SERVICE WITHOUT FIRST COORDINATING WITH THE OWNER.
3. IT IS THE RESPONSIBILITY OF THE CONTRACTOR TO VISIT THE SITE AND UNDERSTAND THE EXTENT OF THE REMODEL WORK REQUIRED PRIOR TO BID. NO EXTRAS WILL BE ALLOWED FOR WORK REQUIRED TO ACHIEVE THE END RESULT AS INDICATED BY THE CONTRACT DOCUMENT.
4. CONTRACTOR SHALL DETERMINE AND COORDINATE THE EXACT EXTENT OF DEMOLITION TO FACILITATE ALL WORK INDICATED BY THE CONTRACT DOCUMENT.
5. PRIOR TO COMMENCEMENT OF ANY DEMOLITION WORK, VERIFY EXISTING CONDITIONS AND NOTIFY ENGINEER OF ANY DISCREPANCIES FOR RESOLUTION.
6. ALL ITEMS IDENTIFIED TO BE REMOVED SHALL BE REMOVED IN THEIR ENTIRETY UNLESS OTHERWISE NOTED. REMOVED ITEMS SHALL BE TURNED OVER TO THE OWNER UNLESS OTHERWISE NOTED AND STORED IN THE AREA DESIGNATED BY THE OWNER. REMOVE FROM SITE AND LEGALLY DISPOSE OF ALL ITEMS THE OWNER CHOOSES NOT TO ACCEPT.
7. WHERE EXISTING PIPING, T.C. TUBING/WIRING ETC. ARE TO BE REMOVED FROM WALLS WHICH ARE REMAINING, THE WALLS SHALL BE REPAIRED TO MATCH ORIGINAL CONDITIONS.
8. WHERE EXISTING PIPING TO BE REMOVED PASSES THROUGH FLOORS, THEY SHALL BE CUT BACK TO WITHIN CONCRETE AND FILLED WITH GROUT TO ACHIEVE A SMOOTH AND EVEN FINISH WITH CONCRETE SURFACE.

DOUBLE/SINGLE LINE DUCT LEGEND (Not all symbols listed below are used on these drawings)

DUCTLESS SPLIT SYSTEM OUTDOOR UNIT SCHEDULE

Table with columns: DESIG, NAME, NO., MFR, MODEL, MOUNTING, OPERATING FUNCTION, NOMINAL TONS (SL), COOLING CAPACITY, TOTAL MBH, AMBIENT AIR, LOW AMBIENT, AHR1 SEER, SOUND POWER (dBA), REFRIGERANT, CHARGE (LBS), SIZE (INCHES), OPER WEIGHT (LBS), ELECTRICAL, VOLTAGE, PHASE, MCA, MOC, CONTROL, REMARKS

DUCTLESS SPLIT SYSTEM INDOOR UNIT SCHEDULE

Table with columns: DESIG, NAME, NO., MFR, MODEL, MOUNTING, SUPPLY FAN, COOLING COIL - REFRIGERANT (AHR1), SIZE (INCHES), OPER WEIGHT (LBS), POWER SOURCE, REMARKS

FAN SCHEDULE

Table with columns: DESIG, NAME, NO., MFR, MODEL, FAN TYPE, SERVICE, FAN CLASS, CFM AT ELEV, E.S.P. (IN. W.C.), APPROX. RPM, HP OR WATTS, VOLTAGE, PHASE, DRIVE TYPE, BACKDRAFT DAMPER (BDD), THROAT HEIGHT (INCHES), THROAT WIDTH (INCHES), SIZE (INCHES), OPER. WEIGHT (LBS), CONTROL, REMARKS


ENERGY RECOVERY VENTILATOR SCHEDULE

Table with columns: DESIG, NAME, NO., MFR, MODEL NO., CFM, ESP (IN. WC), TSP (IN. WC), NO. OF FANS, EXHAUST FAN SECTION, ENERGY RECOVERY WHEEL OR AIR-TO-AIR HEAT EXCHANGER, UNIT SIZE, OPER. WEIGHT (LBS), CONTROL, REMARKS


COIL SCHEDULE

Table with columns: DESIG, NAME, NO., MFR, MODEL, CFM AT ELEV, WIDTH (IN), HEIGHT (IN), KW, ELECTRIC COIL CONDITIONS, OPER. WEIGHT (LBS.), CONTROL, REMARKS, Schedule

DUCT TAKE-OFF DETAIL

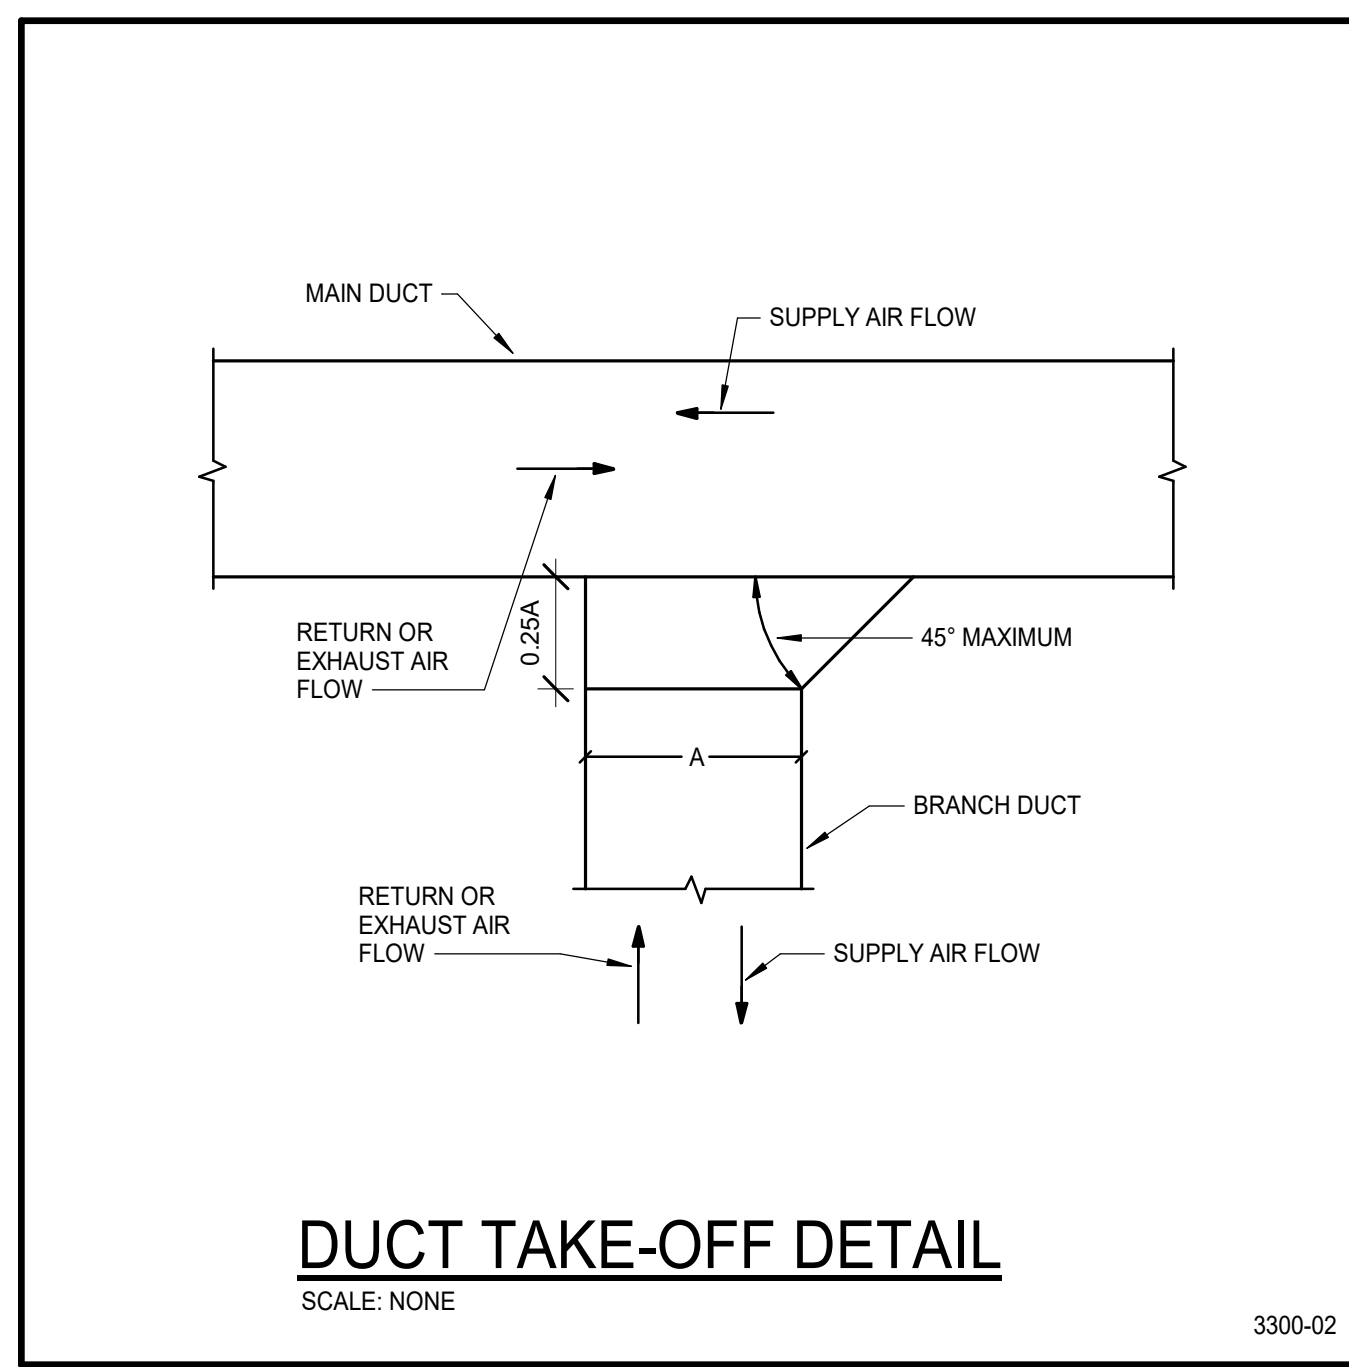

UPBLAST ROOF EXHAUST FAN DETAIL

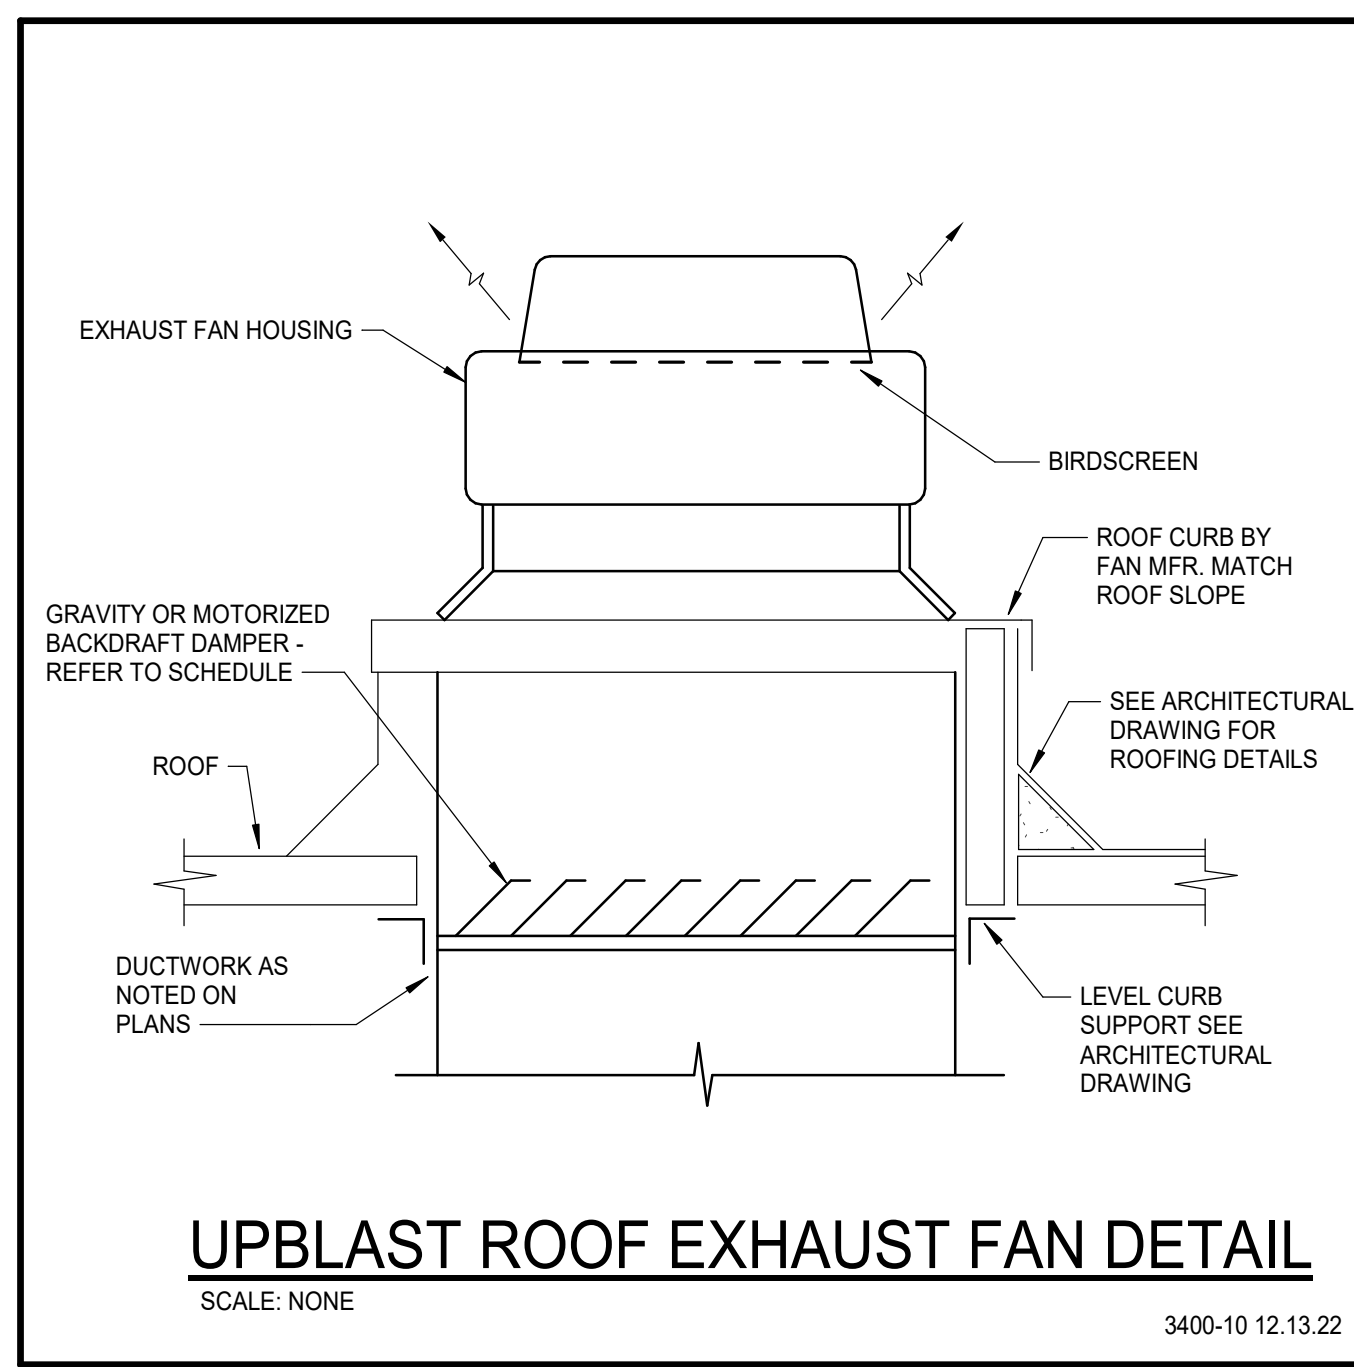

AIR DEVICE SCHEDULE

Table with columns: DESIG, FUNCTION, STYLE, MFR, MODEL, FRAME STYLE, MODULE SIZE, MATERIAL, FINISH, REMARKS


OUTSIDE AIR VENTILATION CALCULATIONS (OAV)

Table with columns: AIR SYSTEM TAG, ROOM OCCUPANCY CLASSIFICATION, ZONE VENTILATION EFFECTIVENESS (Ez) = 0.8, SYSTEM OCCUPANT DENSITY (D) = 100, OUTSIDE AIR SUMMARY



Project: TFSD 2023 CAPITAL IMPROVEMENTS PACKAGE 6, SUPPORT SERVICE CLASSROOM TENANT IMPROVEMENT AT ROBERT STUART MIDDLE SCHOOL 644 Caswell Ave W Twin Falls, ID 83301

MECHANICAL LEGENDS, NOTES & SCHEDULES

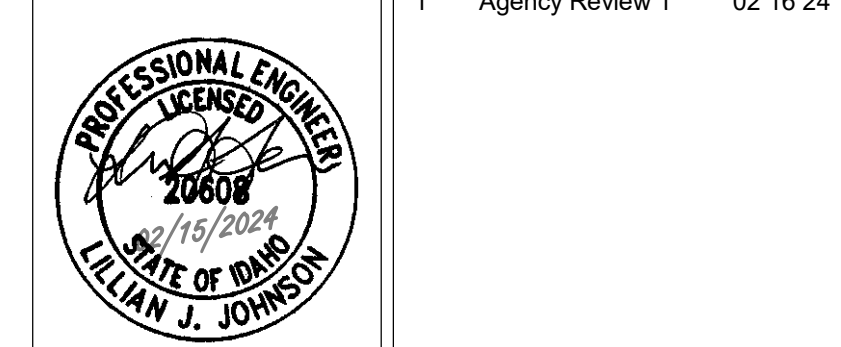

100% CONSTRUCTION DOCUMENTS

Project No: 23010-00 Drawn By: BS Checked By: LJ Date: 12/22/2023


Sheet No: M0.01

KEYNOTES

M1	REMOVE EXISTING WALL MOUNT STEAM CONNECTOR. REMOVE STEAM AND CONDENSATE PIPING DOWN BELOW FLOOR SLAB AND CAP.
M2	REMOVE EXISTING EXHAUST CEILING GRILLE. REMOVE EXHAUST DUCT UP TO MAIN AND CAP.
M3	REMOVE EXISTING CEILING SUPPLY GRILLE AND FLEXIBLE DUCT. MAINTAIN DUCTWORK FOR REUSE IN NEW STORAGE ROOM.
M4	CONNECT TO EXISTING SUPPLY AIR DUCTWORK. FIELD VERIFY LOCATION AND SIZE. PROVIDE TRANSITION TO NEW DUCT AND MODIFY EXISTING AS REQUIRED TO MAKE A PROPER CONNECTION.
M5	EXTEND 10x10 EXHAUST DUCT UP TO NEW EXHAUST FAN, EF-1, ON ROOF ABOVE.
M6	LOCATE BALANCE DAMPERS ABOVE ACCESSIBLE CEILING.
M7	REMOVE EXISTING WINDOW MOUNTED AIR CONDITIONER. RETURN TO OWNER.
M8	EXISTING HEATING VENTILATOR TO REMAIN.
M9	EXISTING HEATING CONNECTOR TO REMAIN.
M10	NEW 8" DIAMETER DUCT TO NEW FRESH AIR ROOF CAP ABOVE.
M11	NEW 8" DIAMETER DUCT TO NEW EXHAUST AIR ROOF CAP ABOVE.
M12	MOUNT ON WALL AS HIGH AS POSSIBLE.
M14	USE ALUMINUM DUCTWORK FOR BRANCH SERVING SHOWER.
M15	SUPPORT CONDENSING UNITS ON "MRO" MINI SPLIT RAIL SUPPORT STAND OR SIMILAR. SIZE STAND TO PREVENT OVERTURNING. ALLOW FOR MANUFACTURER'S REQUIRED CLEARANCES.
M16	PROVIDE 4" DUCT FOR NEW DRYER, BY OTHERS. EXTEND THROUGH EXTERIOR WALL AND PROVIDE WITH CRACK APPROVED WALL CAP. NO INSECT SCREEN.
M21	SET EXISTING HEATING THERMOSTAT TO 70 F, AND THE NEW COOLING THERMOSTAT TO 78 F, TO PREVENT SIMULTANEOUS HEATING AND COOLING IN THE ROOM.

A


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↑ **LEVEL 1 HVAC DEMOLITION PLAN**
SCALE: 1/8" = 1'-0"

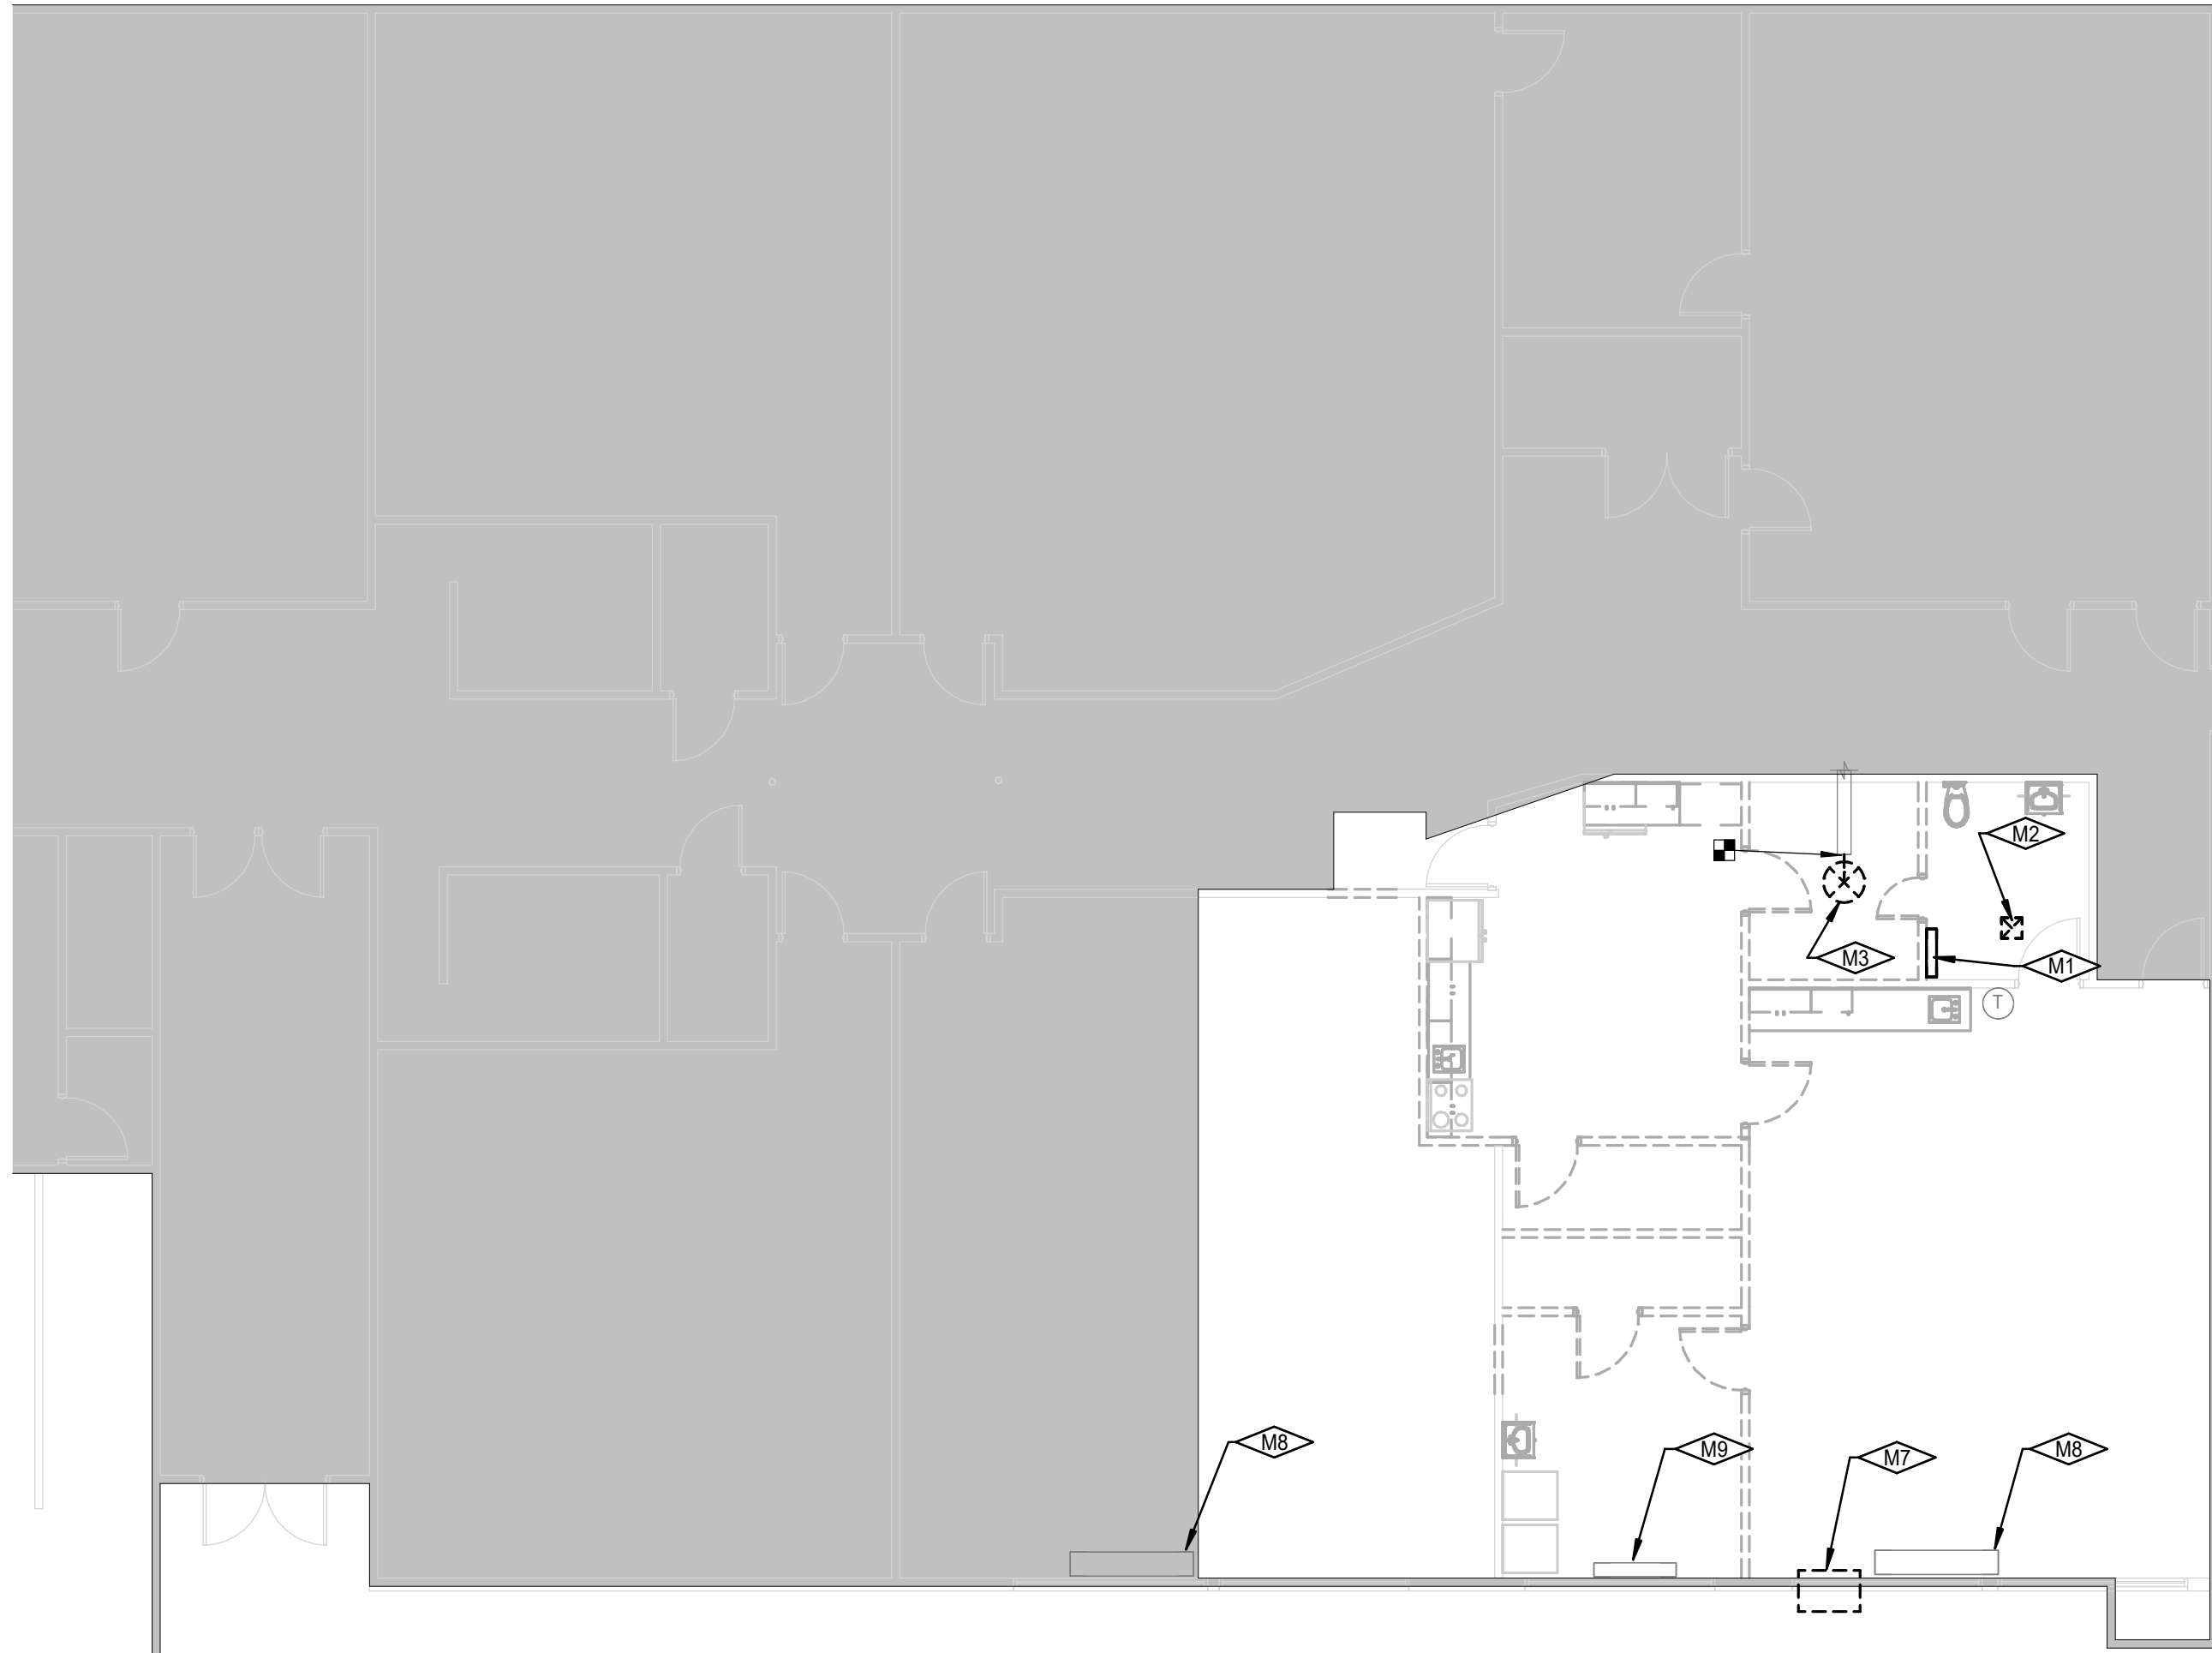C

D



↑ **LEVEL 1 HVAC PLAN**
SCALE: 1/8" = 1'-0"

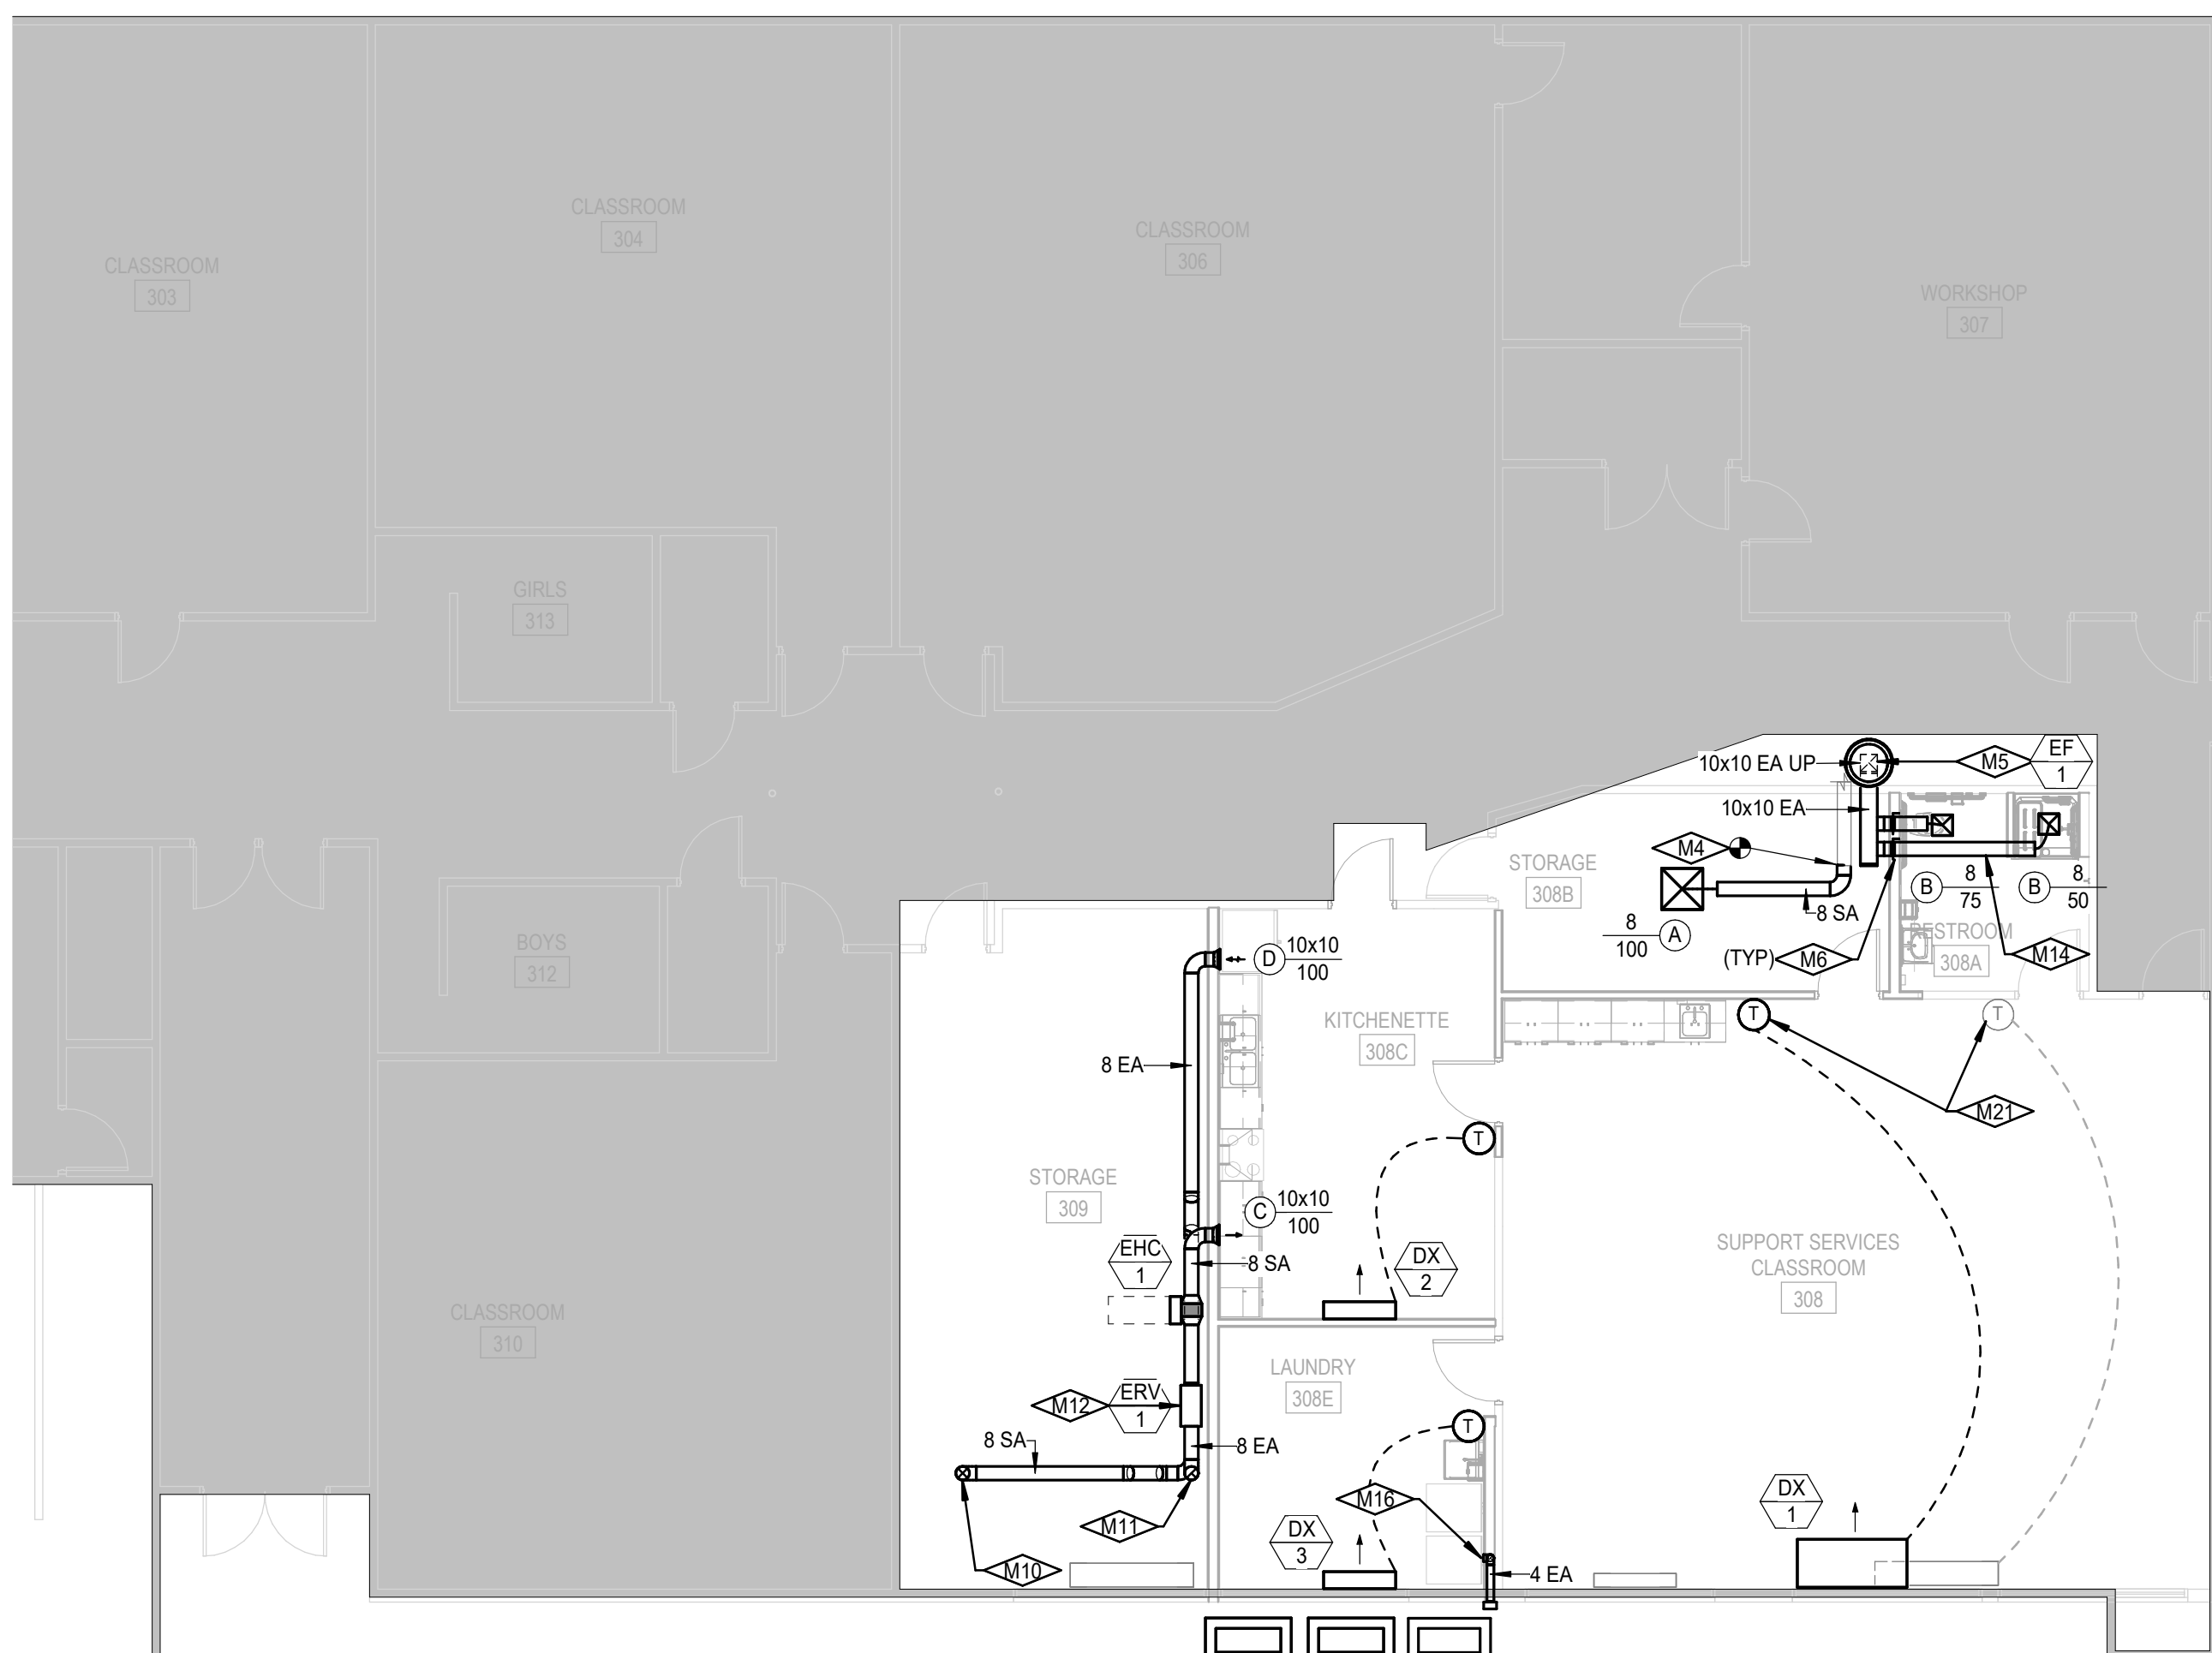E


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PACKAGE 6, SUPPORT SERVICE
CLASSROOM TENANT IMPROVEMENT
AT ROBERT STUART MIDDLE SCHOOL
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Twin Falls, ID 83301

Sheet:
LEVEL 1 HVAC PLANS

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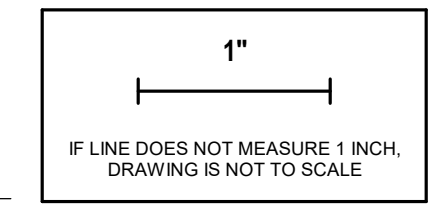


KEY PLAN
SCALE: NONE

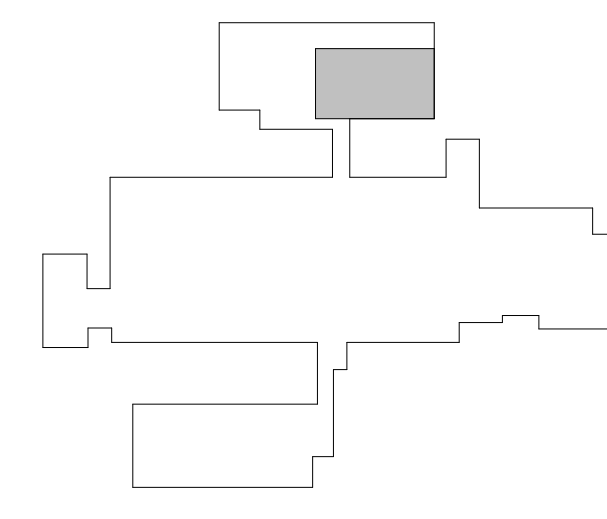

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Checked By: LJ
Date: 12/22/2023

Sheet No:
M2.01



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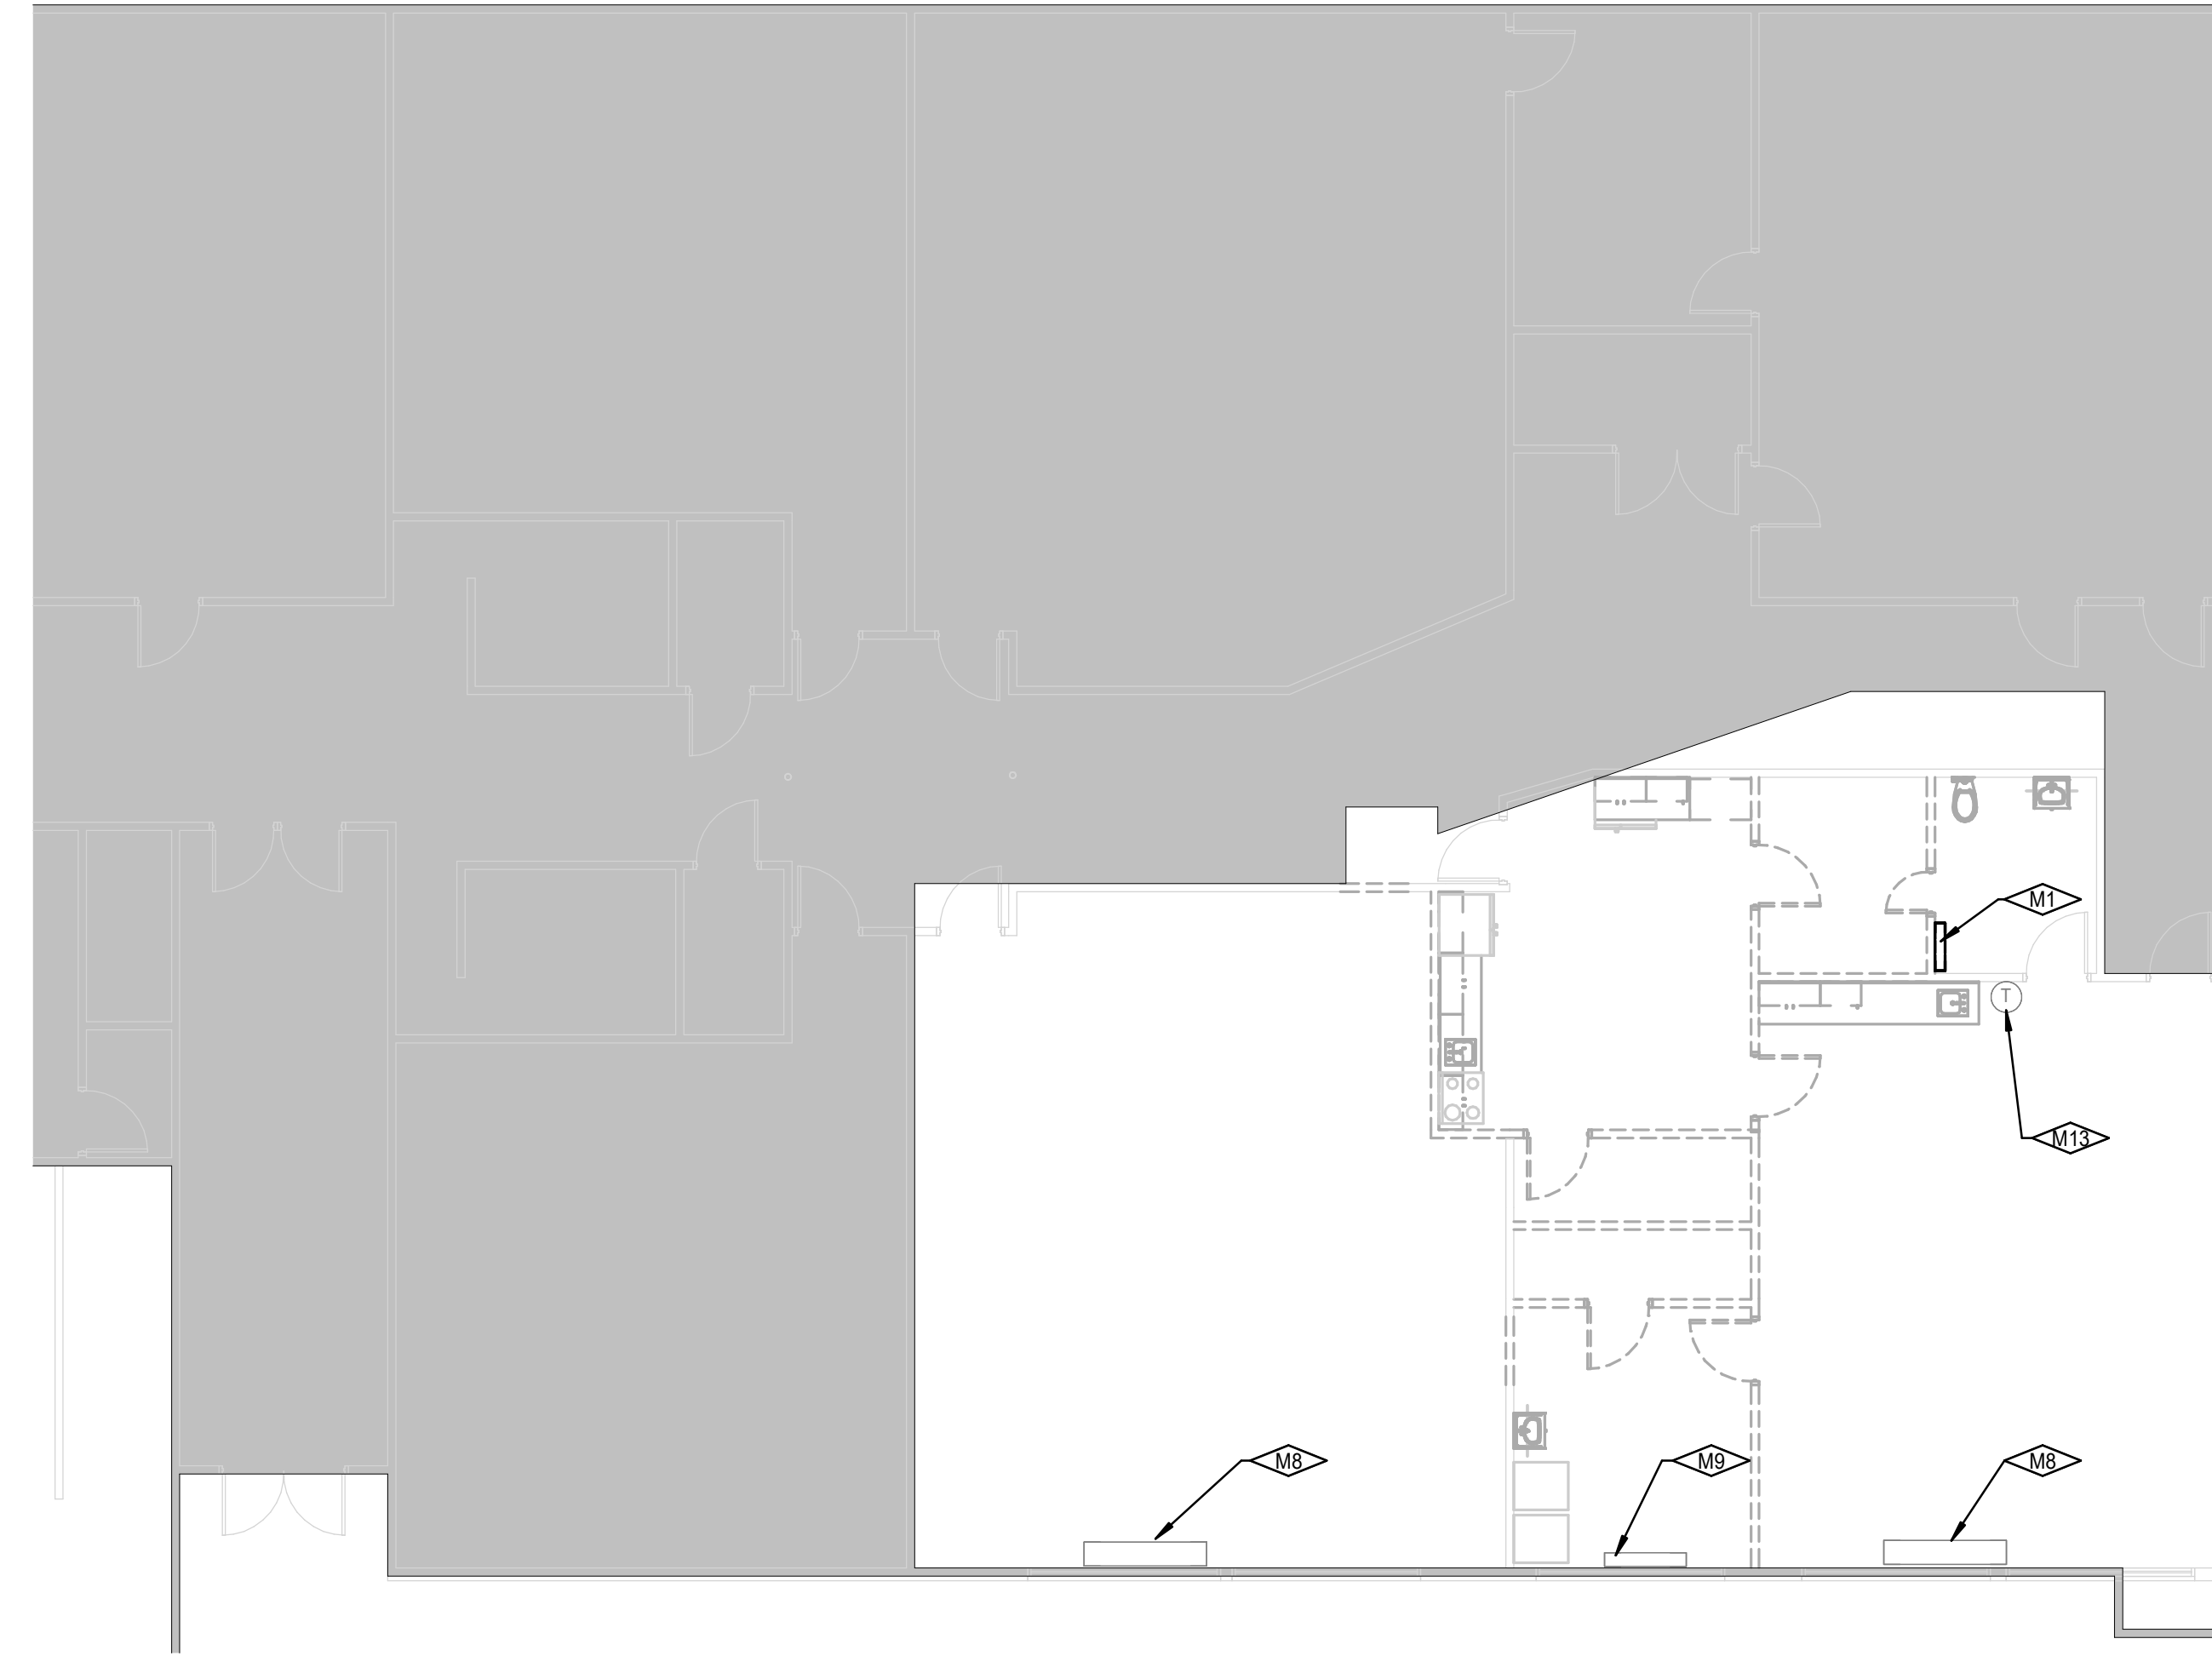
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KEYNOTES

M1	REMOVE EXISTING WALL MOUNT STEAM CONVECTOR, REMOVE STEAM AND CONDENSATE PIPING DOWN BELOW FLOOR SLAB AND CAP.
M8	EXISTING HEATING VENTILATOR TO REMAIN.
M9	EXISTING HEATING CONVECTOR TO REMAIN.
M13	EXISTING THERMOSTAT TO REMAIN.
M17	LOCATE REFRIGERANT AND CONDENSATE PIPING ABOVE NEW CEILING. REFER TO ARCHITECTURAL DRAWINGS. SIZE REFRIGERANT PIPING PER MANUFACTURE FOR ACTUAL INSTALLED PIPE LENGTHS.
M19	SUPPORT EXTERIOR REFRIGERANT PIPING ON EXISTING EXTERIOR WALL.
M20	DISCHARGE CONDENSATE PIPING FROM EACH NEW UNIT NEAR GRADE.

A


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LEVEL 1 HVAC PIPING DEMOLITION PLAN
SCALE: 1/8" = 1'-0"


C

D



LEVEL 1 HVAC PIPING PLAN
SCALE: 1/8" = 1'-0"

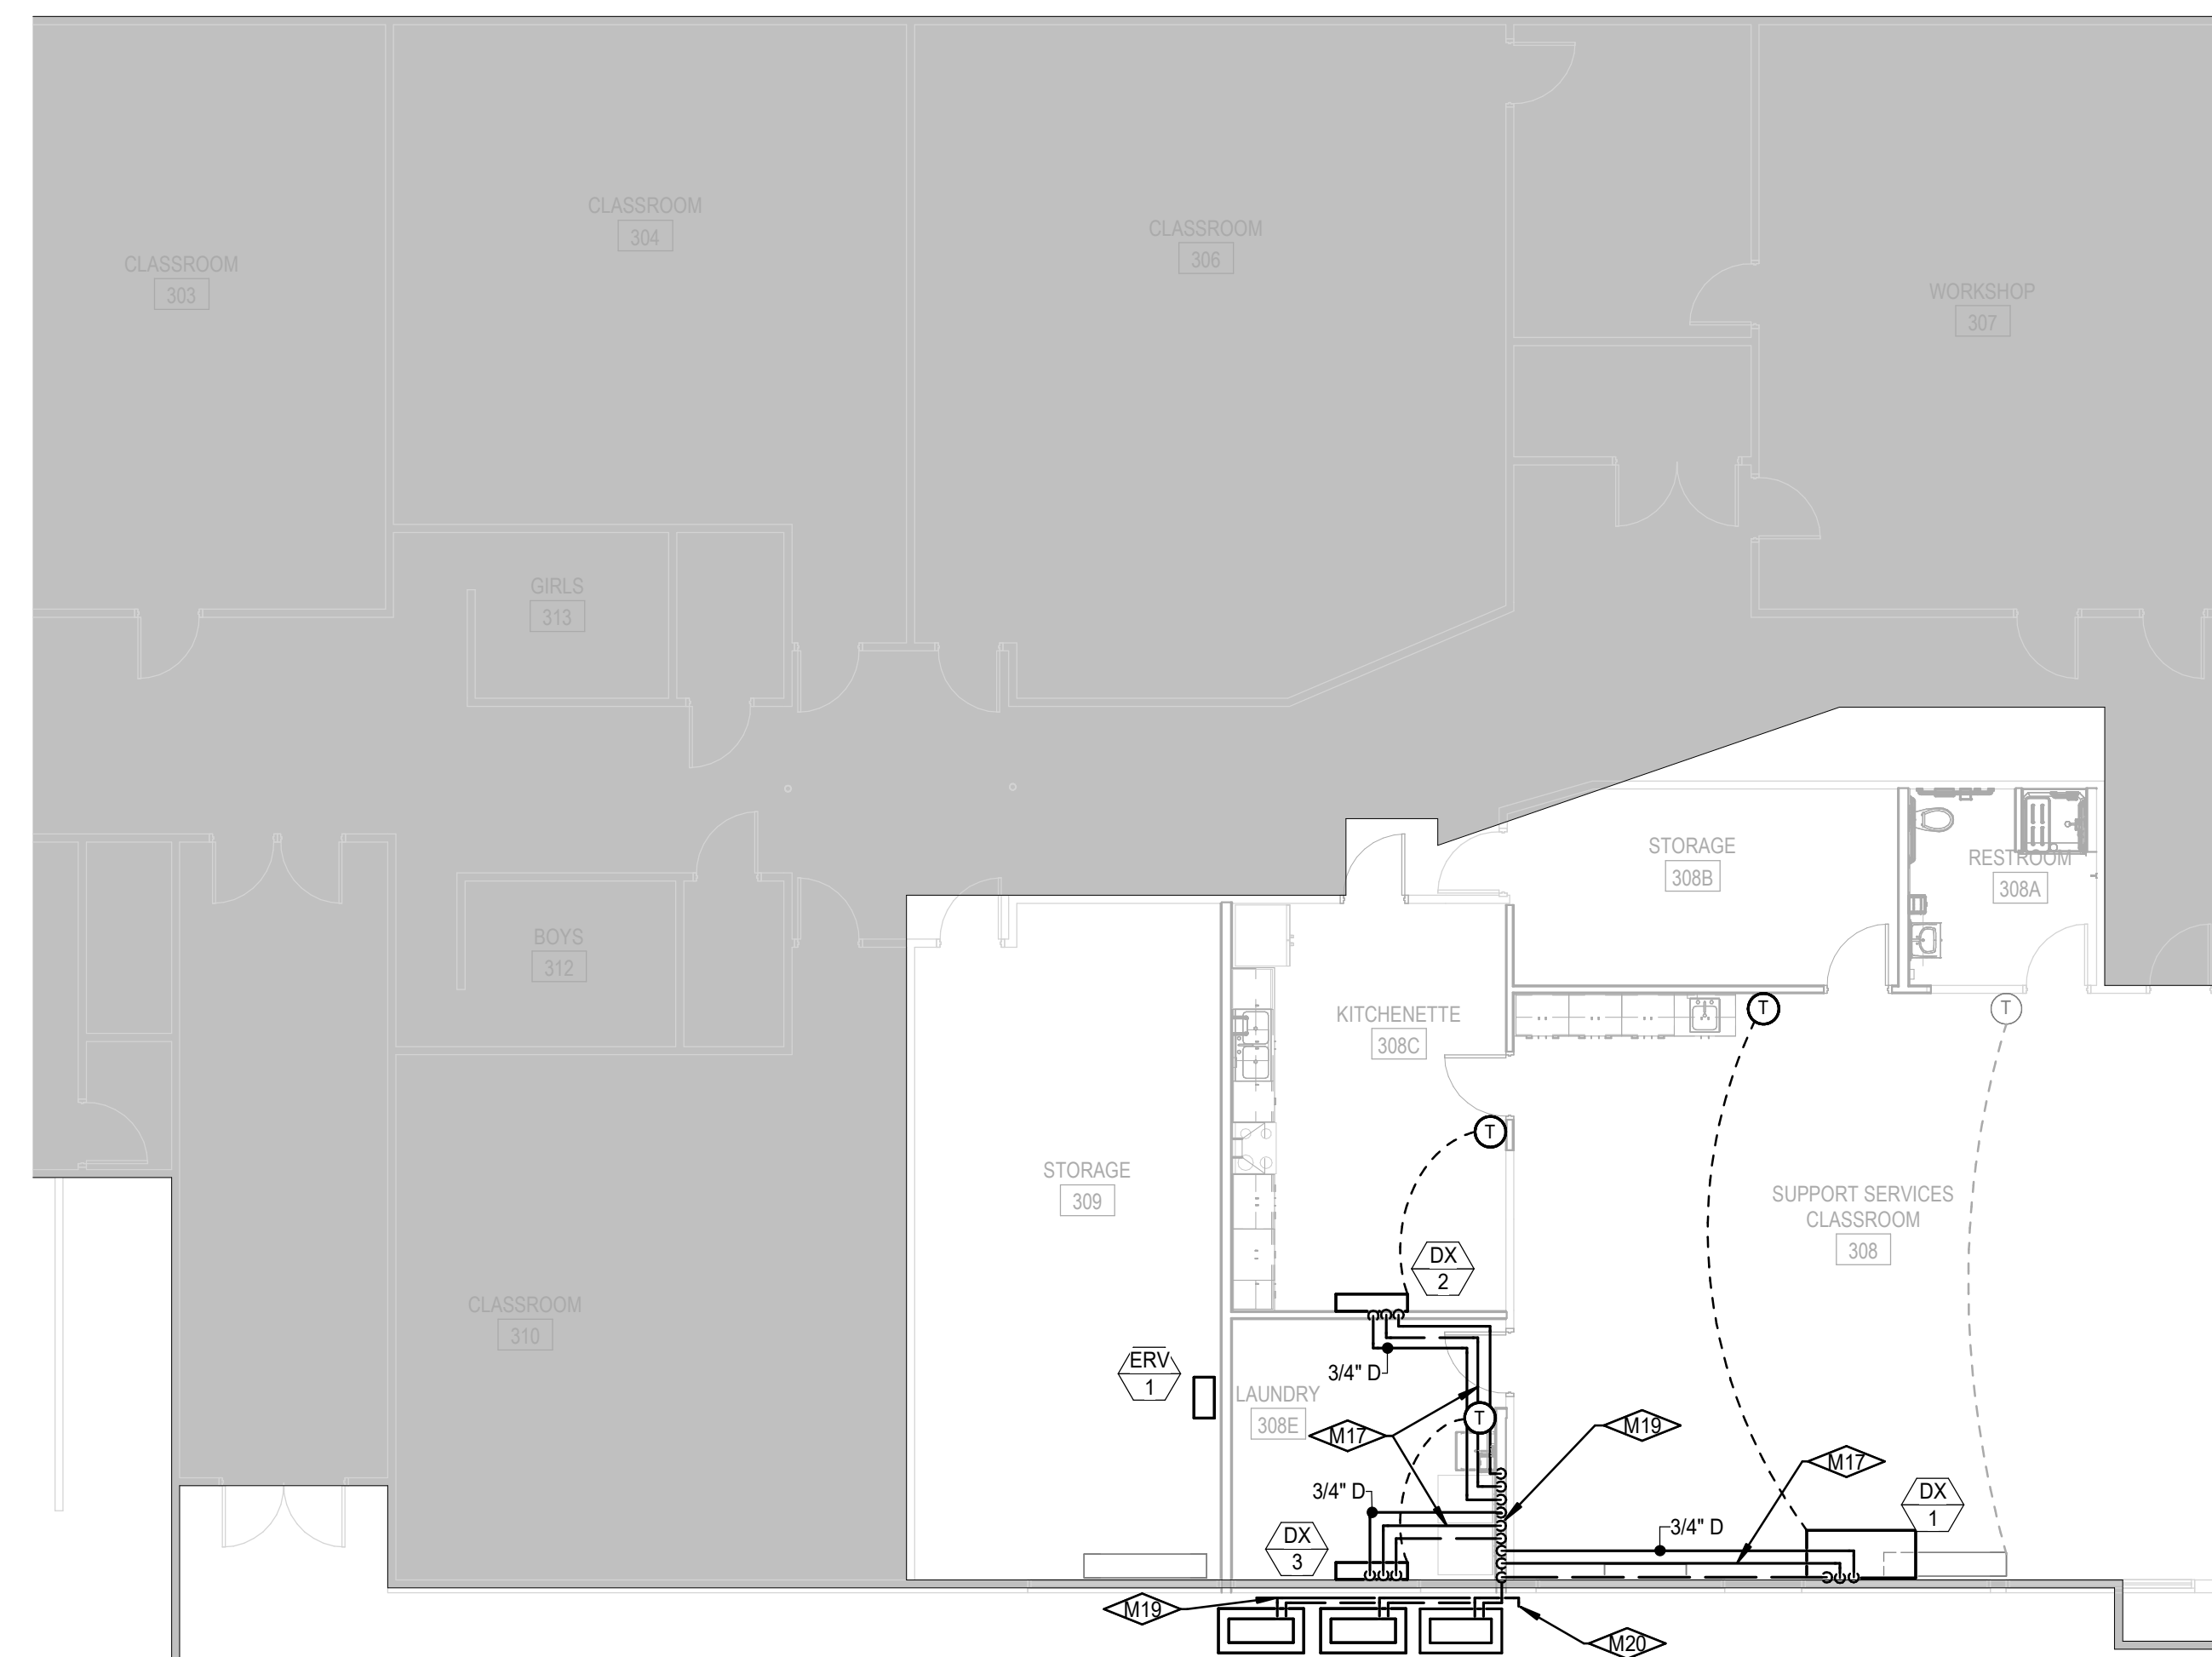E

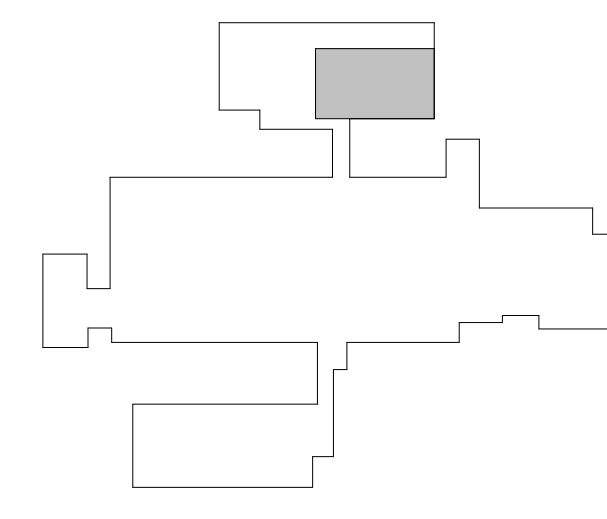

KEY PLAN
SCALE: NONE

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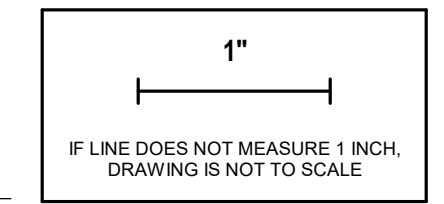
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Sheet:
LEVEL 1 HVAC PIPING PLANS



Project No: 23010-00
Drawn By: BS
Checked By: LJ
Date: 12/22/2023

Sheet No:
M2.11



GENERAL LEGEND

Table with 4 columns: ABBR, SYMBOL, DESCRIPTION, and DESCRIPTION. It lists various plumbing symbols and their corresponding descriptions, such as section designations, equipment unit identifications, and pipe types.

PLUMBING LEGEND

Table with 4 columns: ABBR, SYMBOL, DESCRIPTION, and DESCRIPTION. It lists plumbing symbols for various pipe types, valves, and fixtures, such as domestic cold/hot water piping, tepid water piping, and various valves.

GENERAL NOTES:

- 1. WORK INCLUDED IN THE CONTRACT IS DENOTED IN BOLD. EXISTING CONDITIONS TO REMAIN ARE DENOTED LIGHTLY.
2. A DETAILED METHOD OF PROCEDURE IS REQUIRED WHEN A CONSTRUCTION ACTIVITY AFFECTS THE SAFETY OF THE OCCUPANTS, OWNERS EQUIPMENT OR VALUABLE CONTENTS OR ANY SYSTEM WHICH SUPPORTS THESE SYSTEMS...
3. CONTRACTOR IS RESPONSIBLE FOR FIELD VERIFICATION OF ALL EXISTING CONDITIONS PRIOR TO COMMENCEMENT OF ANY WORK AND SHALL NOTIFY THE ENGINEER/ARCHITECT OF ANY DISCREPANCIES FOR RESOLUTION.
4. COORDINATE WORK WITH ALL TRADES.
5. COORDINATE ALL PIPING WITH EQUIPMENT, STRUCTURE, ETC.
6. CONTRACTOR SHALL NOT SHUT DOWN / TAKE OUT OF SERVICE ANY SYSTEMS WITHOUT FIRST COORDINATING WITH OWNER AND PREPARING M.O.P.

PLUMBING NOTES:

- 1. CONTRACTOR SHALL NOT SHUT-OFF/PUT OUT OF SERVICE ANY SYSTEMS/SERVICES WITHOUT FIRST COORDINATING WITH OWNER.
2. THIS CONTRACTOR SHALL COORDINATE LOCATIONS OF PIPING WITH OTHER TRADES AND ADVISE ARCHITECT/ENGINEER OF ANY POSSIBLE CONFLICTS. VERIFY EXACT LOCATIONS, ELEVATIONS AND DIMENSIONS OF STRUCTURAL MEMBERS AND OPENINGS.
3. SEE SPECIFICATIONS FOR WATER HAMMER ARRESTOR SIZING. ALL FLUSH VALVES AND SOLENOID OPERATED EQUIPMENT SHALL HAVE A WATER HAMMER ARRESTOR.
4. SEE PLUMBING FIXTURE SCHEDULE FOR PIPE SIZING TO INDIVIDUAL PLUMBING FIXTURES.
5. ALL EXISTING FIXTURES AND EQUIPMENT TO BE REMOVED SHALL HAVE ALL ASSOCIATED PIPING CONTROLS, HANGERS, SUPPORTS AND ANY MISCELLANEOUS ASSOCIATED SERVICE OR PART REMOVED COMPLETELY.
6. REFER TO ARCHITECTURAL DRAWINGS FOR FIXTURE ELEVATIONS AND LOCATIONS.
7. SEE ARCHITECTURAL CONSTRUCTION DOCUMENTS FOR DIMENSIONED LOCATION OF PLUMBING FIXTURES AND WALLS.
8. PROVIDE CLEANOUTS IN ACCESSIBLE LOCATIONS PER THE PROJECT SPECIFICATIONS AND LOCAL PLUMBING CODES.

FOUNDATION PLUMBING NOTES:

- 1. CONTRACTOR IS RESPONSIBLE FOR FIELD VERIFICATION OF ALL EXISTING CONDITIONS PRIOR TO COMMENCEMENT OF ANY WORK.
2. COORDINATE WORK WITH ALL TRADES.
3. SEE ARCHITECTURAL CONSTRUCTION DOCUMENTS FOR EXACT LOCATION OF PLUMBING FIXTURES AND WALLS.
4. PROVIDE A WALL CLEANOUT ON ALL VERTICAL VENT PIPING SERVING BELOW GRADE HORIZONTAL WASTE PIPING.

DEMOLITION GENERAL NOTES:


- 1. EXISTING ITEMS TO REMAIN ARE DENOTED LIGHTLY UNLESS OTHERWISE NOTED. ALL ITEMS SHOWN DASHED & BOLD SHALL BE REMOVED UNLESS OTHERWISE NOTED.
2. CONTRACTOR SHALL NOT SHUT-OFF OR PUT-OUT OF SERVICE ANY SYSTEMS OR SERVICE WITHOUT FIRST COORDINATING WITH THE OWNER.
3. IT IS THE RESPONSIBILITY OF THE CONTRACTOR TO VISIT THE SITE AND UNDERSTAND THE EXTENT OF THE REMODEL WORK REQUIRED PRIOR TO BID. NO EXTRAS WILL BE ALLOWED FOR WORK REQUIRED TO ACHIEVE THE END RESULT AS INDICATED BY THE CONTRACT DOCUMENT.
4. CONTRACTOR SHALL DETERMINE AND COORDINATE THE EXACT EXTENT OF DEMOLITION TO FACILITATE ALL WORK INDICATED BY THE CONTRACT DOCUMENT.
5. PRIOR TO COMMENCEMENT OF ANY DEMOLITION WORK, VERIFY EXISTING CONDITIONS AND NOTIFY ENGINEER OF ANY DISCREPANCIES FOR RESOLUTION.
6. ALL ITEMS IDENTIFIED TO BE REMOVED SHALL BE REMOVED IN THEIR ENTIRETY UNLESS OTHERWISE NOTED. REMOVED ITEMS SHALL BE TURNED OVER TO THE OWNER UNLESS OTHERWISE NOTED AND STORED IN THE AREA DESIGNATED BY THE OWNER. REMOVE FROM SITE AND LEGALLY DISPOSE OF ALL ITEMS THE OWNER CHOOSES NOT TO ACCEPT.
7. WHERE EXISTING PIPING, WIRING ETC. ARE TO BE REMOVED FROM WALLS WHICH ARE REMAINING, THE WALLS SHALL BE REPAIRED TO MATCH ORIGINAL CONDITIONS.
8. WHERE EXISTING PIPING TO BE REMOVED PASSES THROUGH FLOORS, THEY SHALL BE CUT BACK TO WITHIN CONCRETE AND FILLED WITH GROUT TO ACHIEVE A SMOOTH AND EVEN FINISH WITH CONCRETE SURFACE.

PLUMBING FIXTURE SCHEDULE

Table with columns: DESIG., FIXTURE NAME, FIXTURE DESCRIPTION, MANUFACTURER, MODEL, SIZE, TRIM, ELECTRICAL ACCESSORY REQUIREMENTS, FLOW, WASTE, VENT, CW, HW, REMARKS. Lists fixtures like lavatory, sink, shower, water closet, and washer/wall box with their specifications.

PLUMBING SPECIALTY SCHEDULE

Table with columns: DESIG., FIXTURE TYPE, LOCATION, MANUFACTURER, MODEL #, REMARKS. Lists specialty fixtures like garbage disposal.

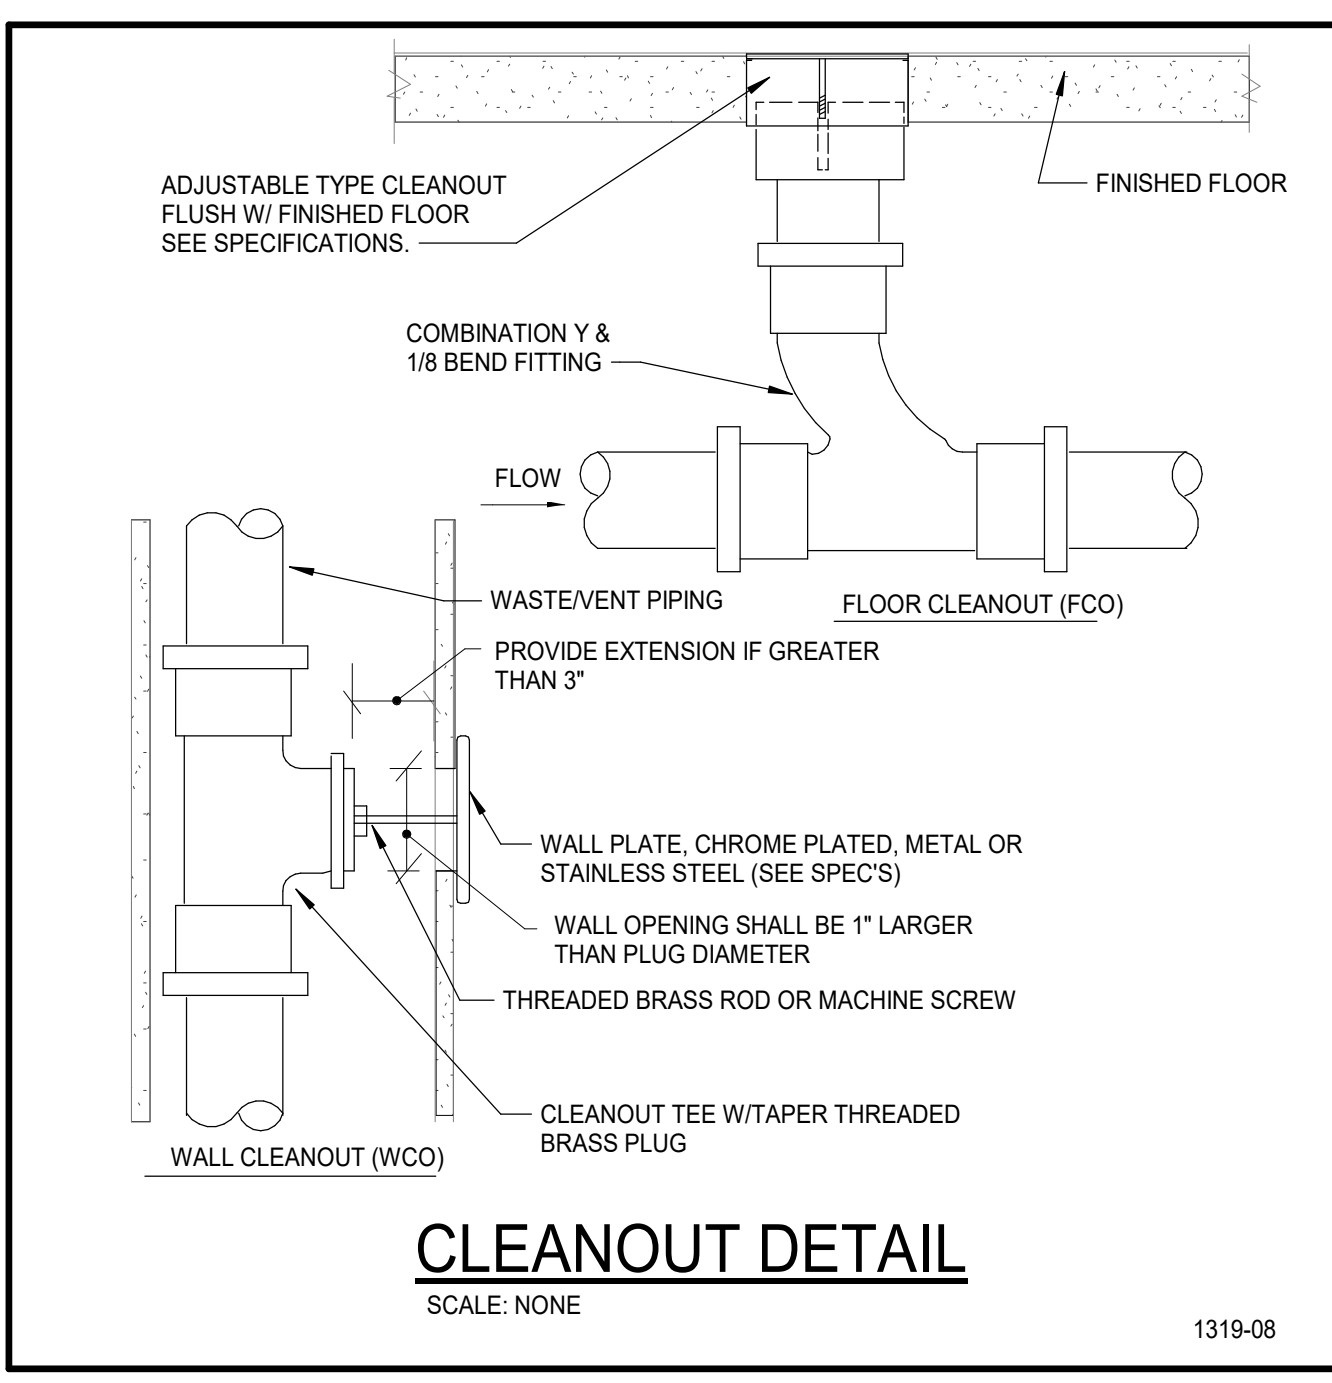

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Sheet: PLUMBING LEGENDS, NOTES & SCHEDULES



Project No: 23010-00 Drawn By: BS Checked By: LJ Date: 12/22/2023


Sheet No: P0.01

KEYNOTES

P5	REMOVE EXISTING COUNTER MOUNTED SINK AND FAUCET. REMOVE HW AND CW UP TO ABOVE CEILING. MAINTAIN FOR REUSE.
P6	REMOVE EXISTING WALL HUNG LAVATORY AND FAUCET. REMOVE EXISTING HW AND CW PIPING UP TO ABOVE CEILING. MAINTAIN FOR REUSE.
P7	REMOVE EXISTING FLOOR MOUNT WATER CLOSET. REMOVE EXISTING CW UP TO ABOVE CEILING. MAINTAIN FOR REUSE.
P8	REMOVE EXISTING COUNTER MOUNTED SINK AND FAUCET. REMOVE EXISTING HW AND CW PIPING UP TO ABOVE CEILING. MAINTAIN FOR REUSE.
P9	REMOVE EXISTING LAUNDRY SINK AND FAUCET. REMOVE ALL EXPOSED HW AND CW PIPING.
P10	REMOVE EXISTING SURFACE MOUNT WASHER VALVE BOX. REMOVE ALL EXPOSED HW AND CW PIPING. CAP EXISTING BELOW FLOOR.
P13	CONNECT TO EXISTING CW PIPING AND EXTEND TO NEW FIXTURE. MODIFY EXISTING PIPING AS REQUIRED TO MAKE A PROPER CONNECTION.
P14	CONNECT TO EXISTING HW PIPING AND EXTEND TO NEW FIXTURE. MODIFY EXISTING PIPING AS REQUIRED TO MAKE A PROPER CONNECTION.
P15	REMOVE EXISTING HW AND CW EXPOSED ON FLOOR BEHIND SINK, WASHER, AND DRYER. REMOVE TO BELOW FLOOR. MAINTAIN FOR REUSE.
P16	ACCESS EXISTING HW AND CW BELOW FLOOR SLAB. CONNECT TO EXISTING PIPING AND EXTEND UP INSIDE NEW WALL TO ABOVE NEW CEILING AND OVER TO NEW FIXTURES. MODIFY EXISTING PIPING AS REQUIRED TO MAKE PROPER CONNECTIONS.
P23	EXTEND NEW HOT WATER CIRCULATION LINE BACK TO NEAREST ACTIVE MAIN AND CONNECT. FIELD VERIFY LOCATION OF EXISTING PIPING.

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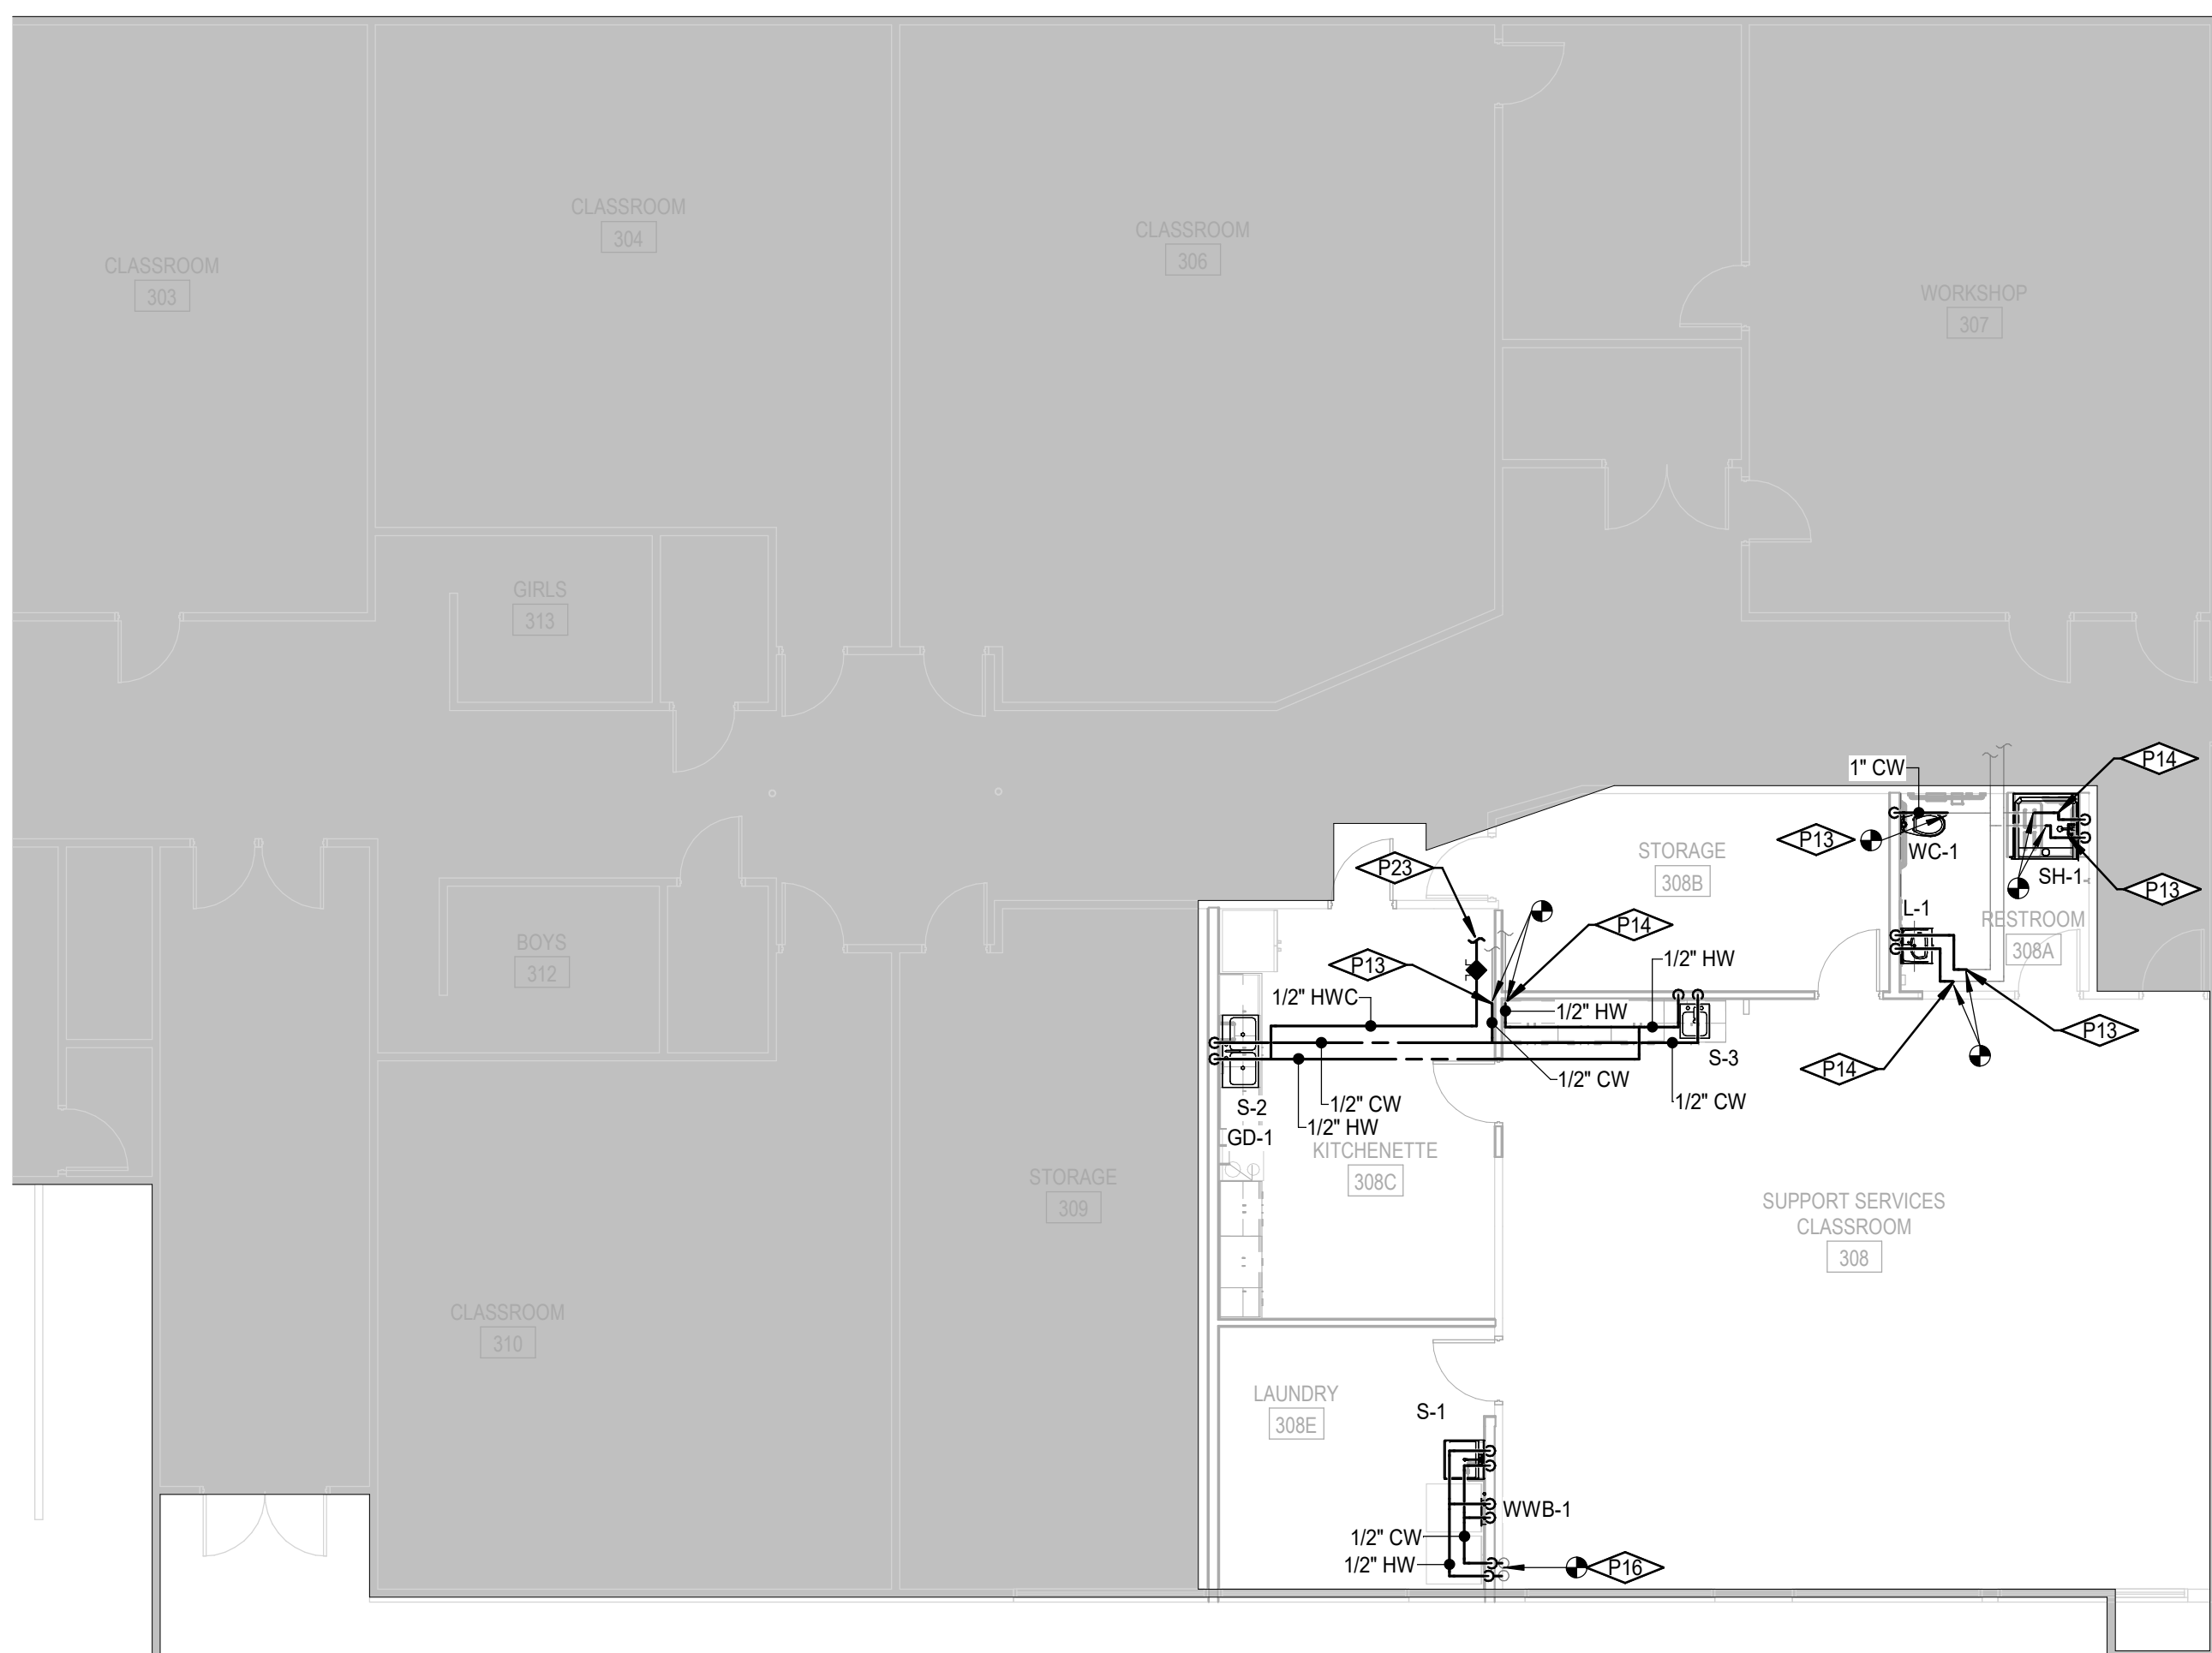


LEVEL 1 DOMESTIC WATER DEMOLITION PLAN
SCALE: 1/8" = 1'-0"

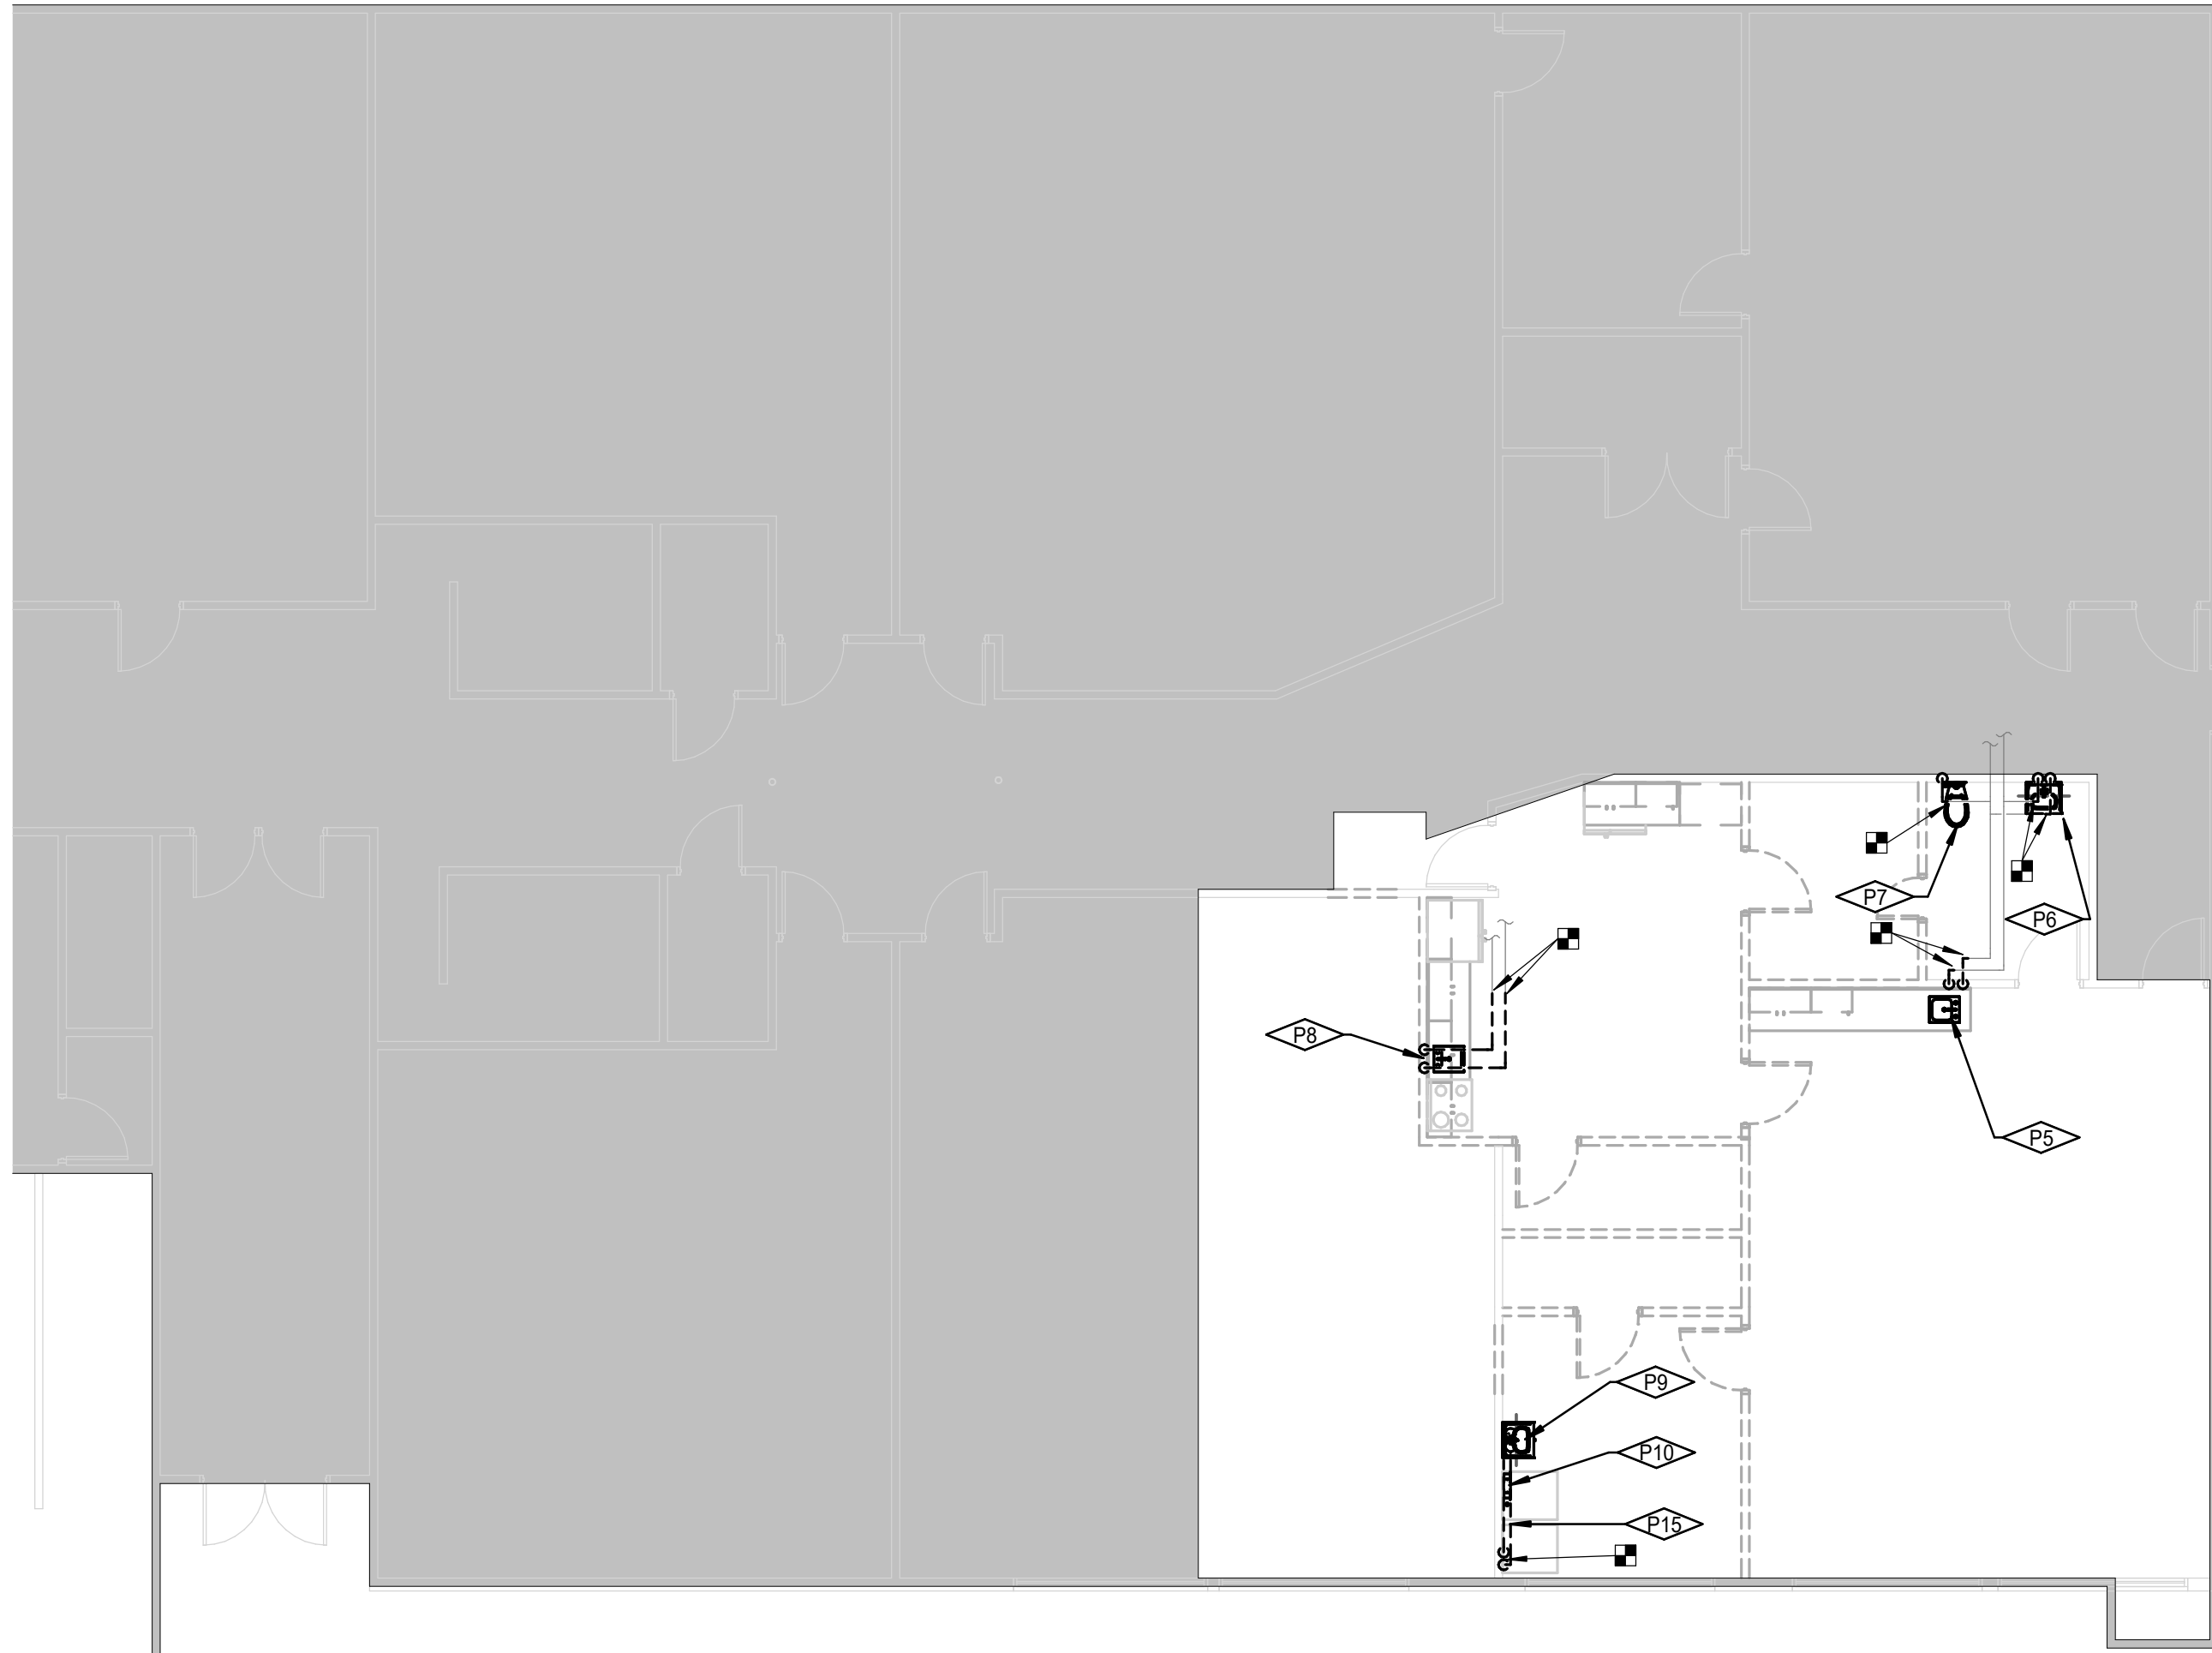
CONTRACTOR SHALL FIELD VERIFY THE LOCATIONS AND SIZES OF THE EXISTING DOMESTIC WATER PIPING.

C

D



LEVEL 1 DOMESTIC WATER PLAN
SCALE: 1/8" = 1'-0"

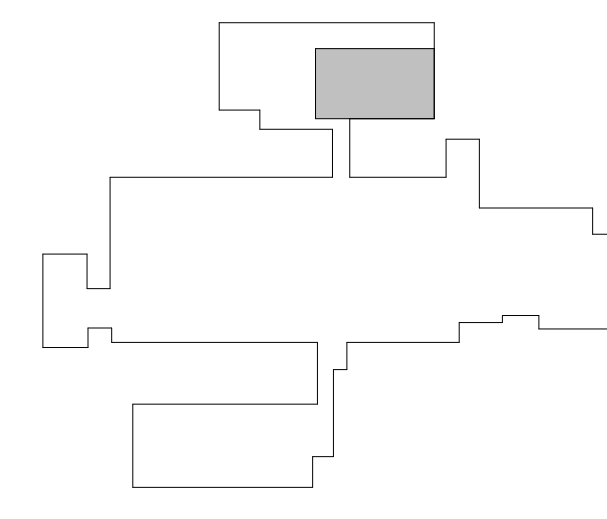

KEY PLAN
SCALE: NONE

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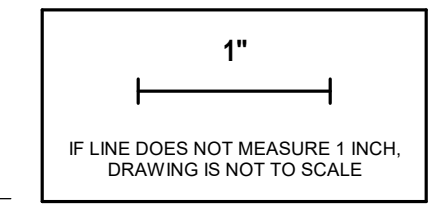
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Sheet:
LEVEL 1 DOMESTIC WATER PLANS



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Drawn By: BS
Checked By: LJ
Date: 12/22/2023

Sheet No: **P2.01**



KEYNOTES

P1	REMOVE EXISTING COUNTER MOUNTED SINK AND FAUCET. REMOVE EXISTING WASTE PIPING BACK INTO EXISTING WALL AND CAP.
P2	REMOVE EXISTING WALL HUNG LAVATORY AND FAUCET. REMOVE EXISTING WASTE PIPING BACK INTO EXISTING WALL AND CAP.
P3	REMOVE EXISTING FLOOR MOUNT WATER CLOSET. REMOVE EXISTING WASTE PIPING BELOW FLOOR AND CAP.
P4	REMOVE EXISTING COUNTER MOUNTED SINK AND FAUCET. REMOVE EXISTING WASTE PIPING BACK DOWN TO BELOW FLOOR SLAB AND CAP. REMOVE EXISTING VENT PIPING UP TO ABOVE CEILING. MAINTAIN VENT PIPING FOR RECONNECTION.
P11	REMOVE ALL EXPOSED WASTE PIPING TO DOWN BELOW THE EXISTING FLOOR AND CAP.
P12	REMOVE EXPOSED VENT PIPING UP TO JUST BELOW THE CEILING PENETRATION. MAINTAIN VENT PIPE FOR RECONNECTION.
P17	REMOVE EXISTING FLOOR SLAB AS REQUIRED TO CONNECT WASTE PIPING FROM NEW FIXTURE TO EXISTING WASTE PIPING. MODIFY EXISTING PIPING AS REQUIRED TO MAKE A PROPER CONNECTION. CONTRACTOR SHALL FIELD VERIFY LOCATION OF EXISTING WASTE PIPING UNDER SLAB PRIOR TO DEMOLITION. PROVIDE VERIFIED LOCATION TO ENGINEER.
P18	LOCATE NEW 1 1/2" WASTE PIPING ABOVE THE FLOOR INSIDE NEW WALL. TRANSITION TO 2" AND DROP BELOW EXISTING SLAB AND EXTEND TO EXISTING WASTE PIPING AS REQUIRED.
P19	REMOVE EXISTING LAUNDRY SINK AND FAUCET. REMOVE ALL EXPOSED WASTE AND VENT PIPING.
P20	REMOVE EXISTING SURFACE MOUNT WASHER VALVE BOX. REMOVE ALL EXPOSED WASTE AND VENT PIPING. CAP WASTE BELOW FLOOR.
P21	LOCATE NEW 2" WASTE PIPING FROM LAUNDRY SINK AND WASHER VALVE BOX DRAIN INSIDE NEW WALL. ACCESS EXISTING WASTE PIPING BELOW FLOOR AND CONNECT. MODIFY EXISTING PIPING AS REQUIRED TO MAKE A PROPER CONNECTION.
P24	CONNECT TO EXISTING VENT PIPING. MODIFY EXISTING PIPING AS REQUIRED TO MAKE A PROPER CONNECTION.

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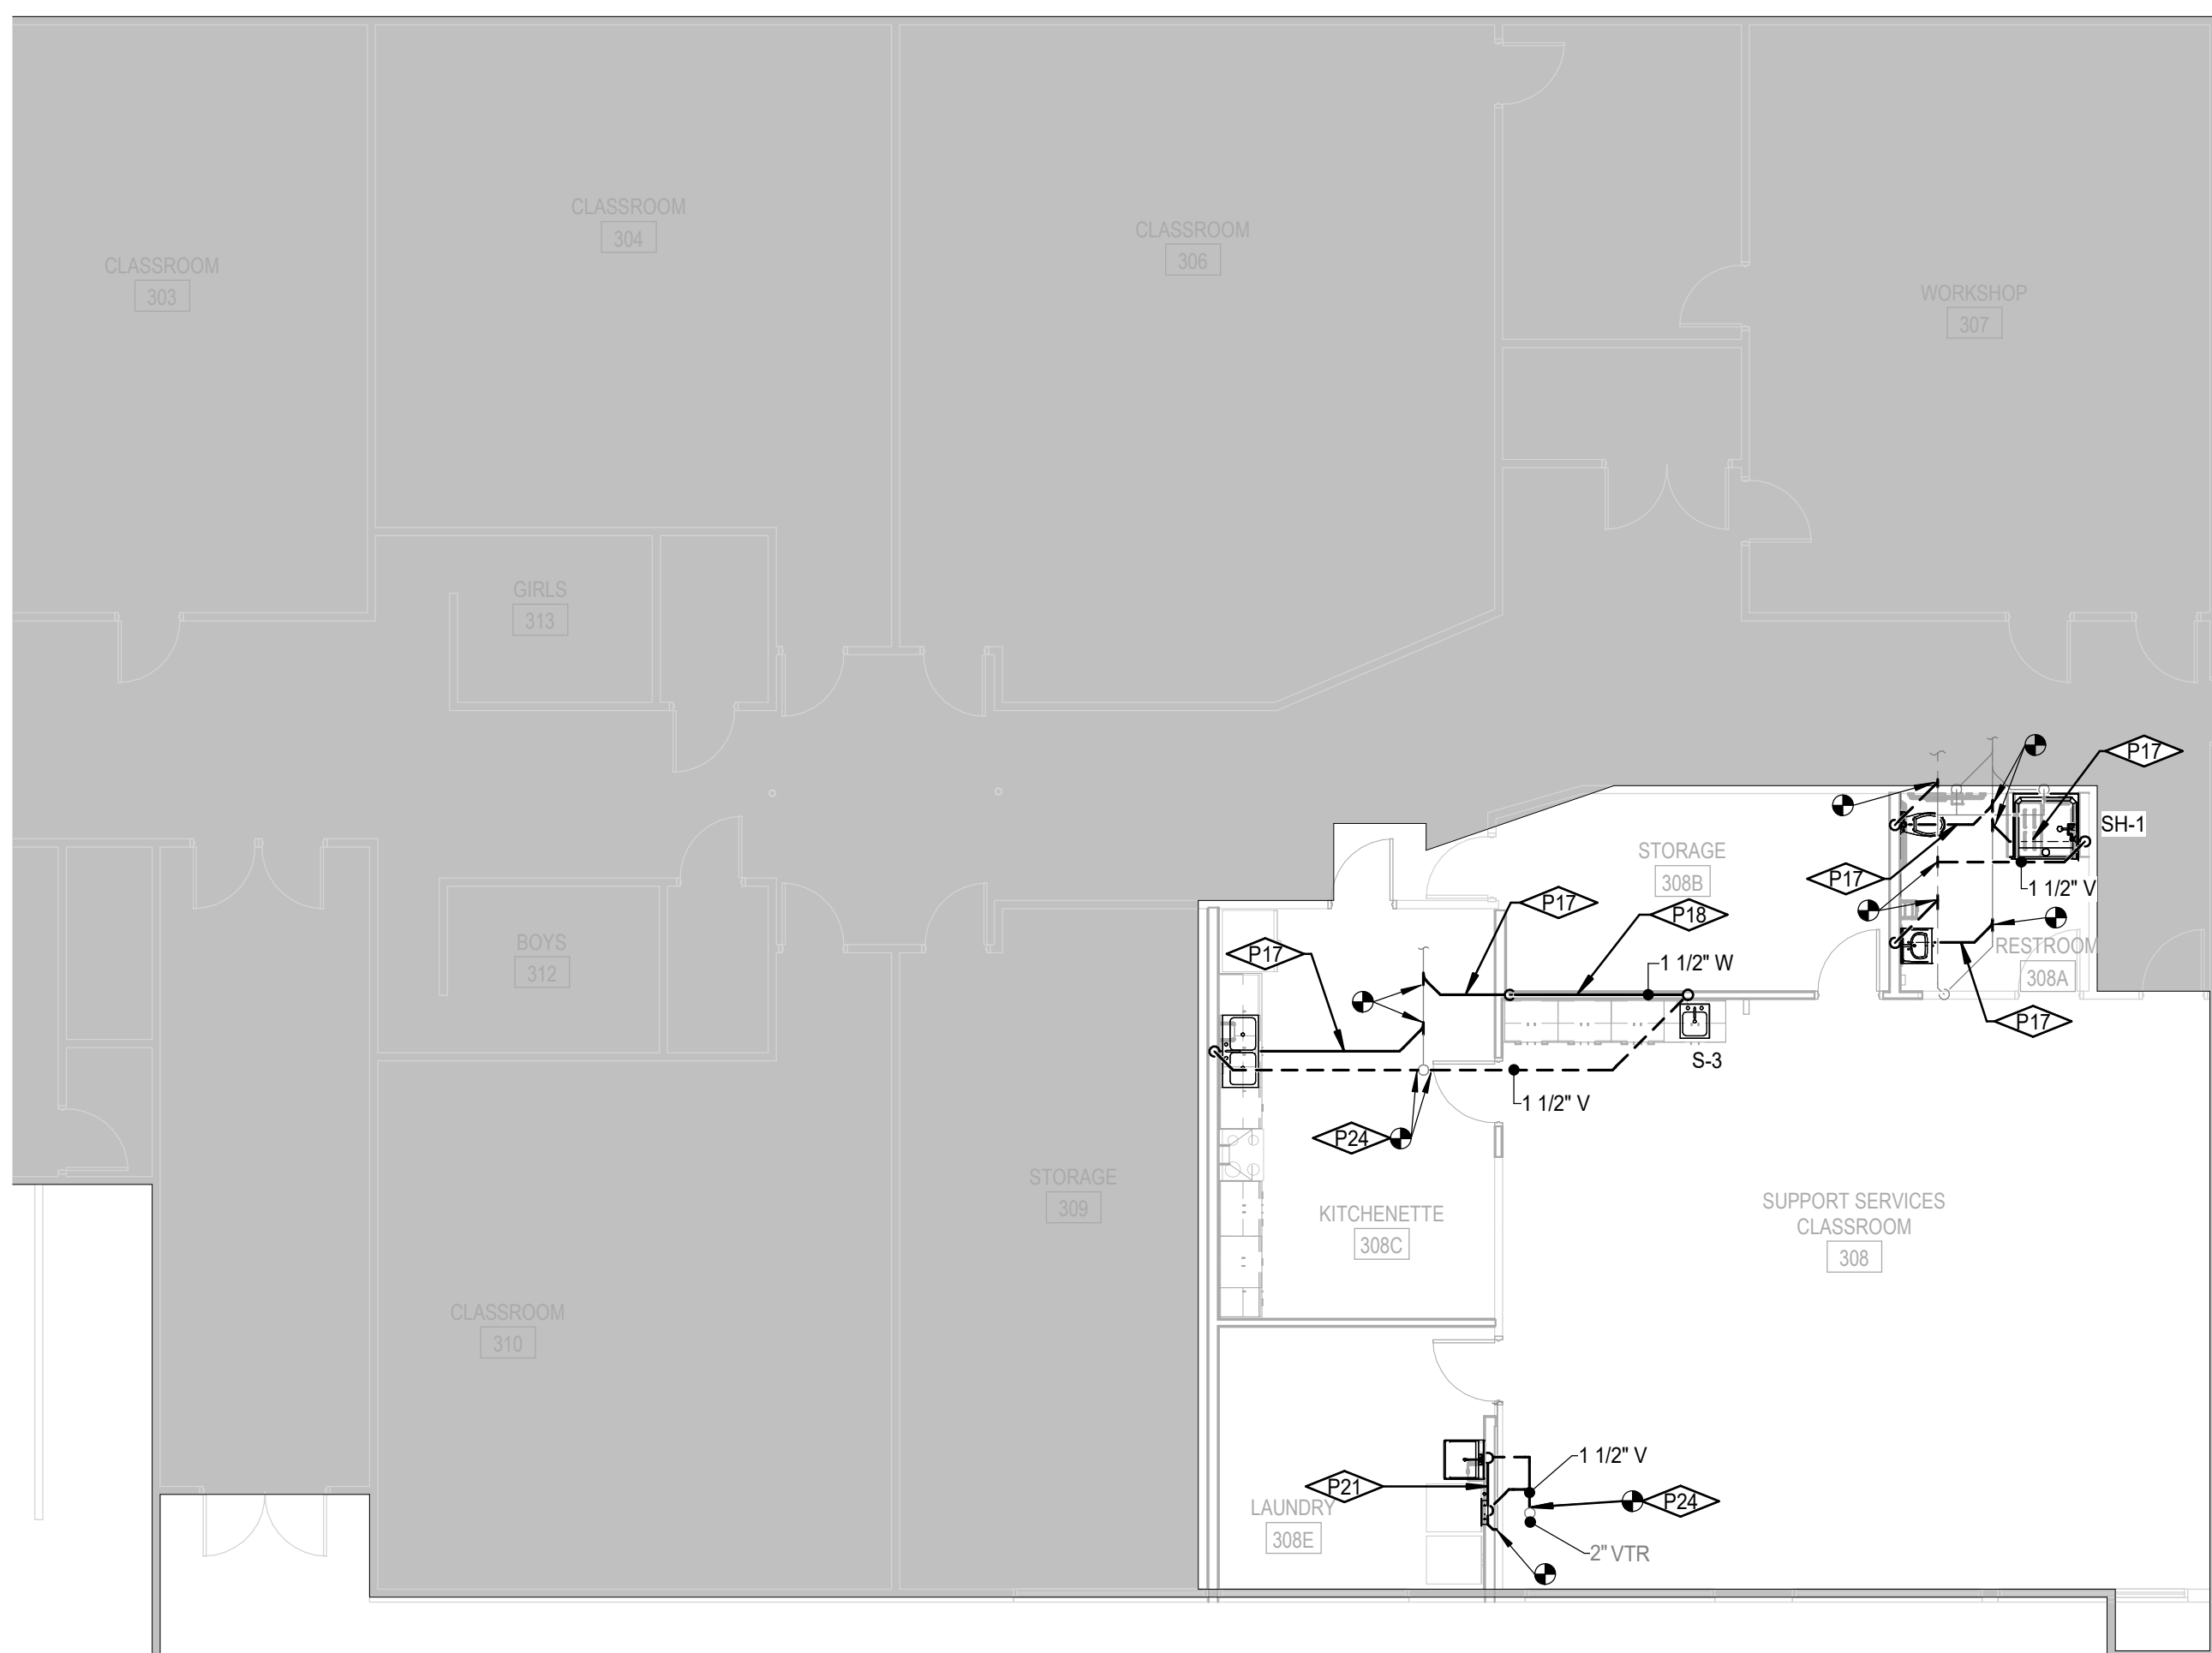


LEVEL 1 WASTE & VENT DEMOLITION PLAN
SCALE: 1/8" = 1'-0"

CONTRACTOR SHALL FIELD VERIFY THE LOCATIONS AND SIZES OF THE EXISTING WASTE AND VENT PIPING.

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LEVEL 1 WASTE & VENT PLAN
SCALE: 1/8" = 1'-0"


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Sheet:
LEVEL 1 WASTE & VENT PLANS

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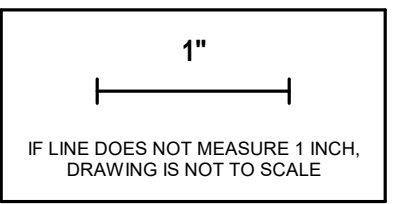


KEY PLAN
SCALE: NONE



Project No: 23010-00
Drawn By: BS
Checked By: LJ
Date: 12/22/2023

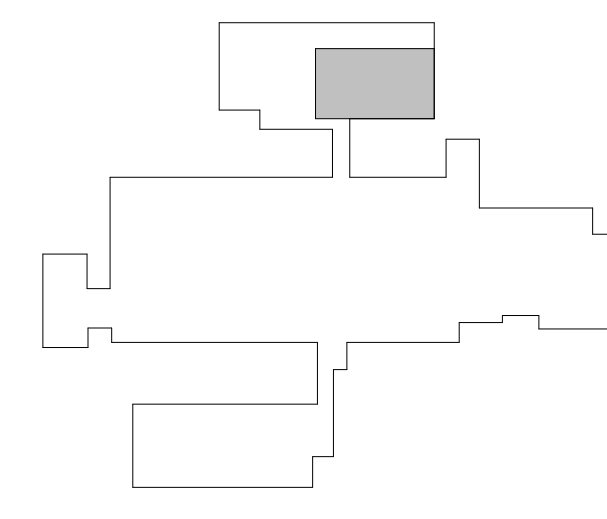Sheet No: **P2.11**



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POWER LEGEND
(Not all symbols listed below are used on these drawings)

SYMBOL	DESCRIPTION	SYMBOL	DESCRIPTION
◻	SINGLE RECEPTACLE	☑	ELECTRICAL PANELBOARD, CONTROL PANEL, OR OTHER CABINET AS NOTED
⦶	DUPLEX RECEPTACLE, WALL, CEILING, FLOOR MOUNTED	⎓	PLUG MOLD (MULTI-OUTLET ASSEMBLY)
⦶	DOUBLE DUPLEX RECEPTACLE, WALL, CEILING, FLOOR MOUNTED	◻	WIREDMOLD (SURFACE RACEWAY)
⦶	SPECIAL RECEPTACLE, WALL, CEILING, FLOOR MOUNTED	---	CONDUIT CONCEALED
⦶	JUNCTION BOX, WALL, CEILING, FLOOR MOUNTED	---	CONDUIT, UNDERGROUND OR CONCEALED IN FLOOR AS ALLOWED PER SPECIFICATIONS
⦶	DUPLEX RECEPTACLE, HALF CONTROLLED	⬅	CONDUIT TURNING DOWN
⦶	DUPLEX RECEPTACLE, FULL CONTROLLED	⬆	CONDUIT TURNING UP
⦶	DOUBLE DUPLEX RECEPTACLE, HALF CONTROLLED	⬆	CONDUIT CAPPED
⦶	DOUBLE DUPLEX RECEPTACLE, FULL CONTROLLED	⎓	GROUND BAR
⦶	SHADING INDICATES EMERGENCY SYSTEM INDICATES SWITCHING, UPPER CASE SUBSCRIPT INDICATES LUMINAIRE TYPE (TYP)	⎓	MAIN SWITCHBOARD/DISTRIBUTION CENTER
⦶	TROFFER - RECESSED	⎓	TRANSFORMER
⦶	SURFACE LUMINAIRE	⎓	CURRENT TRANSFORMER
⦶	LINEAR LUMINAIRE - RECESSED	⎓	THERMOSTAT
⦶	FIELD MEASURED LUMINAIRE LENGTH AND SHAPE DENOTED BY LINEWORK SUBSCRIPT IN RECTANGLE INDICATES LUMINAIRE TYPE	⎓	GENERATOR ANNUNCIATOR PANEL
⦶	DOWNLIGHT - RECESSED	⎓	UTILITY METER
⦶	DOWNLIGHT - SURFACE	⎓	POWER POLE
⦶	EXIT SIGN - CEILING MOUNTED		
⦶	EXIT SIGN - WALL MOUNTED (PUSH TO WALL)		
⦶	EXIT SIGN - WALL MOUNTED (PROJECTS FROM WALL)		
⦶	INDICATES EXIT SIGN FACES - SINGLE OR DOUBLE		
⦶	INDICATES EXIT SIGN CHEVRONS - LEFT/RIGHT OR BOTH		

LIGHTING LEGEND
(Not all symbols listed below are used on these drawings)

SYMBOL	DESCRIPTION	SYMBOL	DESCRIPTION
⦶	SHADING INDICATES EM SYSTEM, LOWER CASE SUBSCRIPT INDICATES SWITCHING, UPPER CASE SUBSCRIPT INDICATES LUMINAIRE TYPE (TYP)	☉	PENDANT LUMINAIRE - SINGLE SUSPENSION
⦶	TROFFER - RECESSED	☉	PENDANT LUMINAIRE - MULTIPLE SUSPENSION
⦶	SURFACE LUMINAIRE	☉	WALL MOUNTED LUMINAIRE
⦶	LINEAR LUMINAIRE - RECESSED	☉	IN-WALL LUMINAIRE
⦶	FIELD MEASURED LUMINAIRE LENGTH AND SHAPE DENOTED BY LINEWORK SUBSCRIPT IN RECTANGLE INDICATES LUMINAIRE TYPE	☉	POLE LUMINAIRE - ARM MOUNTED
⦶	DOWNLIGHT - RECESSED	☉	POLE LUMINAIRE - POST TOP
⦶	DOWNLIGHT - SURFACE	☉	BOLLARD
⦶	EXIT SIGN - CEILING MOUNTED	⎓	TRACK HEAD AND TRACK
⦶	EXIT SIGN - WALL MOUNTED (PUSH TO WALL)	⎓	EXTERIOR STAKE MOUNTED
⦶	EXIT SIGN - WALL MOUNTED (PROJECTS FROM WALL)	⎓	EMERGENCY LIGHTING UNIT - WALL MOUNTED
⦶	INDICATES EXIT SIGN FACES - SINGLE OR DOUBLE	⎓	EMERGENCY LIGHTING UNIT - CEILING MOUNTED
⦶	INDICATES EXIT SIGN CHEVRONS - LEFT/RIGHT OR BOTH	⎓	INDICATES DIRECTIONAL AIMING

CONTROLS LEGEND
(Not all symbols listed below are used on these drawings)

SYMBOL	DESCRIPTION	SYMBOL	DESCRIPTION
S ₁	SINGLE POLE SWITCH (SUBSCRIPT DENOTES SWITCHING)	S _{VS}	VARIABLE SPEEDSPEED CONTROLLER SWITCH
S ₂	TWO POLE SWITCH	S _{IP}	EXPLOSION PROOF SWITCH
S ₃	THREE-WAY SWITCH	S _{TO}	THERMAL OVERLOAD SWITCH
S ₄	FOUR-WAY SWITCH	S _{MC}	MOMENTARY CONTACT SWITCH
S _K	KEY OPERATED SWITCH	S _{SC}	COMBINATION SWITCH AND DUPLEX RECEPTACLE
S _M	MANUAL SWITCH, HORSEPOWER RATE	☉	PHOTOCELL
S _D	DIMMER SWITCH	⏏	PUSH BUTTON
S _{PL}	SWITCH WITH PILOT LIGHT PILOT LIGHT IS ON WHEN SWITCH IS ON	⌚	TIME CLOCK
S _P	SWITCH WITH PILOT LIGHT LOCATOR (CONTINUOUSLY LIGHTED HANDLE)	☉	OCCUPANCY SENSOR - WALL MOUNTED (IR-INFRARED), UL-INFRARED, UL-THERMISTOR, UL-DUAL TECHNOLOGY
S _V	LOW VOLTAGE SWITCH		

FIRE ALARM SYSTEM LEGEND
(Not all symbols listed below are used on these drawings)

SYMBOL	DESCRIPTION	SYMBOL	DESCRIPTION
⎓	FIRE ALARM CONTROL PANEL	⎓	MANUAL PULL STATION
⎓	FIRE ALARM (NAC) POWER SUPPLY	⎓	ADDRESSABLE INPUT MODULE
⎓	FIRE ALARM REMOTE ANNUNCIATOR PANEL (LCD)	⎓	ADDRESSABLE OUTPUT MODULE
⎓	FIRE ALARM ANNUNCIATOR PANEL (LED)	⎓	FIRE ALARM STROBE (0dB= CANDELA RATING 15, 30, 75, 95, 110, 177)
⎓	FIRE ALARM TRANSDUCER PANEL	⎓	MASS NOTIFICATION STROBE (0dB= CANDELA RATING 15, 30, 75, 95, 110, 177)
⎓	RESCUE ASSISTANCE SYSTEM BASE UNIT	⎓	FIRE ALARM HORN/VISIBLE (C = CEILING MOUNT)
⎓	AREA OF REFUGES COMMUNICATION MASTER UNIT	⎓	FIRE ALARM SPEAKER/VISIBLE (C = CEILING MOUNT)
⎓	AREA OF REFUGES COMMUNICATION REMOTE UNIT	⎓	MASS NOTIFICATION SPEAKER/VISIBLE (C = CEILING MOUNT)
⎓	GRAPHIC ZONE MAP	⎓	FIRE ALARM HORN (C = CEILING MOUNT)
⎓	FIRE FIGHTER SMOKE CONTROL PANEL	⎓	FIRE ALARM SPEAKER (C = CEILING MOUNT)
⎓	SMOKE DETECTOR (P-PHOTOELECTRIC, SB-WITH SOUNDER BASE, BR-BEAM RECEIVER, BT-BEAM TRANSMITTER)	⎓	MASS NOTIFICATION SPEAKER (C = CEILING MOUNT)
⎓	SMOKE ALARM (120 VAC SINGLE STATION)	⎓	RESCUE ASSISTANCE TELEPHONE STATION
⎓	HEAT DETECTOR (F = FIXED TEMPERATURE, R = RATE OF RISE)	⎓	FIRE FIGHTER TELEPHONE (J = JACK, H = HANDSET)
⎓	DUCT SMOKE DETECTOR S-SUPPLY, R-RETURN	⎓	MAGNETIC DOOR HOLD
⎓	DUCT DETECTOR REMOTE INDICATOR ALARM AND TEST	⎓	TAMPER SWITCH
⎓	REMOTE INDICATOR LIGHT	⎓	FLOW DETECTOR SWITCH
⎓	FIRE/SMOKE DAMPER	⎓	PRESSURE SWITCH
⎓	SMOKE DAMPER	⎓	SURGE SUPPRESSOR
⎓	CARBON MONOXIDE ALARM/DETECTOR	⎓	FLAME DETECTOR (UV-ULTRAVIOLET, IR-INFRARED)

REFERENCE SYMBOLS LEGEND
(Not all symbols listed below are used on these drawings)

SYMBOL	DESCRIPTION	SYMBOL	DESCRIPTION
⬇	KEY NOTE REFERENCE	⎓	KITCHEN/OWNER/MEDICAL EQUIPMENT REFERENCE
⎓	TYPICAL CIRCUIT NUMBER	⎓	EXISTING TO REMAIN
⎓	TYPICAL LUMINAIRE TYPE	⎓	EXISTING TO BE REMOVED
⎓	TYPICAL ROOM REFERENCE (TOP = RM #, BOTTOM = FLR)	⎓	EXISTING TO BE RELOCATED
⎓	MECHANICAL EQUIPMENT REFERENCE	⎓	EXISTING TO REMAIN - REPLACE DEVICE
⎓	LIGHTING CONTROL / EQUIPMENT REFERENCE	⎓	EXISTING TO BE REMOVED AND REPLACED
⎓	ELECTRICAL ACCESSORIES REFERENCE		

ONE-LINE DIAGRAM LEGEND
(Not all symbols listed below are used on these drawings)

SYMBOL	DESCRIPTION	SYMBOL	DESCRIPTION
⎓	DISCONNECT SWITCH	⎓	PANELBOARD "A"
⎓	DISCONNECT SWITCH, FUSED	⎓	EM-ENERGY METER, PMH-POWER METER, CM-CIRCUIT MONITOR
⎓	CIRCUIT BREAKER	⎓	VOLTMETER TEST SWITCH
⎓	FUSE	⎓	AMMETER TEST SWITCH
⎓	GROUND	⎓	VOLTMETER
⎓	STEP DOWN TRANSFORMER, ## INDICATES KVA	⎓	AMMETER
⎓	K-RATED STEP DOWN TRANSFORMER ## INDICATES KVA, # INDICATES K RATING	⎓	SEE FEEDER/CM/TRANSFORMER SCHEDULES FOR FEEDER SIZE
⎓	CURRENT TRANSFORMER	⎓	ENGINE GENERATOR
⎓	POTENTIAL TRANSFORMER	⎓	CONTACTOR/RELAY/CAPACITOR (AS NOTED)
⎓	SERVICE ENTRANCE TRANSFORMER	⎓	TRANSFER SWITCH - ATS-AUTOMATIC, MTS-MANUAL
⎓	METER	⎓	GROUND FAULT INTERRUPTER
⎓	EQUIPMENT ENCLOSURE	⎓	SURGE PROTECTIVE DEVICE
⎓	SERVICE WEATHERHEAD	⎓	SHUNT TRIP
⎓	SHORT CIRCUIT CURRENT AVAILABLE	⎓	TERMINATIONS LB-LOAD BREAK, NLB=NO LOAD BREAK
⎓	KIRK KEY INTERLOCK, SUBSCRIPT INDICATES INTERLOCKED GROUP	⎓	DRAW-OUT DEVICE
⎓	ELECTRICAL INTERLOCK, SUBSCRIPT INDICATES INTERLOCKED GROUP	⎓	PLUG-IN DEVICE
⎓	MECHANICAL INTERLOCK	⎓	ELECTRICALLY OPERATED

ABBREVIATIONS LEGEND
(Not all symbols listed below are used on these drawings)

SYMBOL	DESCRIPTION	SYMBOL	DESCRIPTION
A	AMPERES	MCP	MOTOR CIRCUIT PROTECTOR
AC	ABOVE COUNTER, MOUNT HORIZONTALLY TO CENTERLINE OF DEVICE, "B" ABOVE COUNTER OR BACK SPLASH	MCC	SEE MECHANICAL EQUIPMENT SCHEDULE
AF	ABOVE FINISHED FLOOR	MIN	MINIMUM
AFG	ABOVE FINISHED GRADE	MLO	MAIN LUGS ONLY
ANN	ANNUNCIATOR	MTS	MANUAL TRANSFER SWITCH
ARF	ABOVE RAISED FLOOR	NC	NORMALLY CLOSED
ASSD	AIR SAMPLING SMOKE DETECTION	NTC	NOT IN CONTRACT
ATS	AUTOMATIC TRANSFER SWITCH	NL	NIGHT LIGHT
BFG	BELOW FINISHED GRADE	NO	NORMALLY OPEN
C	CONDUIT	NTS	NOT TO SCALE
CAV	CABLE TELEVISION	OC	ON CENTER
CB	CIRCUIT BREAKER	OCFI	OWNER FURNISHED, CONTRACTOR INSTALLED
CCV	CLOSED CIRCUIT TELEVISION	OFWI	OWNER FURNISHED, OWNER INSTALLED
(E)	EXISTING	OSWF	ON SITE WORK FORCE
EM	EMERGENCY	PB	PULL BOX
EMCC	EMERGENCY MAIN DISTRIBUTION CENTER	SB	STAND-BY
EP	EXPLOSION PROOF	SDC	SUB-DISTRIBUTION CENTER
EPO	EMERGENCY POWER OFF	TP	TAMPER PROOF
EVO	EMERGENCY VENTILATION ON/OFF	TVSS	TRANSIENT VOLTAGE SURGE SUPPRESSOR
EWC	ELECTRIC WATER COOLER	TYP	TYPICAL
FA	FIRE ALARM	UF	UNDER FLOOR
G	GROUND	UG	UNDER GROUND
GPC	GENERATOR CONTROL PANEL	UON	UNLESS OTHERWISE NOTED
GFCI	GROUND FAULT CIRCUIT INTERRUPTER	UPS	UNINTERRUPTIBLE POWER SUPPLY
HDA	HAND OFF AUTOMATIC	V	VOLTS
IG	ISOLATED GROUND	VFD	VARIABLE FREQUENCY DRIVE
MAX	MAXIMUM	WT	WITH
MCB	MAIN CIRCUIT BREAKER	WO	WITHOUT
MCC	MOTOR CONTROL CENTER	WP	WEATHER PROOF
MDC	MAIN DISTRIBUTION CENTER	XFR	TRANSFORMER

ONE-LINE DIAGRAM LEGEND
(Not all symbols listed below are used on these drawings)

SYMBOL	DESCRIPTION	SYMBOL	DESCRIPTION
⎓	DISCONNECT SWITCH	⎓	PANELBOARD "A"
⎓	DISCONNECT SWITCH, FUSED	⎓	EM-ENERGY METER, PMH-POWER METER, CM-CIRCUIT MONITOR
⎓	CIRCUIT BREAKER	⎓	VOLTMETER TEST SWITCH
⎓	FUSE	⎓	AMMETER TEST SWITCH
⎓	GROUND	⎓	VOLTMETER
⎓	STEP DOWN TRANSFORMER, ## INDICATES KVA	⎓	AMMETER
⎓	K-RATED STEP DOWN TRANSFORMER ## INDICATES KVA, # INDICATES K RATING	⎓	SEE FEEDER/CM/TRANSFORMER SCHEDULES FOR FEEDER SIZE
⎓	CURRENT TRANSFORMER	⎓	ENGINE GENERATOR
⎓	POTENTIAL TRANSFORMER	⎓	CONTACTOR/RELAY/CAPACITOR (AS NOTED)
⎓	SERVICE ENTRANCE TRANSFORMER	⎓	TRANSFER SWITCH - ATS-AUTOMATIC, MTS-MANUAL
⎓	METER	⎓	GROUND FAULT INTERRUPTER
⎓	EQUIPMENT ENCLOSURE	⎓	SURGE PROTECTIVE DEVICE
⎓	SERVICE WEATHERHEAD	⎓	SHUNT TRIP
⎓	SHORT CIRCUIT CURRENT AVAILABLE	⎓	TERMINATIONS LB-LOAD BREAK, NLB=NO LOAD BREAK
⎓	KIRK KEY INTERLOCK, SUBSCRIPT INDICATES INTERLOCKED GROUP	⎓	DRAW-OUT DEVICE
⎓	ELECTRICAL INTERLOCK, SUBSCRIPT INDICATES INTERLOCKED GROUP	⎓	PLUG-IN DEVICE
⎓	MECHANICAL INTERLOCK	⎓	ELECTRICALLY OPERATED

TECHNOLOGY LEGEND
(Not all symbols listed below are used on these drawings)

SYMBOL	DESCRIPTION	SYMBOL	DESCRIPTION
⎓	WALL FIELD	⎓	CEILING MOUNTED OUTLET (# = QTY OF CABLES, XXX = SEE BELOW)
⎓	TELECOM GROUND BAR	AV	AUDIO VISUAL
⎓	WIRE BASKET TRAY	SEC	SECURITY
⎓	CABLE TRAY	WAP	WIRELESS ACCESS POINT
⎓	J-HOOK PATHWAY	PRJ	PROJECTOR
⎓	FLOOR SPACE BOX DATA OUTLET (# = QTY OF CABLES)		
⎓	POKE-THRU (# = QTY OF CABLES)		
⎓	DATA OUTLET (# = QTY OF CABLES, XXX = SEE BELOW, ZZ = ELEVATION)		
⎓	CEILING MOUNTED TELEVISION COAXIAL OUTLET		
⎓	CEILING MOUNTED TELEVISION COAXIAL OUTLET		
⎓	FLOOR JBOX		
⎓	POKE THRU (XXX = SEE BELOW)		
⎓	FF = FURNITURE FEED	AV	AUDIO VISUAL
⎓	WALL MOUNTED JBOX (XXX = SEE BELOW, ZZ = ELEVATION)		
⎓	GLG = CEILING	AV	AUDIO VISUAL
⎓	PULLBOX (YY = SIZE)		
⎓	CLOCK OUTLET (XXX = SEE BELOW)		
⎓	DS = DOUBLE SIDED		
⎓	DIGITAL (PROVIDE 1 CAT 6 CONNECTION)		
⎓	A = ANALOG		
⎓	COMBINATION CLOCK/SPEAKER OUTLET (XXX = SEE BELOW)		
⎓	A = ANALOG	D	DIGITAL
⎓	CEILING MOUNTED CLOCK		
⎓	DISTRIBUTED ANTENNA SYSTEM		
⎓	WIRELESS ACCESS POINT ENCLOSURE		
⎓	EQUIPMENT RACK		
⎓	WIRE MANAGER		
⎓	CABINET		

AUDIO VISUAL LEGEND
(Not all symbols listed below are used on these drawings)

SYMBOL	DESCRIPTION	SYMBOL	DESCRIPTION
⎓	CEILING MOUNTED SPEAKER (# = TYPE #)	⎓	FLOOR POKE THRU (XXX = SEE BELOW)
⎓	WALL MOUNTED SPEAKER	⎓	CTRL = CONTROL UNIT
⎓	DISPLAY (XX = SIZE OF SCREEN = ELEVATION)	⎓	IO = INPUT/OUTPUT PLATE
⎓	SCHEDULER : (= ELEVATION)	⎓	SOUND SHOWER SPEAKER
⎓	CONTROL UNIT : (= ELEVATION)	⎓	PARTITION SENSOR (ZZ = ELEVATION)
⎓	INPUT/OUTPUT PLATE : (= ELEVATION)	⎓	TELEVISION COAXIAL CABLE (ZZ = ELEVATION)
⎓	MICROPHONE OUTLET : (= ELEVATION)	⎓	CEILING MOUNTED TELEVISION COAXIAL OUTLET
⎓	PROJECTOR	⎓	VOLUME CONTROL
		⎓	HIGH DEFINITION MULTIMEDIA INTERFACE

OVERHEAD PAGING/SOUNDMASKING LEGEND
(Not all symbols listed below are used on these drawings)

SYMBOL	DESCRIPTION	SYMBOL	DESCRIPTION
⎓	WALL FIELD	⎓	SOUND MASKING SPEAKER FLUSH MOUNT (XXX = SEE BELOW)
⎓	CEILING MOUNTED ZONE SPEAKER (Z = ZONE #)	⎓	FM = PENDANT MOUNT
⎓	VOLUME CONTROL OUTLET	⎓	FM = FLUSH MOUNT
⎓	MICROPHONE STATION	⎓	SOUND SHOWER SPEAKER
⎓	INTERCOM STATION	⎓	HORN SPEAKER
⎓	CALL BUTTON	⎓	SURFACE SPEAKER

LIGHTING PLAN NOTES:

- REFER TO ARCHITECTURAL ELEVATIONS AND REFLECTED CEILING PLANS FOR EXACT MOUNTING LOCATIONS OF DEVICES AND LUMINAIRES.
- COORDINATE LUMINAIRE LOCATIONS WITH MECHANICAL PIPING, DUCTWORK, ETC. TO AVOID CONFLICTS. SEE SPECIFICATIONS FOR COORDINATION REQUIREMENTS.
- PROVIDE A DEDICATED NEUTRAL CONDUCTOR FOR EACH 120V AND 277V CIRCUIT.
- CIRCUITS MAY BE COMBINED INTO HOMERUNS OF UP TO SIX (6) CURRENT CARRYING CONDUCTORS INCLUDING NEUTRALS UNLESS OTHERWISE INDICATED. WHERE CIRCUITS ARE COMBINED WITHIN A SINGLE CONDUIT, PROVIDE STRIPING FOR FULL LENGTH OF NEUTRAL CONDUCTOR INSULATION TO MATCH THE COLOR CODE OF THE ASSOCIATED PHASE CONDUCTOR. SEE SPECIFICATION FOR COLOR CODES.
- FIELD COORDINATE EXACT LOCATION OF CEILING MOUNTED OCCUPANCY SENSING DEVICES PER MANUFACTURER'S INSTRUCTIONS. OCCUPANCY/VACANCY SENSING DEVICES ARE SHOWN FOR GENERAL DESIGN INTENT ONLY. CONTRACTOR SHALL PROVIDE THE TYPE AND QUANTITY OF OCCUPANCY/VACANCY SENSING DEVICES AS NECESSARY FOR PROPER COVERAGE AND CONTROL OF LUMINAIRES WHERE INDICATED ON THE LIGHTING PLANS. FIELD ADJUSTMENT TO DEVICE LOCATIONS SHALL BE MADE AS REQUIRED TO CAPTURE ALL OCCUPANTS, WHETHER SITTING AT A DESK OR MOVING AROUND THE SPACE. ADDITIONAL DEVICES SHALL BE PROVIDED AND FIELD ADJUSTMENTS SHALL BE MADE AS NECESSARY, AT NO ADDITIONAL COST TO OWNER. CONTRACTOR SHALL PROVIDE A COMPLETE AND OPERATIONAL SYSTEM.

DEMOLITION NOTES:

- UNLESS NOTED OTHERWISE, BOLD ITEMS INDICATE EQUIPMENT, DEVICES, ETC. TO BE REMOVED. SEE SECTION 260500 FOR REMODEL/DEMOLITION DETAILED REQUIREMENTS.
- DEMOLITION DRAWINGS MAY NOT SHOW EVERY ITEM TO BE DEMOLISHED. CONTRACTOR SHALL VISIT SITE TO DETERMINE AND COORDINATE THE EXACT EXTENT OF DEMOLITION TO FACILITATE ALL WORK INDICATED BY THE CONTRACT DOCUMENTS PRIOR TO QUOTATION. NO EXTRAS WILL BE ALLOWED FOR WORK REQUIRED TO ACHIEVE THE END RESULT AS INDICATED BY THE CONTRACT DOCUMENTS. REWORK EXISTING TERMINATIONS, CONNECTIONS, CONDUIT, WIRING, ETC. TO ACCEPT NEW WORK. MAINTAIN CIRCUIT CONTINUITY TO EXISTING CIRCUITS AND DEVICES TO REMAIN OR REMODEL/DEMOLITION DETAILED REQUIREMENTS TO BE RELOCATED. PRIOR TO COMMENCEMENT OF ANY DEMO WORK, CONFIRM EXISTING CONDITIONS AND NOTIFY ENGINEER OF ANY DISCREPANCIES FOR RESOLUTION.
- ALL ITEMS IDENTIFIED TO BE REMOVED SHALL BE REMOVED IN THEIR ENTIRETY INCLUDING ALL WIRING AND EXPOSED CONDUIT AND CONDUIT SUPPORTS BACK TO POINT OF ORIGIN OR NEXT DEVICE TO REMAIN. REMOVED ITEMS SHALL BE TURNED OVER TO THE OWNER, UNLESS NOTED OTHERWISE, AND STORED IN THE AREA DESIGNATED BY THE OWNER. REMOVE FROM SITE AND LEGALLY DISPOSE OF ALL ITEMS THE OWNER CHOOSES NOT TO ACCEPT.
- REUSE EXISTING CONDUIT WHERE CURRENT NEC AND LOCAL CODE REQUIREMENTS ARE MAINTAINED. PROVIDE NEW CONDUIT AND WIRE FOR NEW INSTALLATIONS AND EXTENSION OF EXISTING INSTALLATIONS. REUSE EXISTING CONDUIT IN PLACE. DO NOT REINSTALL EXISTING CONDUIT. PROVIDE LABELING PER SPECIFICATIONS FOR REUSED CONDUIT.
- WHERE EXISTING DEVICES, SWITCHES, MOTOR CONNECTIONS, ETC. ARE TO BE REMOVED FROM WALLS WHICH ARE REMAINING, WALLS SHALL BE PATCHED TO MATCH ORIGINAL FINISH. BLANK COVERPLATES OVER EXISTING BOXES ARE NOT ACCEPTABLE. UNLESS NOTED OTHERWISE.

ONE-LINE DIAGRAM NOTES:

- PANELBOARDS INDICATED ON ONE-LINE DIAGRAMS DO NOT SHOW ALL BRANCH CIRCUITS. REFER TO PANELBOARD SCHEDULE(S).
- PROVIDE CONTINUOUS #10 AWG INSULATED COPPER CONDUCTOR FOR BONDING THE EQUIPMENT GRINDING TERMINAL BUSES OF THE NORMAL AND ESSENTIAL BRANCH CIRCUIT PANELBOARDS SERVING THE SAME INDIVIDUAL PATIENT VIGNET.
- ADJUSTABLE BREAKERS SHALL BE SOLID STATE TRIP. CIRCUIT BREAKER TRIP FUNCTIONS:
L=LONG TIME
S=SHORT TIME
H=INSTANTANEOUS
G=GROUND FAULT
Z=ZONE SELECT INTERLOCK
A=GROUND FAULT ALARM ONLY
- EXISTING ONE-LINE DIAGRAM TAKEN FROM OWNER FURNISHED DRAWINGS. EXISTING INFORMATION SHOWN OTHER THAN LOCATIONS IMPACTED BY NEW WORK HAS NOT BEEN VERIFIED.
- COORDINATE MOUNTING, CONDUIT, WIRE, AND OCPD SIZE FOR SPD'S WITH MANUFACTURER'S INSTALLATION INSTRUCTIONS.

GENERAL NOTES:

- FOR REMODELING, WORK INCLUDED IS DENOTED IN BOLD. EXISTING CONDITIONS TO REMAIN ARE DENOTED LIGHTLY.
- PROTECT STRUCTURE AND OWNER EQUIPMENT FROM DAMAGE. IMMEDIATELY REPLACE OR REPAIR, TO ORIGINAL CONDITION, DAMAGE CAUSED BY THE CONTRACTOR WHETHER EQUIPMENT APPEARS TO BE CURRENTLY IN USE OR NOT, UNLESS WRITTEN AUTHORIZATION FROM THE OWNER INDICATED OTHERWISE. PREPARE LISTING OF ALL EXISTING DAMAGED ITEMS AND SUBMIT TO OWNER PRIOR TO BEGINNING WORK.
- INSTALL CONDUIT CONCEALED IN FINISHED AREAS UNLESS OTHERWISE NOTED. PAINT EXPOSED CONDUIT TO MATCH EXISTING FINISHES WITHIN THE SURROUNDING AREA.
- COORDINATE EXACT REQUIREMENTS AND LOCATIONS OF MECHANICAL EQUIPMENT WITH MECHANICAL DRAWINGS AND MECHANICAL CONTRACTOR PRIOR TO ROUGH-IN AND ORDERING MATERIALS OR EQUIPMENT.
- EXISTING INFORMATION SHOWN ON THE DRAWINGS HAS BEEN TAKEN FROM OWNER FURNISHED DRAWINGS AND/OR LIMITED FIELD OBSERVATIONS. CATOR, RUMA & ASSOCIATES IS NOT RESPONSIBLE FOR THE ACCURACY OF ANY INFORMATION OR THE ADEQUACY, SAFETY AND CONFORMANCE TO CURRENT PREVALING CODES OF ANY WORK SHOWN AS EXISTING ON THESE DRAWINGS.
- PROVIDE SEPARATE INSULATED EQUIPMENT GROUNDING CONDUCTOR IN ALL FEEDER, HOMERUN AND BRANCH CIRCUITS.

POWER PLAN NOTES:

- MAKE ALL FINAL ELECTRICAL CONNECTIONS TO EQUIPMENT INCLUDING ELECTRICAL CONNECTION. THIS SHALL INCLUDE BUT NOT BE LIMITED TO ALL MECHANICAL AND OTHER EQUIPMENT INCLUDED IN THIS PROJECT.
- COORDINATE EXACT REQUIREMENTS AND LOCATIONS OF MECHANICAL EQUIPMENT WITH MECHANICAL DRAWINGS AND ME

COMcheck Software Version COMcheckWeb
Interior Lighting Compliance Certificate

Project Information

Energy Code: 2018 IECC
 Project Title: TFSD Robert Stuart Middle School
 Project Type: Alteration

Construction Site:
 Twin Falls, Idaho

Owner/Agent:
 Twin Falls School District
 Twin Falls, Idaho 83301

Designer/Contractor:
 Randy Munns
 Cator Ruma & Associates
 420 S Orchard St #1238
 Boise, Idaho 83705
 (208) 343-3663
 rmunns@catorruma.com

Allowed Interior Lighting Power

A Area Category	B Floor Area (ft ²)	C Allowed Watts / ft ²	D Allowed Watts
1-Classroom (School/University)	1750	0.81	1418
Total Allowed Watts =			1418

Proposed Interior Lighting Power

A Fixture ID : Description / Lamp / Wattage Per Lamp / Ballast	B Lamps/ Fixture	C # of Fixture	D Watt (C X D)	E
Classroom (School/University, 1750 sq ft.)				
LED: D2: RE: LUMINAIRE SCHEDULE: Other:	1	3	15	45
LED: T1: RE: LUMINAIRE SCHEDULE: Other:	1	20	40	800
LED: W1: RE: LUMINAIRE SCHEDULE: Other:	1	1	21	21
Total Proposed Watts =			866	

Interior Lighting PASSES

Interior Lighting Compliance Statement

Compliance Statement: The proposed interior lighting alteration project represented in this document is consistent with the building plans, specifications, and other calculations submitted with this permit application. The proposed interior lighting systems have been designed to meet the 2018 IECC requirements in COMcheck Version COMcheckWeb and to comply with any applicable mandatory requirements listed in the Inspection Checklist.

Kyle Olson, PE - Electrical Engineer
 Name - Title Signature Date 12/21/2023

Project Title: TFSD Robert Stuart Middle School Report date: 12/18/23
 Data filename: Page 1 of 5

GENERAL EQUIPMENT SCHEDULE

COMMON NOTES:
 A. PRIOR TO WORK, VERIFY ELECTRICAL REQUIREMENTS (VOLTAGE, AMPERAGE, RECOMMENDED OCPD, CONDUCTORS, AND DISCONNECT) FOR EACH PIECE OF EQUIPMENT.
 B. PRIOR TO WORK, VERIFY EXACT LOCATION FOR EACH PIECE OF EQUIPMENT WITH ARCHITECT AND/OR OWNER.

SPECIFIC REMARKS:

KEY	ITEM	HP	FLA	LOAD	EQ LOAD (VA)	VOLTAGE	FEEDERS WIRE GROUND	CONDUIT	BREAKER	PROTECTION DISCONNECT FUSE	REMARKS
DISH	DISH WASHER	0	0 A	1500 VA	1500 VA	120 V/ 1ph	#12G 3/4"	3/4"	20 A		
DRY	DRYER	0	22 A	0 VA	4576 VA	208 V/ 1ph	#10G 3/4"	3/4"	30 A	NEMA 6-30	
GD	GARBAGE DISPOSAL	0.5	0 A	0 VA	1176 VA	120 V/ 1ph	#12G 3/4"	3/4"	20 A		
HOOD	KITCHEN HOOD	0	2 A	0 VA	240 VA	120 V/ 1ph	#12G 3/4"	3/4"	20 A		
MICRO	MICROWAVE	0	0 A	1000 VA	1000 VA	120 V/ 1ph	#12G 3/4"	3/4"	20 A		
RANGE	ELECTRIC RANGE	0	40 A	0 VA	8320 VA	208 V/ 1ph	#10G 1"	1"	50 A	NEMA 14-50	
REF	REFRIGERATOR	0	0 A	1500 VA	1500 VA	120 V/ 1ph	#12G 3/4"	3/4"	20 A		
WASH	WASHING MACHINE	0	0 A	1200 VA	1200 VA	120 V/ 1ph	#12G 3/4"	3/4"	20 A		

MECHANICAL EQUIPMENT SCHEDULE

COMMON NOTES:
 A. PRIOR TO WORK, VERIFY ELECTRICAL REQUIREMENTS (VOLTAGE, AMPERAGE, RECOMMENDED OCPD, CONDUCTORS, AND DISCONNECT) FOR EACH PIECE OF EQUIPMENT.
 B. PRIOR TO WORK, VERIFY EXACT LOCATION FOR EACH PIECE OF EQUIPMENT.
 C. COORDINATE AND PROVIDE ALL FIELD CONNECTIONS AS REQUIRED.
 D. COORDINATE 120V POWER CONNECTIONS TO DAMPERS AND OTHER CONTROL CIRCUITS. GROUP EQUIPMENT CONTROL CIRCUITS SUCH THAT FAILURE OF ONE CONTROL CIRCUIT DOES NOT AFFECT OPERATION OF OTHER EQUIPMENT. FOR EXAMPLE, DO NOT CONNECT A DAMPER ASSOCIATED WITH ONE AIR HANDLING UNIT TO THE SAME BRANCH CIRCUIT AS DAMPERS ASSOCIATED WITH A DIFFERENT AIR HANDLING UNIT.
 E. FEEDERS, BREAKERS, DISCONNECTS, AND FUSING APPLIES TO FIELD-INSTALLED AND/OR FACTORY-INSTALLED EQUIPMENT.
 F. COORDINATE LOCATION OF VFD(S) AND WORKING SPACE CLEARANCES. IF INSTALLED REMOTE FROM EQUIPMENT, PROVIDE CIRCUIT CONNECTION FROM VFD TO MOTOR(S).
 G. WHERE MULTIPLE MOTORS ARE SERVED BY A SINGLE VFD, COORDINATE FIELD-WIRING REQUIREMENTS WITH EQUIPMENT VENDOR.

SPECIFIC REMARKS:

KEY	#	ITEM	HP	FLA	LOAD	EQ LOAD (VA)	VOLTAGE	FEEDERS WIRE GROUND	CONDUIT	BREAKER	PROTECTION DISCONNECT FUSE	REMARKS
CU	1	OUTDOOR SPLIT UNIT	0	23.3 A	0 VA	4842 VA	208 V/ 1ph	#10G 3/4"	3/4"	35 A	30 A	
CU	2	OUTDOOR SPLIT UNIT	0	13.2 A	0 VA	2748 VA	208 V/ 1ph	#12G 3/4"	3/4"	20 A	S	
CU	3	OUTDOOR SPLIT UNIT	0	13.2 A	0 VA	2748 VA	208 V/ 1ph	#12G 3/4"	3/4"	20 A	S	
DX	1	INDOOR SPLIT UNIT	0	11.1 A	0 VA	232 VA	208 V/ 1ph	#12G 3/4"	3/4"	15 A	S	
DX	2	INDOOR SPLIT UNIT	0	0.5 A	0 VA	100 VA	208 V/ 1ph	#12G 3/4"	3/4"	15 A	S	
DX	3	INDOOR SPLIT UNIT	0	0.5 A	0 VA	100 VA	208 V/ 1ph	#12G 3/4"	3/4"	15 A	S	
EF	1	EXHAUST FAN	0	7.2 A	0 VA	864 VA	120 V/ 1ph	#12G 3/4"	3/4"	20 A	S	
EH	1	ELECTRIC HEATING COIL	0	0.0 A	1000 VA	1000 VA	120 V/ 1ph	#12G 3/4"	3/4"	20 A	S	
ERV	1	ENERGY RECOVERY UNIT	0	0.0 A	130 VA	130 VA	120 V/ 1ph	#12G 3/4"	3/4"	20 A	S	

ELECTRICAL ACCESSORIES SCHEDULE

COMMON NOTES:
 A. COORDINATE EXACT LOCATION OF FLOORBOXES WITH ARCHITECTURAL PLANS.
 B. VERIFY FINISHES WITH ARCHITECT. VERIFY PROPER FLANGE TYPES WITH ARCHITECTURAL FLOORING PLANS.
 C. REFER TO TECHNOLOGY PLANS FOR ALL DEVICES REQUIRING TECHNOLOGY AND CONDUIT ROUGH-INS.

SPECIFIC REMARKS:

KEY	ITEM	DESCRIPTION	MANUFACTURER	CATALOG SERIES	FINISH	REMARKS
WM-1	DUAL-CHANNEL WIREMOLD	DUAL-CHANNEL RACEWAY FOR DATA AND POWER CABLES.	HUBBELL	P62	WHITE	

LIGHTING CONTROL MATRIX

COMMON NOTES:
 A. NOT ALL SPACE NAMES ARE LISTED FOR EACH LIGHTING CONTROL TYPE. REFER TO PLANS FOR ALL SPACES TO BE CONTROLLED.
 B. SPACES MAY CONTAIN MULTIPLE ZONES OF CONTROL. REFER TO PLANS FOR QUANTITY OF ZONES, SWITCHES, ETC.
 C. PROVIDE THE QUANTITY OF SENSORS AS REQUIRED FOR FULL COVERAGE OF THE SPACE. DEVICES SHOWN ON PLAN ARE FOR DESIGN INTENT ONLY AND DO NOT NECESSARILY REFLECT THE EXACT QUANTITY REQUIRED FOR FULL COVERAGE.
 D. WHERE A SINGLE SWITCH/DIMMER IS DENOTED WITH MULTIPLE SWITCH LEGS, DESIGN INTENT IS A SINGLE-GANG DEVICE WITH MULTIPLE-MODE CONTROL.
 E. ALL NON-NETWORKED SPACES WITH SENSORS SHALL BE PROVIDED WITH MANUAL 'OFF' MEANS.
 F. WHERE NETWORKED SPACES HAVE NO MANUAL 'OFF' MEANS WITHIN SPACE, PROVIDE LABELED MEANS OF SHUTOFF AT CONTROLLER LOCATION FOR NO MORE THAN 5,000 SQUARE FEET.

SPECIFIC REMARKS:

KEY:
 ON / OFF M = MANUAL (SWITCH), A = AUTOMATIC (SENSOR), T = TIME SCHEDULE, P = EXTERIOR PHOTOCELL, #% = CONTROL TO % LIGHT LEVEL
 CONTROL 0-10V DIMMING, ELV DIMMING, STEP DIMMING, DMX CONTROL
 OCC / VAC DT = DUAL TECHNOLOGY, PIR = PASSIVE INFRARED, CLG = CEILING MOUNT, WALL = WALL CORNER MOUNT, SW = INTEGRAL TO WALL SWITCH
 DAYLIGHT CALIBRATE BOTTOM LIMIT OF DAYLIGHT SENSOR TO DENOTED FOOTCANDLE LEVEL AT HEIGHT LISTED
 INTERFACE AV = ALLOW OVERRIDE BY AV SYSTEM, BAS = COMMUNICATE OCCUPIED/UNOCCUPIED STATE TO BAS, VAV = TIE SENSOR RELAY DIRECTLY TO VAV BOX IN ROOM
 NETWORK X = CONNECT ZONE TO CENTRAL LIGHTING CONTROL SYSTEM
 EMERGENCY X = PROVIDE AUTOMATIC LOAD CONTROL RELAYS (ALCR) FOR LUMINAIRES ON EMERGENCY CIRCUIT, PROVIDE TEST SWITCH IF NOT INTEGRAL TO RELAY

TYPE	SPACE	ON	OFF	CONTROL	OCCUPANCY / VACANCY SENSOR		DAYLIGHT SENSOR		INTERFACE	NETWORK	EMERGENCY	REMARKS
					TECH	MOUNT	DELAY (MIN.)	TARGET LEVEL (FC)				
LC2	RESTROOM	A	A		DT	SW	20					
LC6	STORAGE	M	A		PIR	CLG	5					
LC13	CLASSROOM	M	A	0-10V	DT	CLG	20	40	24			

LUMINAIRE SCHEDULE

COMMON NOTES:
 A. CATALOG NUMBER REFERS TO FIRST NAME LISTED UNDER MANUFACTURER PER LUMINAIRE TYPE. REMAINING MANUFACTURERS LISTED ARE CONSIDERED TO BE EQUIVALENT PRODUCTS FOR THIS PROJECT AND SHALL MEET ALL CRITERIA LISTED INCLUDING THAT CALLED FOR BY THE SPECIFIC LUMINAIRE CATALOG NUMBER. CATALOG NUMBERS DO NOT NECESSARILY REPRESENT COMPLETE CATALOG NUMBERS. ALL ITEMS LISTED IN THE DESCRIPTION SHALL BE PROVIDED.
 B. REFER TO LIGHTING SPECIFICATIONS FOR ADDITIONAL REQUIREMENTS.
 C. PROVIDE UNIT PRICING FOR ALL LUMINAIRES BY TYPE AND SUBMIT WITH BID FORM.
 D. PROVIDE AN EMERGENCY BALLAST TEST SWITCH FOR RECESSED DOWNLIGHTS ON CEILING ADJACENT TO LUMINAIRE.
 E. PROVIDE FLICKER FREE LED DRIVERS MEETING IEEE 1789.

SPECIFIC REMARKS:
 1. VERIFY MOUNTING HEIGHT WITH ARCHITECTURAL ELEVATION.


TYPE	DESCRIPTION	LAMP		BALLAST/DRIVER		VOLTAGE	APPARENT LOAD	MANUFACTURER	CATALOG SERIES	FINISH	MOUNTING	REMARKS
		COLOR	LUMENS	TYPE	DIM LEVEL							
D2	3" DIAMETER LED RECESSED DOWNLIGHT, SHOWER RATED, 50 DEGREE BEAM, SELF-FLANGED	3500K	1500	0-10V	10%	120 V	15 VA	ACULUX OR APPROVED EQUAL	INIT3 OR APPROVED EQUAL	CLEAR SPECULAR	RECESSED	
T1	2'x4' RECESSED FLAT PANEL	3500K	5000	0-10V	10%	120 V	40 VA	LITHONIA COOPER LIGHTING SOLUTIONS OR APPROVED EQUAL	CPX 24CGTS OR APPROVED EQUAL	WHITE	RECESSED	
T1E	SAME AS T1 WITH EMERGENCY SELF-DIAGNOSTIC BATTERY BACKUP	3500K	5000	0-10V	10%	120 V	40 VA	LITHONIA COOPER LIGHTING SOLUTIONS OR APPROVED EQUAL	CPX 24CGTS OR APPROVED EQUAL	WHITE	RECESSED	
W1	2' BATHROOM VANITY	3500K	2000	0-10V	10%	120 V	21 VA	LITHONIA SCOTT ARCH LIGHTING OR APPROVED EQUAL	5178 S3661 OR APPROVED EQUAL	BRUSHED NICKEL	WALL	1

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Project: TFSD 2023 CAPITAL IMPROVEMENTS PACKAGE 6, SUPPORT SERVICE CLASSROOM TENANT IMPROVEMENT AT ROBERT STUART MIDDLE SCHOOL
 644 Caswell Ave W Twin Falls, ID 83301

Sheet: ELECTRICAL SCHEDULES



Project No: 23010-00
 Drawn By: BEL
 Checked By: RHM
 Date: 12/22/2023

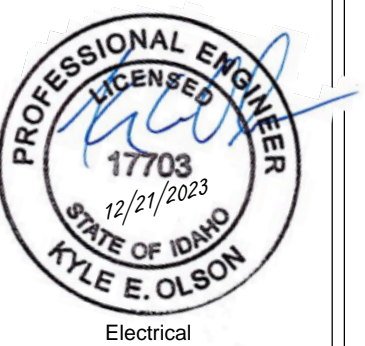Sheet No: E0.02

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KEYNOTES

GENERAL NOTES:

- 1. EXISTING LIGHTING CIRCUITRY TO BE MAINTAINED AND EXTENDED TO NEW FIXTURES.

A

B

C

D


E



↑ **LEVEL 1 LIGHTING DEMOLITION PLAN**
SCALE: 1/8" = 1'-0"



↑ **LEVEL 1 LIGHTING PLAN**
SCALE: 1/8" = 1'-0"

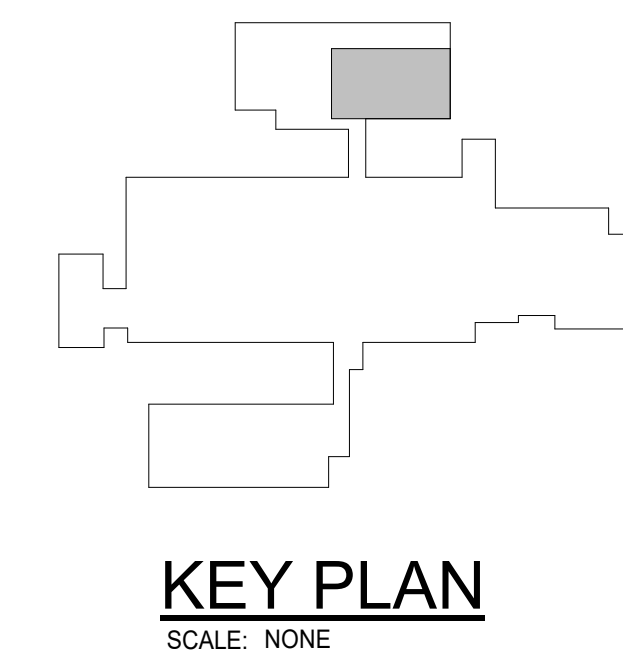

KEY PLAN
SCALE: NONE


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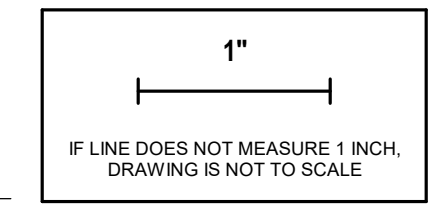
Project:
TFSD 2023 CAPITAL IMPROVEMENTS
PACKAGE 6, SUPPORT SERVICE
CLASSROOM TENANT IMPROVEMENT
AT ROBERT STUART MIDDLE SCHOOL
644 Casewell Ave W
Twin Falls, ID 83301

Sheet:
LEVEL 1 LIGHTING PLANS



Project No: 23010-00
Drawn By: SEL
Checked By: RHM
Date: 12/22/2023

Sheet No: **E2.01**

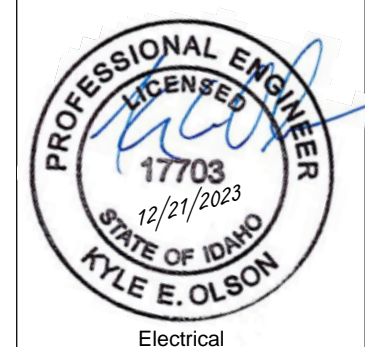

1"
IF LINE DOES NOT MEASURE 1 INCH,
DRAWING IS NOT TO SCALE.

KEYNOTES

E1	EXISTING CIRCUITRY TO BE MAINTAINED AND EXTENDED TO NEW OUTLETS.
T1	COORDINATE ROUGH-IN WITH TV MOUNT.


A

B


C

D


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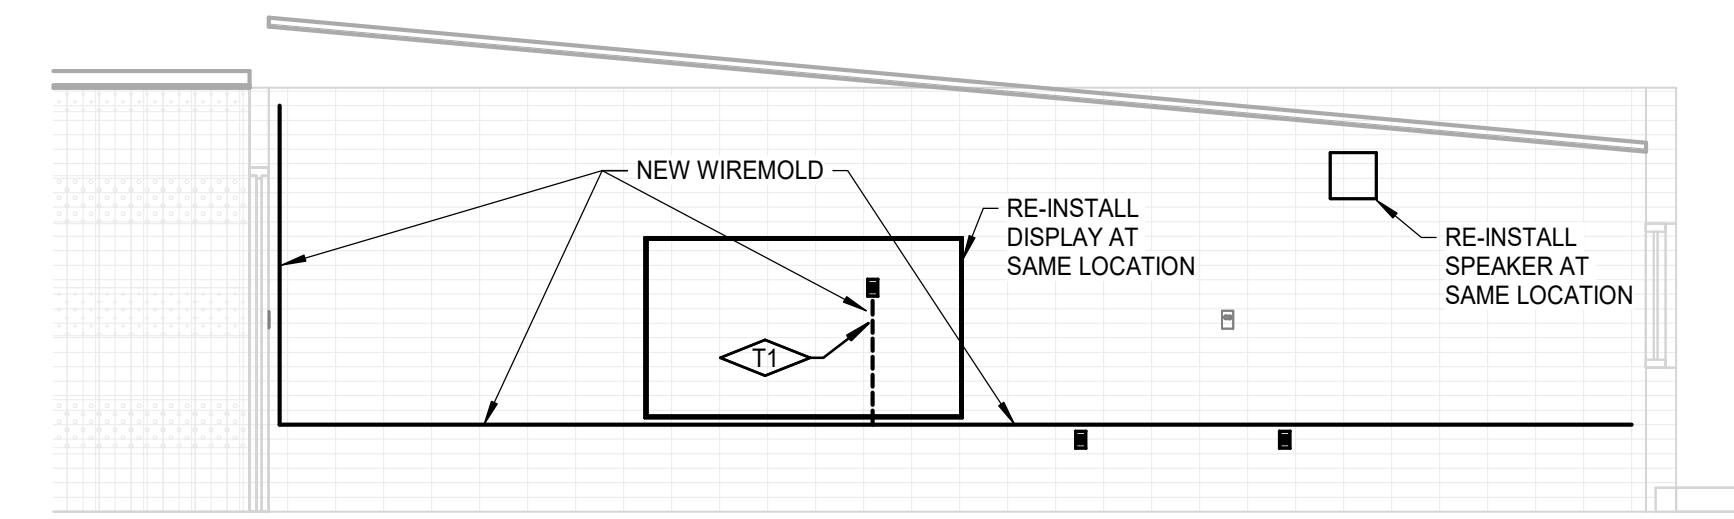
LEVEL 1 POWER DEMOLITION PLAN
SCALE: 1/8" = 1'-0"

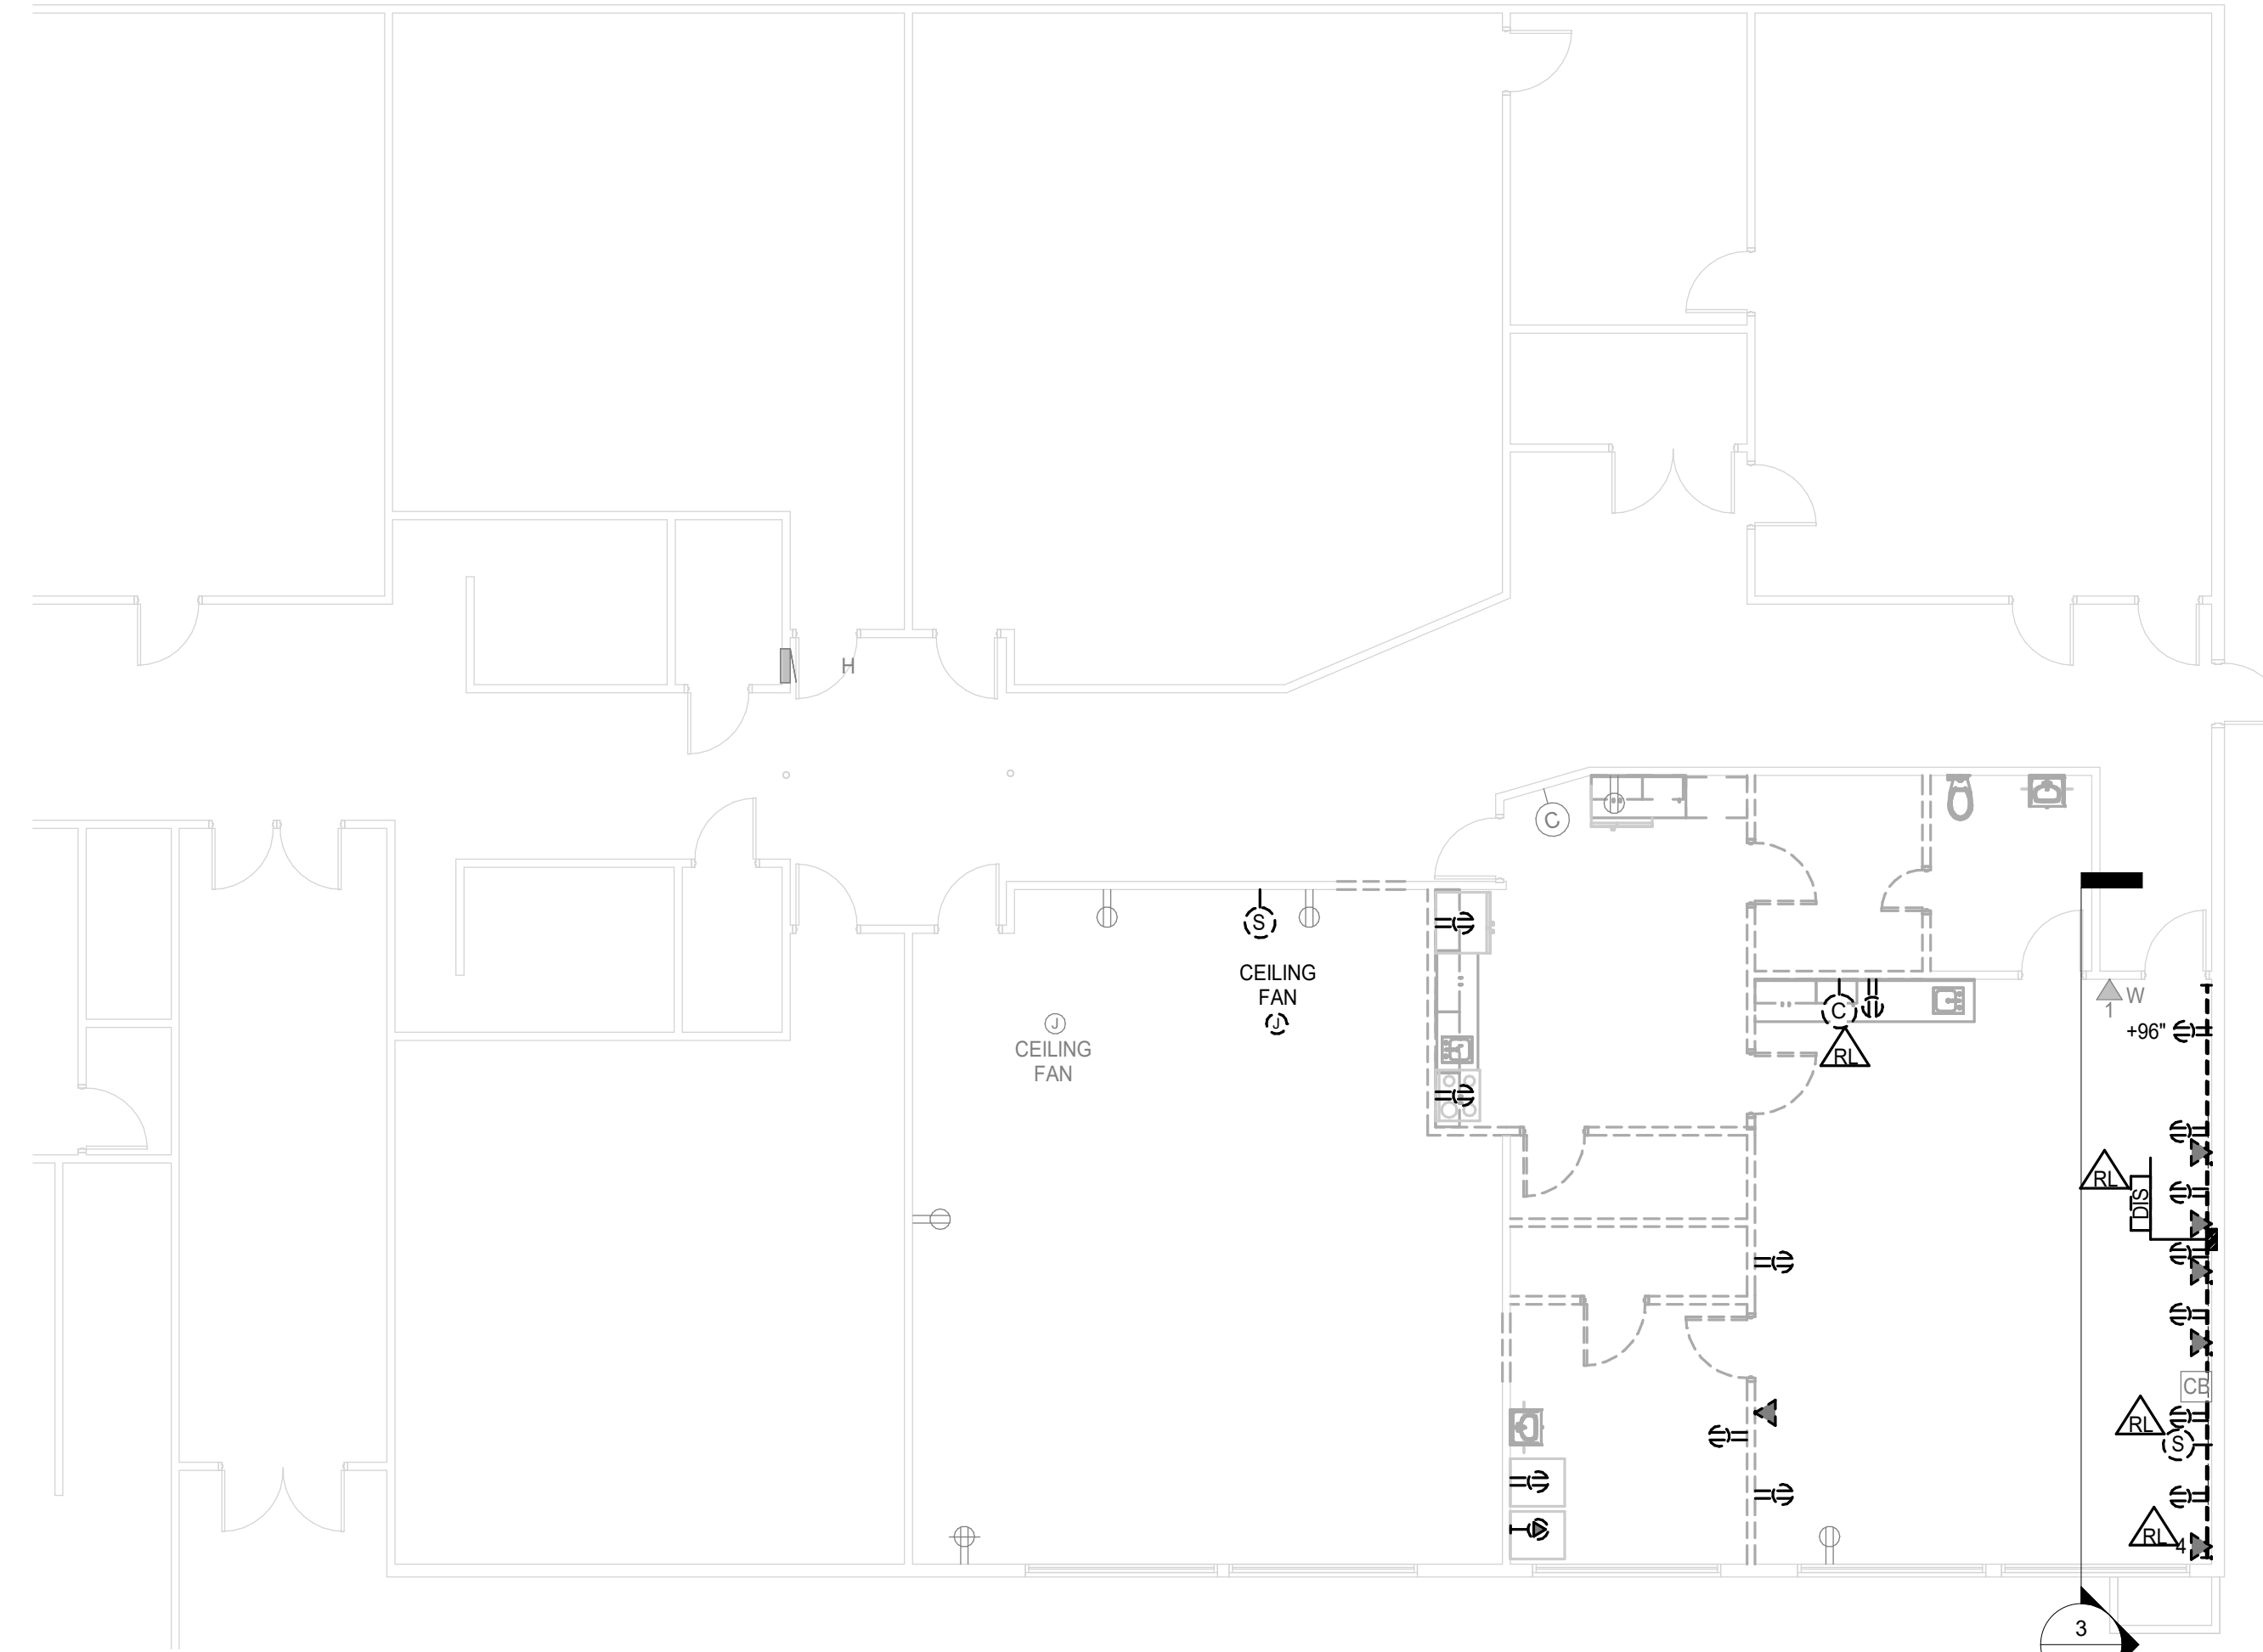


3 EAST WALL ELEVATION - DEMO
SCALE: 1/4" = 1'-0"

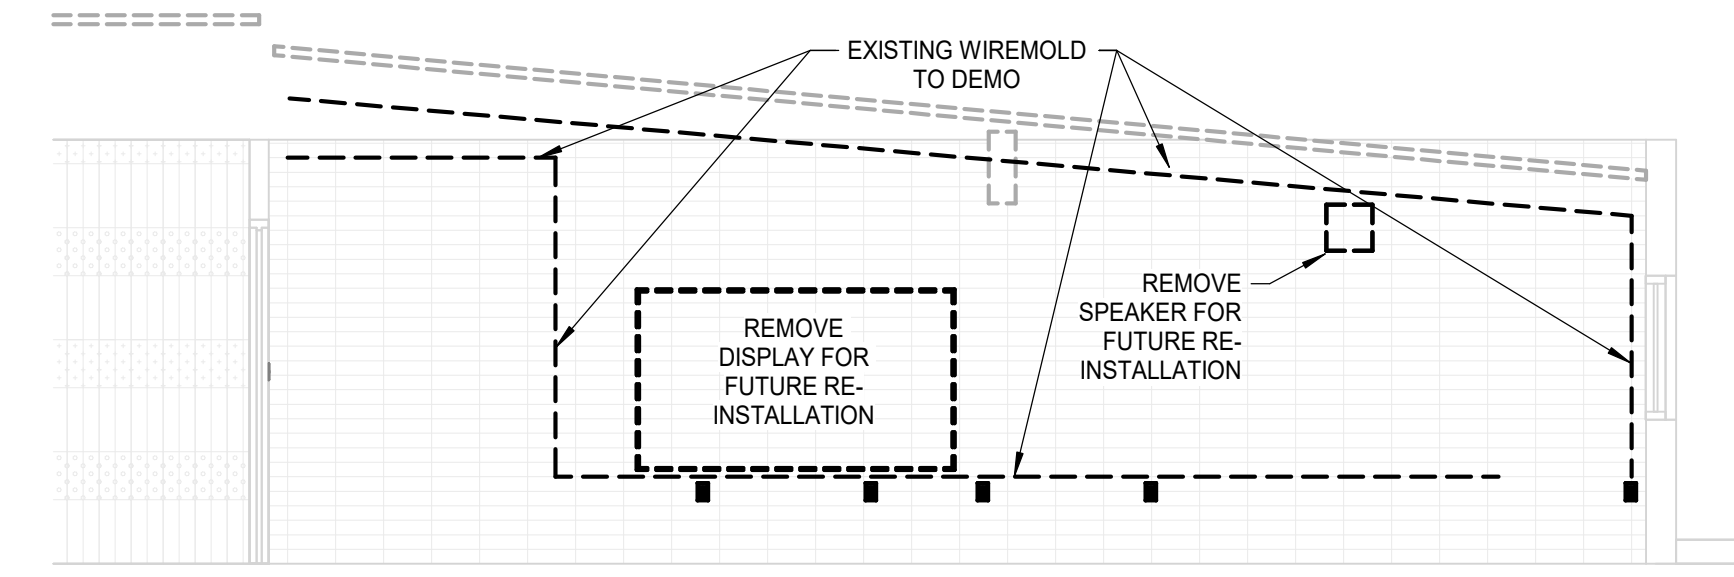

LEVEL 1 POWER PLAN
SCALE: 1/8" = 1'-0"

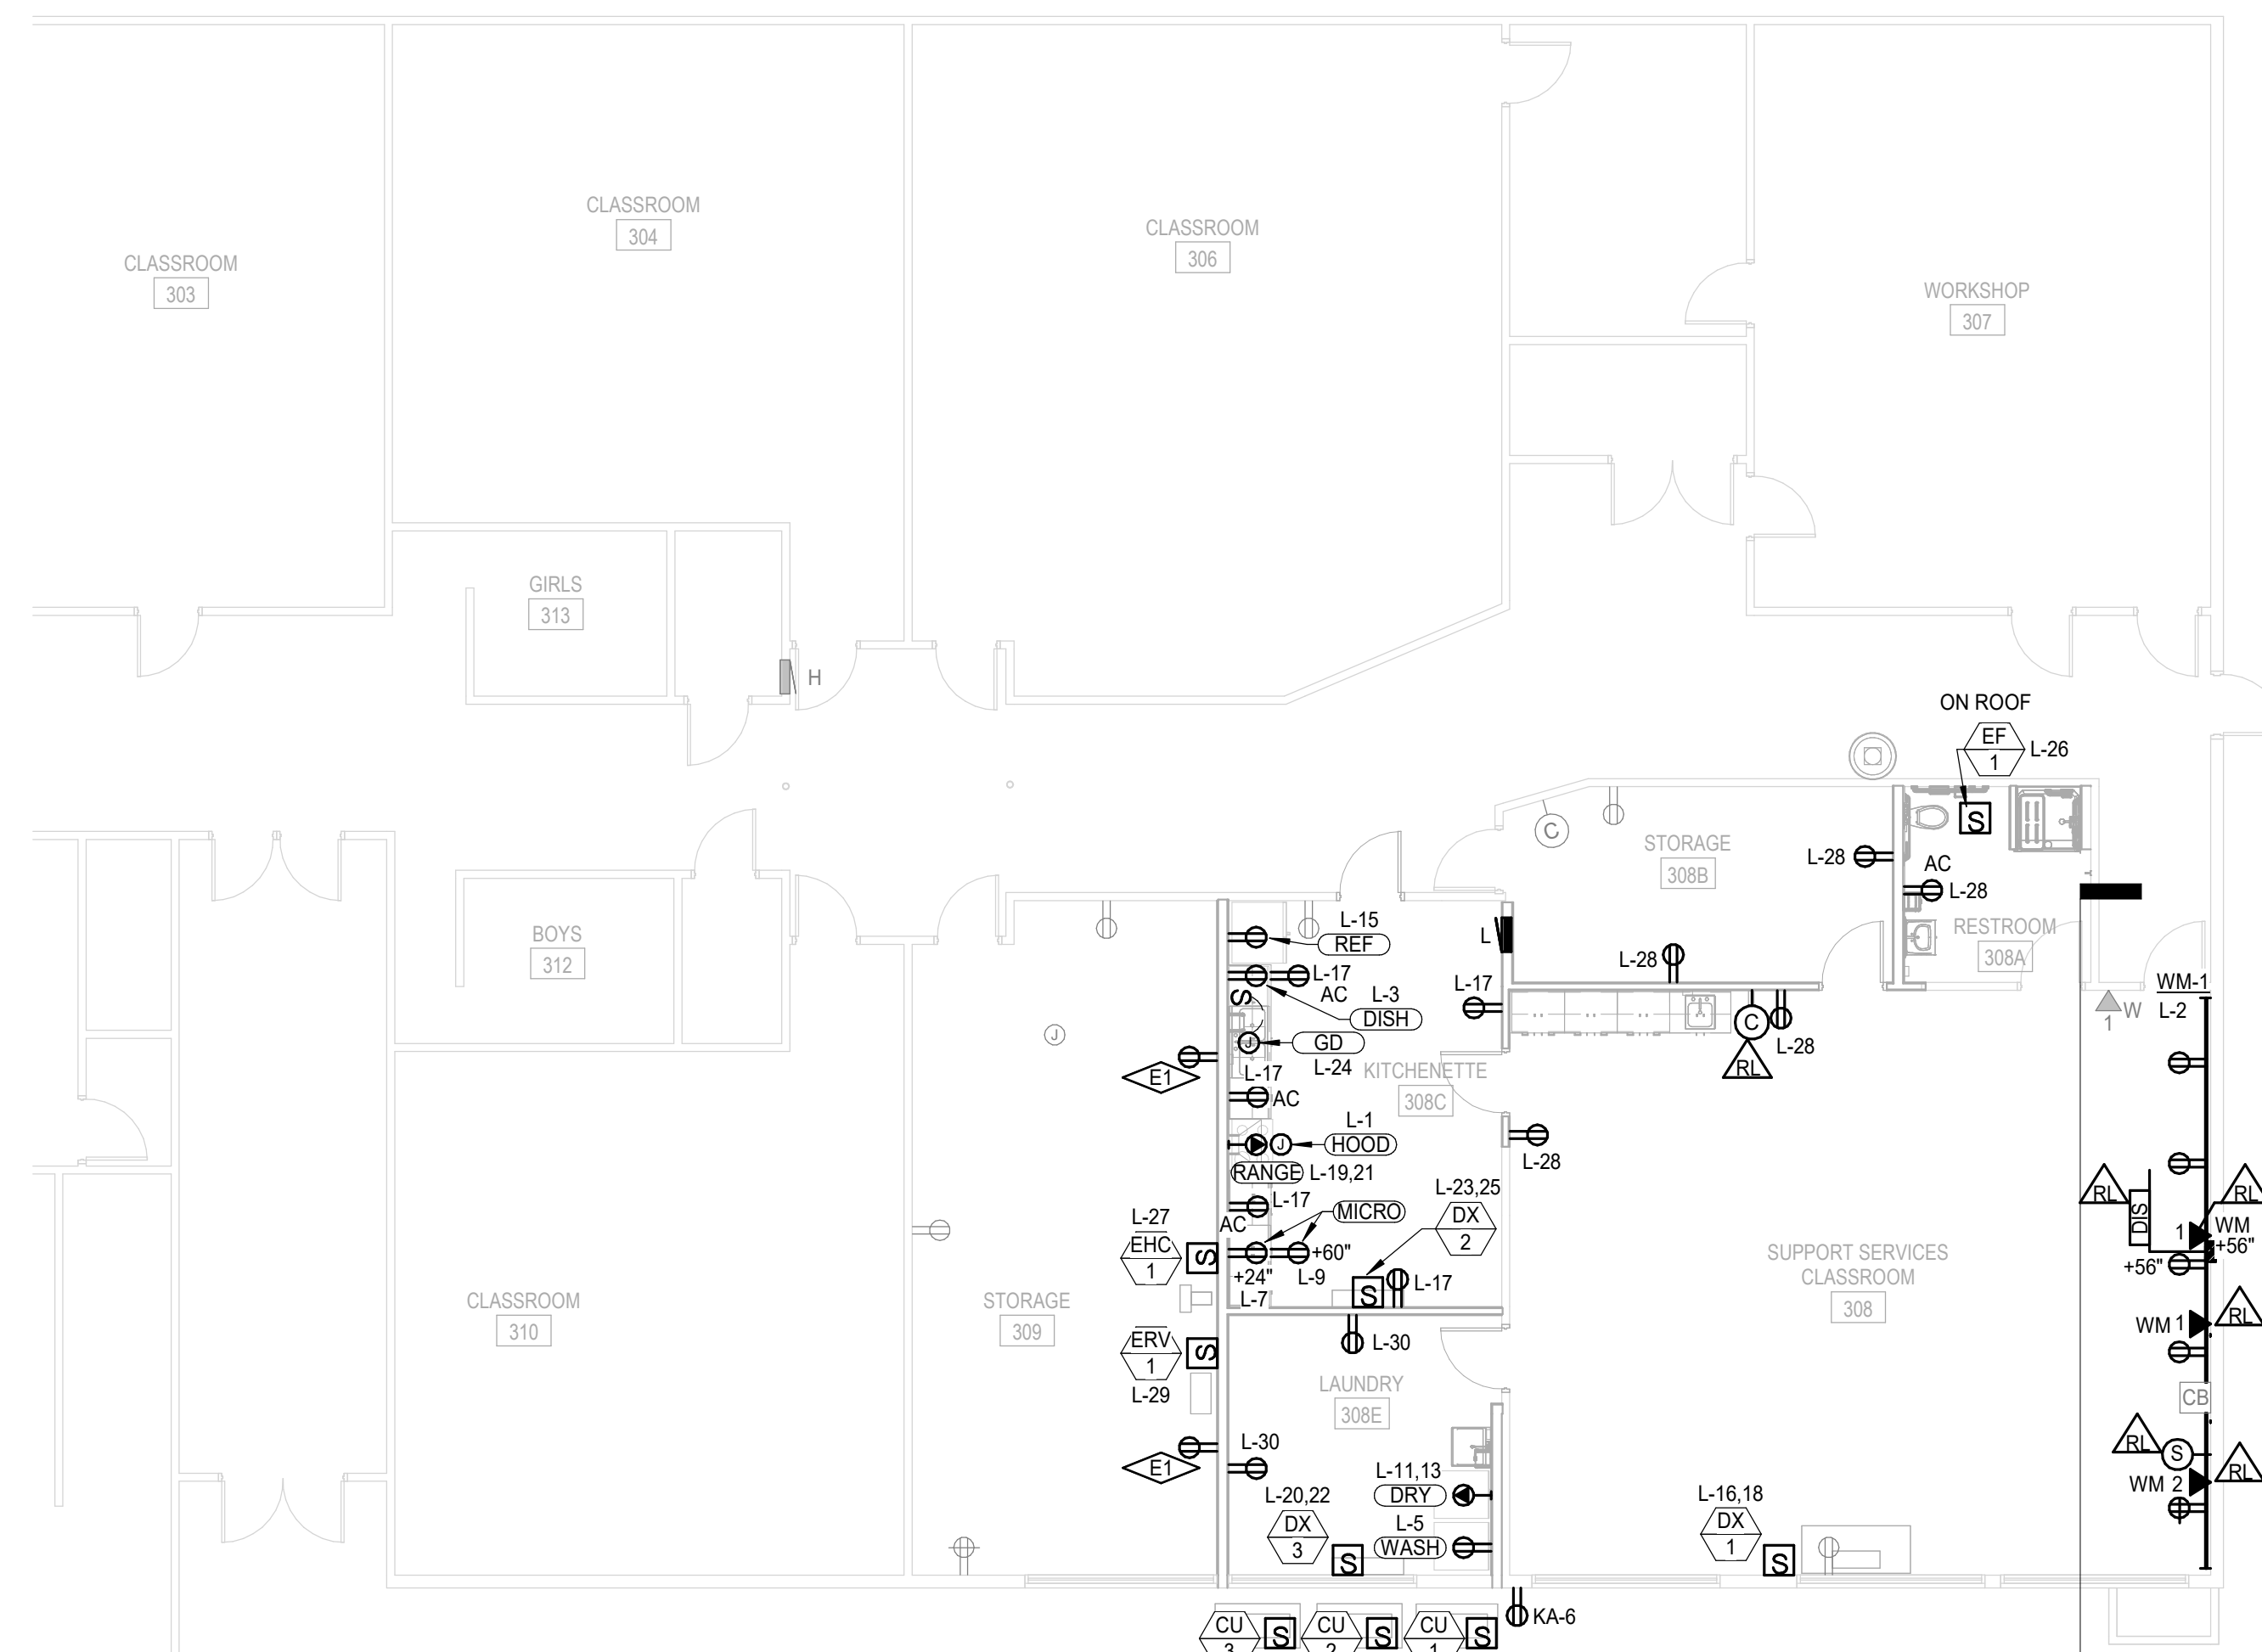

4 EAST WALL ELEVATION - NEW
SCALE: 1/4" = 1'-0"

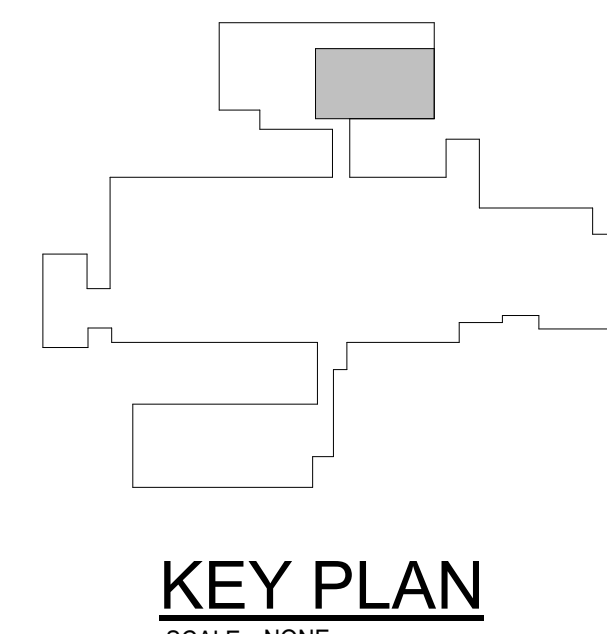

KEY PLAN
SCALE: NONE


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PACKAGE 6, SUPPORT SERVICE
CLASSROOM TENANT IMPROVEMENT
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644 Casewell Ave W
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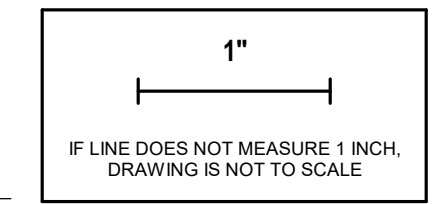
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Sheet:
LEVEL 1 POWER PLANS




Project No: 23010-00
Drawn By: SEL
Checked By: RHM
Date: 12/22/2023

Sheet No:
E2.11

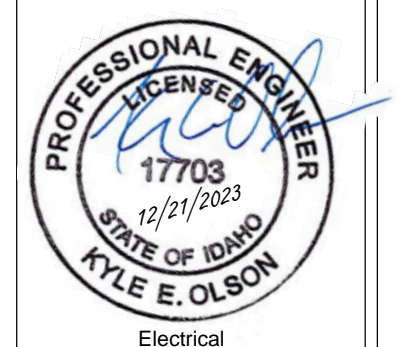


A

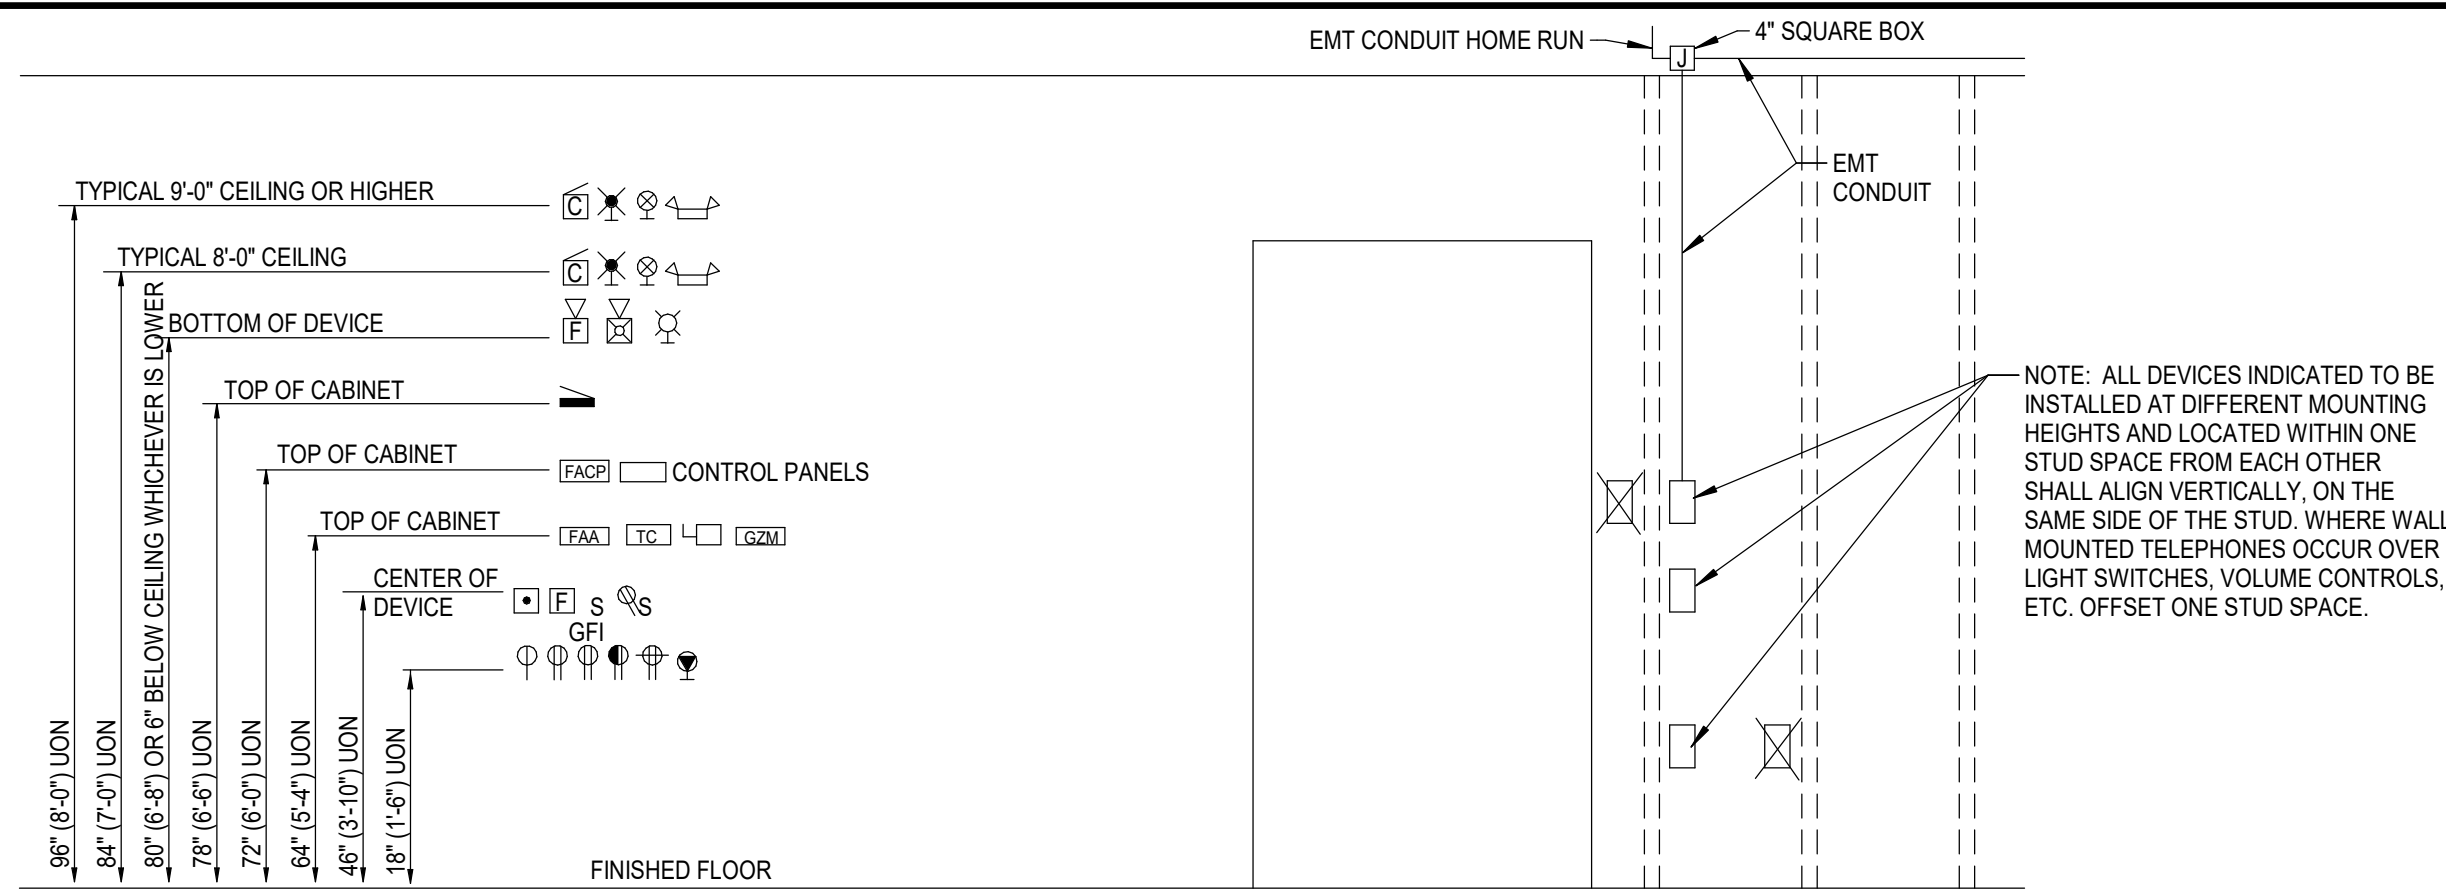

TYPICAL ELECTRICAL DEVICE MOUNTING HEIGHTS

NO SCALE


- NOTES:
- HEIGHTS SHOWN ARE TYPICAL TO CENTERLINE OF BOX UNLESS NOTED OTHERWISE.
 - WHERE EVER DEVICES ARE INDICATED TO BE ABOVE DOORS, DEVICE SHALL BE CENTERED BETWEEN TOP OF DOOR TRIM AND CEILING LINE.
 - MOUNTING HEIGHTS SHOWN ON ARCHITECTURAL ELEVATIONS SHALL GOVERN OVER THOSE SHOWN ABOVE. VERIFY MOUNTING HEIGHTS WITH ARCHITECTURAL ELEVATIONS. DEVICES AND COVER PLATES SHALL NOT COVER/OVERLAP EDGES OF WAINSCOTING, TILE OR OTHER SPECIALTY WALL FINISHES.
 - REFER TO TYPICAL TECHNOLOGY DEVICE MOUNTING HEIGHTS DETAIL FOR ADDITIONAL INFORMATION.
 - DEVICE MOUNTING HEIGHTS SHALL BE PER MOST CURRENT VERSION OF GOVERNING CODES AND STANDARDS NEC, IBC, NFPA, ADA, ETC. WHERE DISCREPANCIES BECOME EVIDENT CONSULT THE ARCHITECT AND ENGINEER OF RECORD.
 - WHERE RECEPTACLES, SWITCHES AND OTHER DEVICES ARE INSTALLED ABOVE COUNTERS, THE DEVICES SHALL BE INSTALLED AT 48" MAXIMUM (COUNTERS/SHELVES 0-20 INCHES WIDE) AND 44" MAXIMUM (COUNTERS/SHELVES 20-25 INCHES WIDE) ABOVE FINISHED FLOOR TO DEVICE CENTER.
 - RECEPTACLES AND LOW VOLTAGE DEVICES SHALL NOT BE INSTALLED BELOW 15" AFF PER ADA STANDARDS.

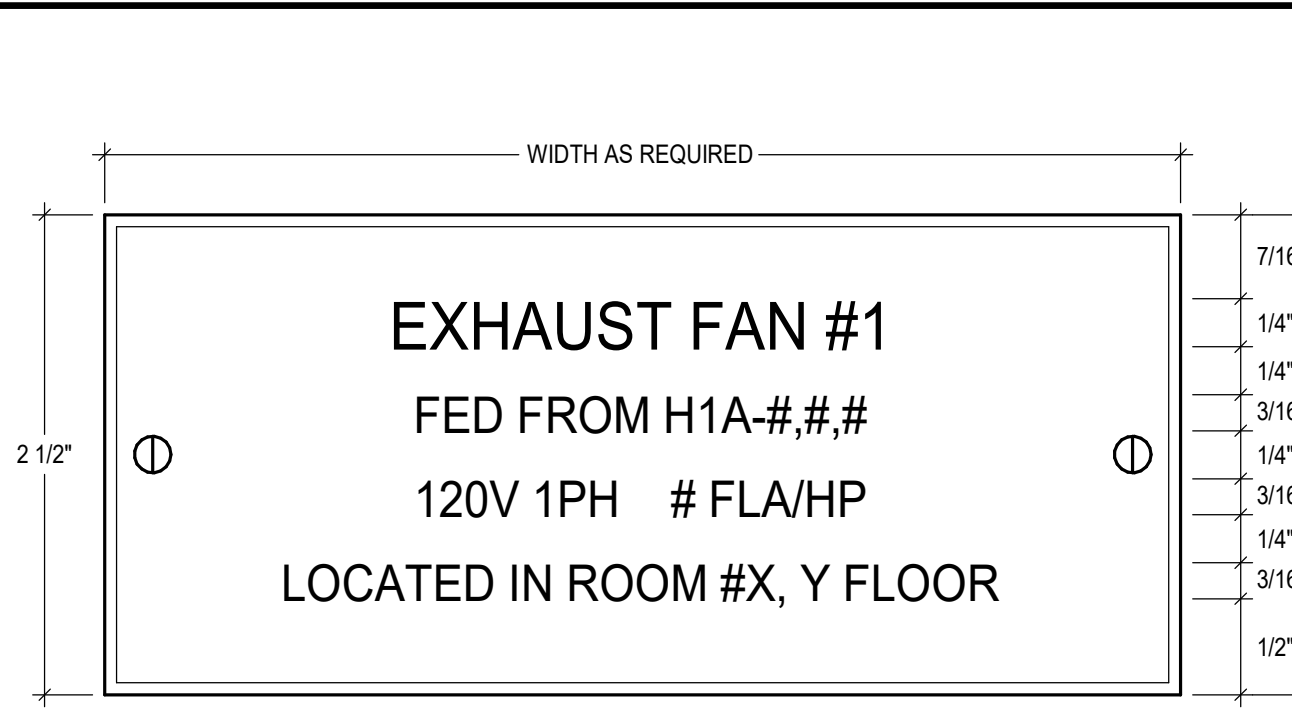

UTILIZATION EQUIPMENT NAMEPLATE DETAIL

SCALE: FULL


- NOTES:
- SEE SPECIFICATIONS FOR ADDITIONAL NAMEPLATE INFORMATION.
 - REWORD NAMEPLATE FOR FIELD CONDITIONS.
 - HP SHALL INDICATE HORSEPOWER; FLA SHALL INDICATE FULL LOAD AMPS.
 - CONFIRM ROOM NUMBER (X) AND FLOOR (Y) WITH OWNER AND ARCHITECT PRIOR TO PRINTING LABEL.

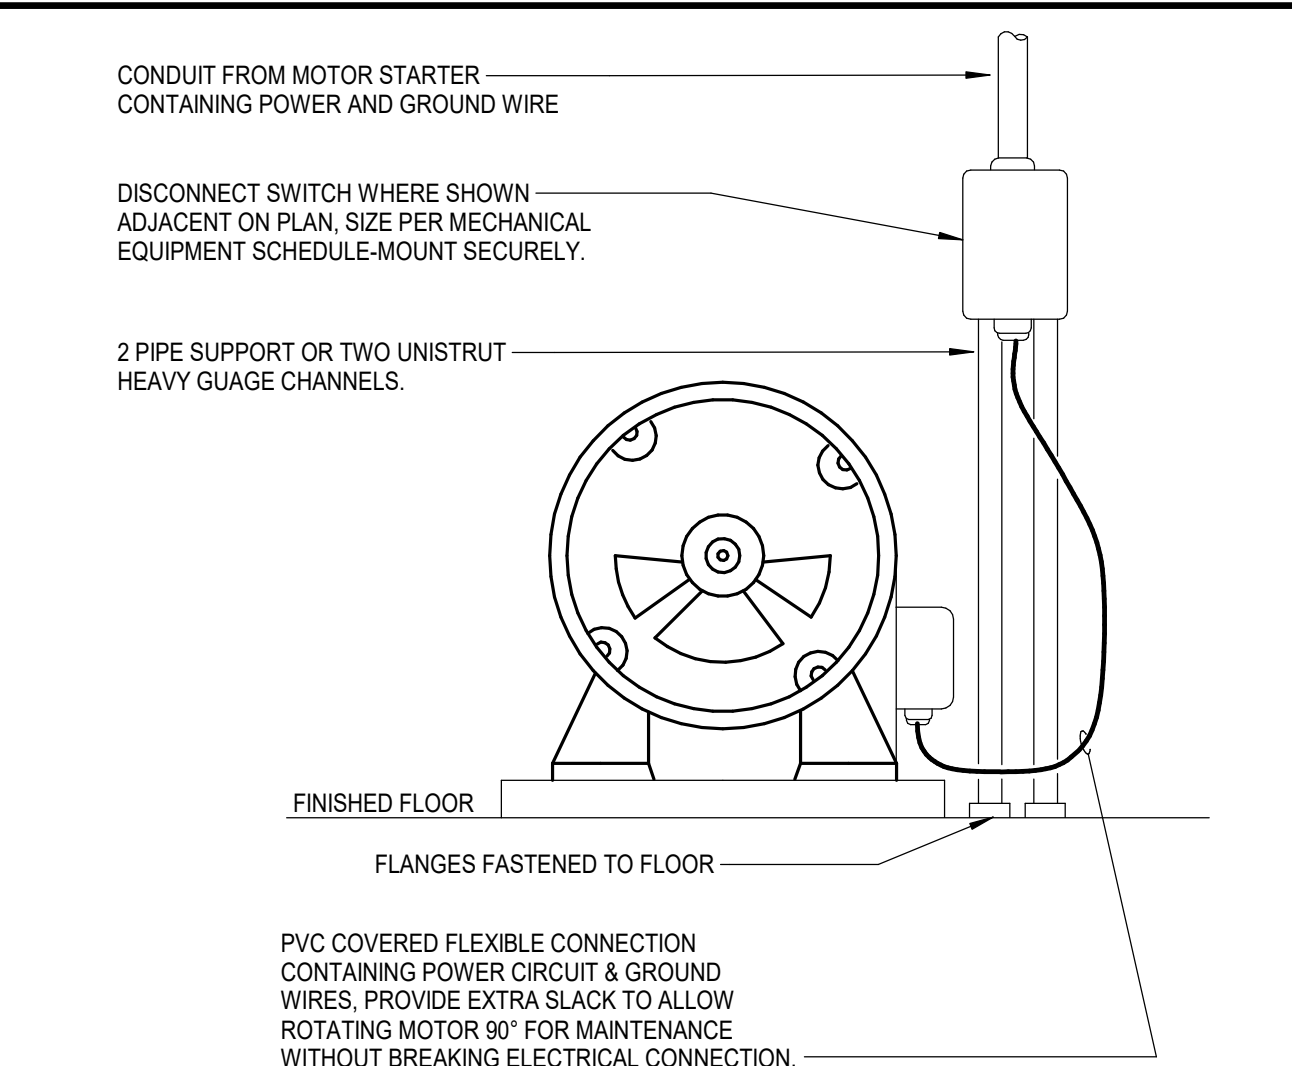

CONNECTION TO FLOOR MOUNTED MOTORS

NO SCALE


NOTE: SEE SPECIFICATIONS FOR ADDITIONAL SUPPORT, SEISMIC AND OTHER REQUIREMENTS.

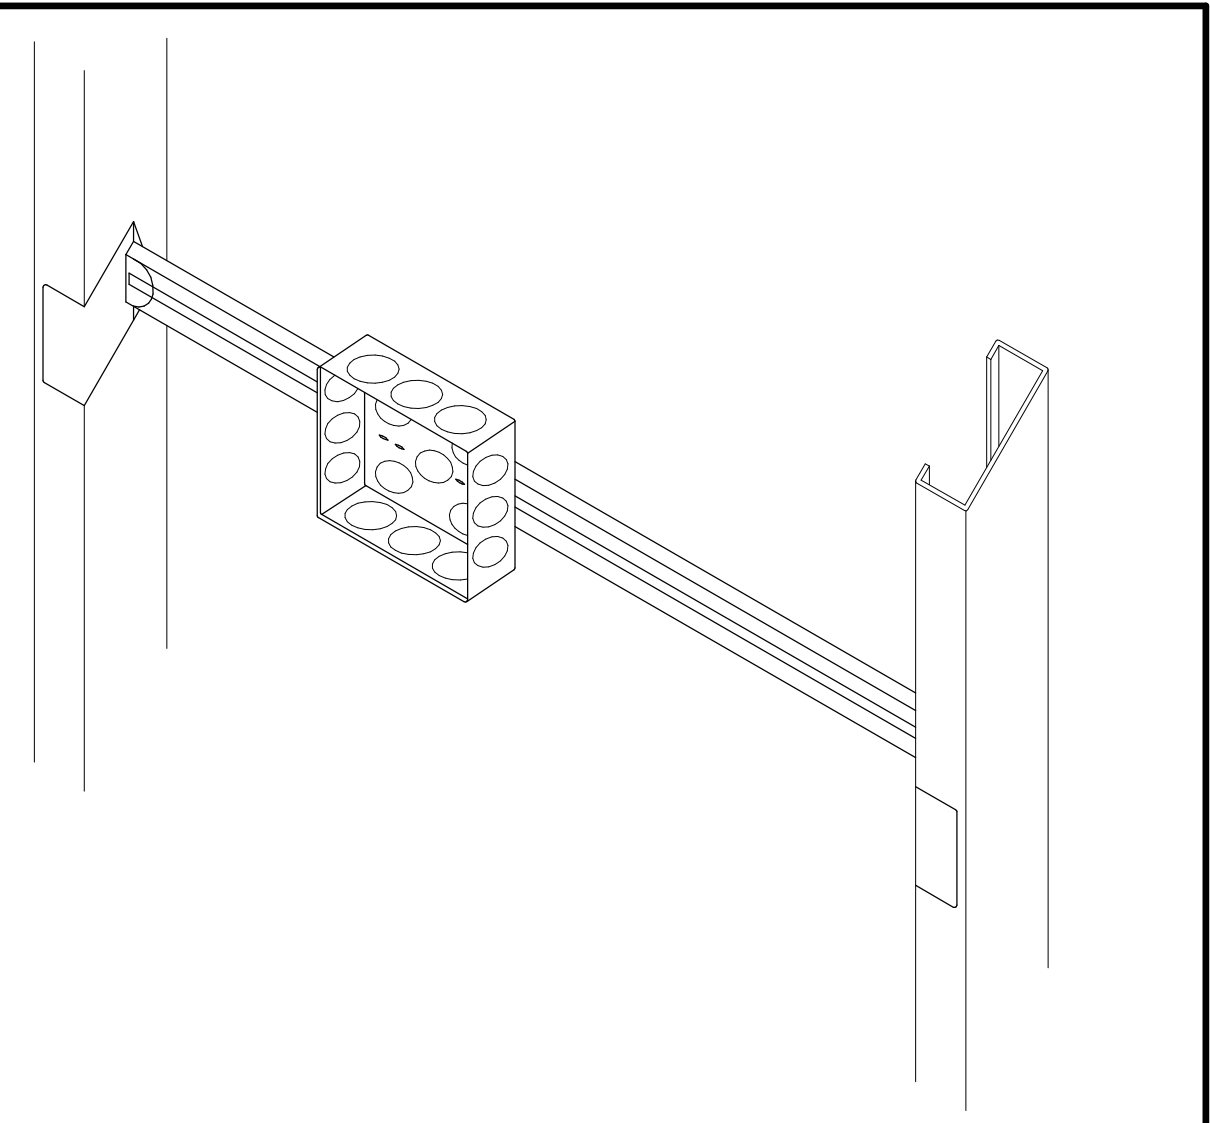

OUTLET BOX SUPPORT DETAIL

NO SCALE


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TYPICAL LOW VOLTAGE DEVICE MOUNTING HEIGHTS

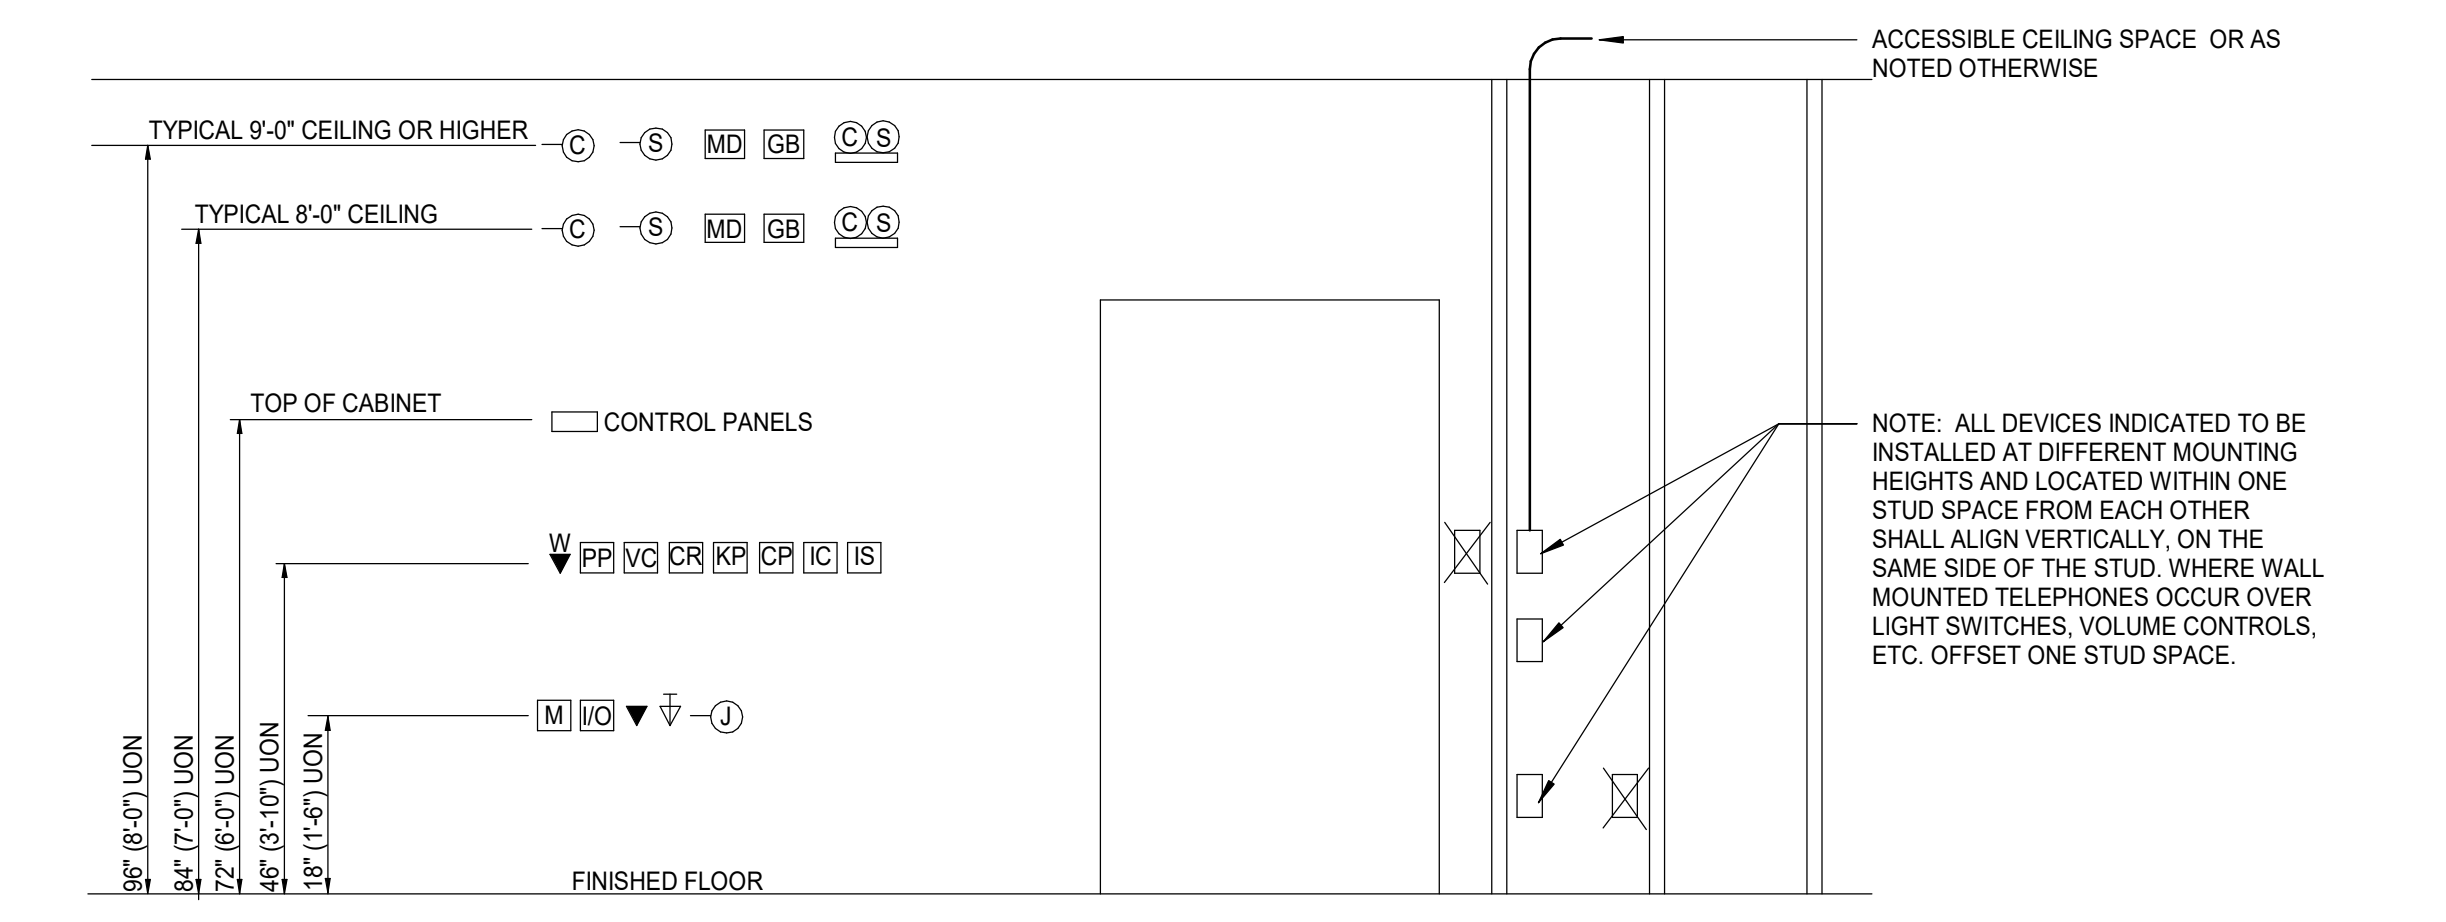NO SCALE


- NOTES:
- HEIGHTS SHOWN ARE TYPICAL TO CENTERLINE OF BOX UNLESS OTHERWISE NOTED.
 - WHERE EVER DEVICES ARE INDICATED TO BE ABOVE DOORS, DEVICE SHALL BE CENTERED BETWEEN TOP OF DOOR TRIM AND CEILING LINE.
 - MOUNTING HEIGHTS SHOWN ON ARCHITECTURAL ELEVATIONS SHALL GOVERN OVER THOSE SHOWN ABOVE. VERIFY MOUNTING HEIGHTS SHOWN ON ARCHITECTURAL ELEVATIONS. DEVICES AND COVER PLATES SHALL NOT COVER/OVERLAP EDGES OF WAINSCOTING, TILE OR OTHER SPECIALTY WALL FINISHES.
 - DEVICE MOUNTING HEIGHTS SHALL BE PER MOST CURRENT VERSION OF GOVERNING CODE AND STANDARDS NEC, IBC, NFPA, ADA, ETC. WHERE DISCREPANCIES BECOME EVIDENT, CONSULT THE ARCHITECT AND ENGINEER OF RECORD.
 - WHERE DEVICES ARE INSTALLED ABOVE COUNTER, THE DEVICES SHALL BE INSTALLED AT 48" MAXIMUM (COUNTERS/SHELVES 0-20 INCHES WIDE) AND 44" MAXIMUM (COUNTERS/SHELVES 20-25 INCHES WIDE) ABOVE FINISHED FLOOR TO DEVICE CENTER.
 - LOW VOLTAGE DEVICES SHALL NOT BE INSTALLED BELOW 15" AFF PER ADA STANDARDS.



CABLE SUPPORT SYSTEM DETAIL

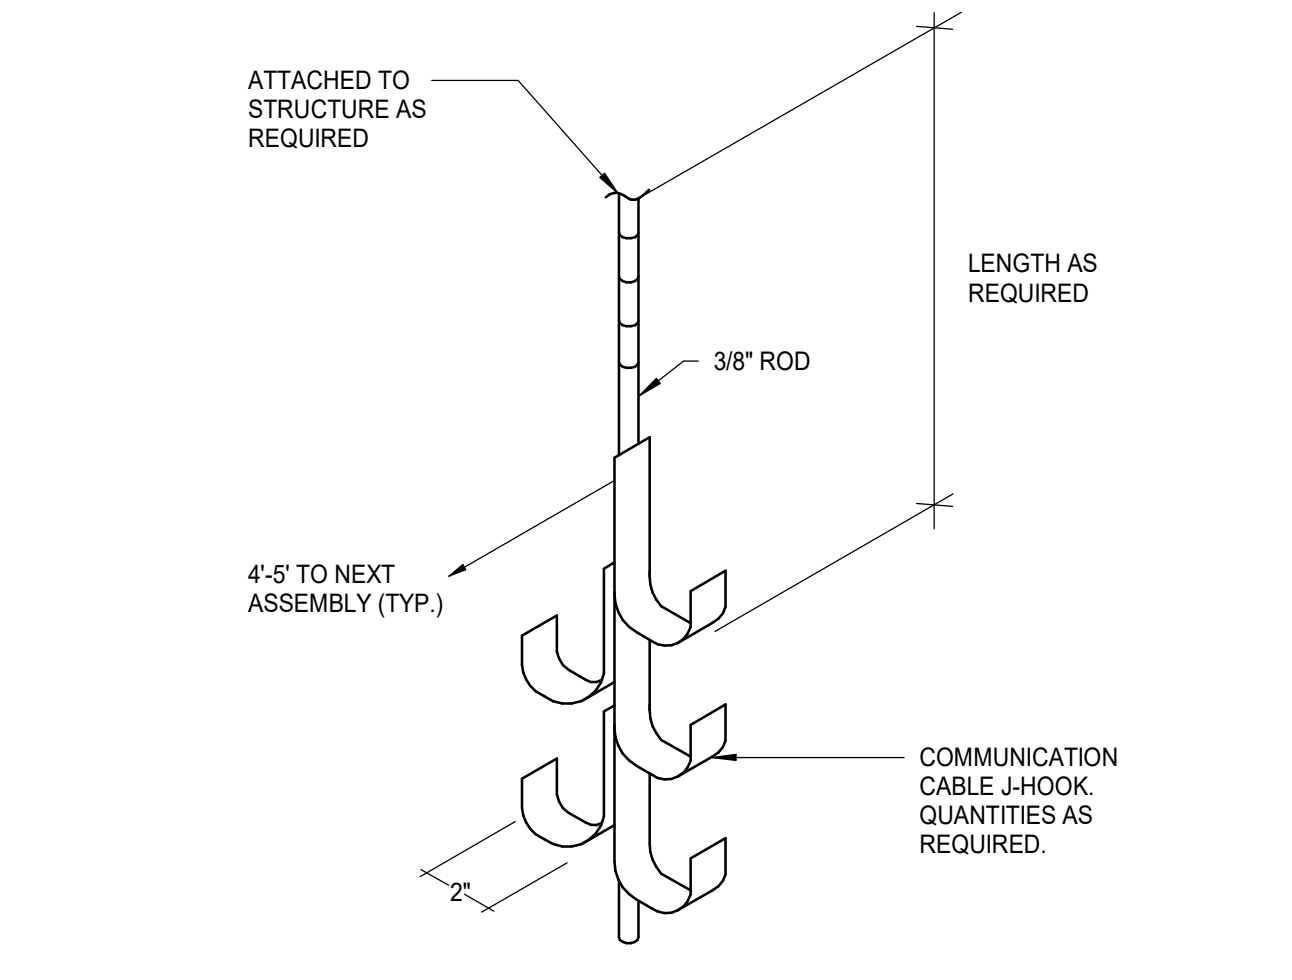
NO SCALE

NOTE: ALL WIRES AND CABLES SHALL BE SUPPORTED. MAXIMUM SPACING BETWEEN HOOKS SHALL BE 4' TO 5'. ATTACH HOOK ASSEMBLY TO BUILDING STRUCTURE. ALL CABLE RUNS TO BE PERPENDICULAR AND PARALLEL TO BUILDING WALLS.

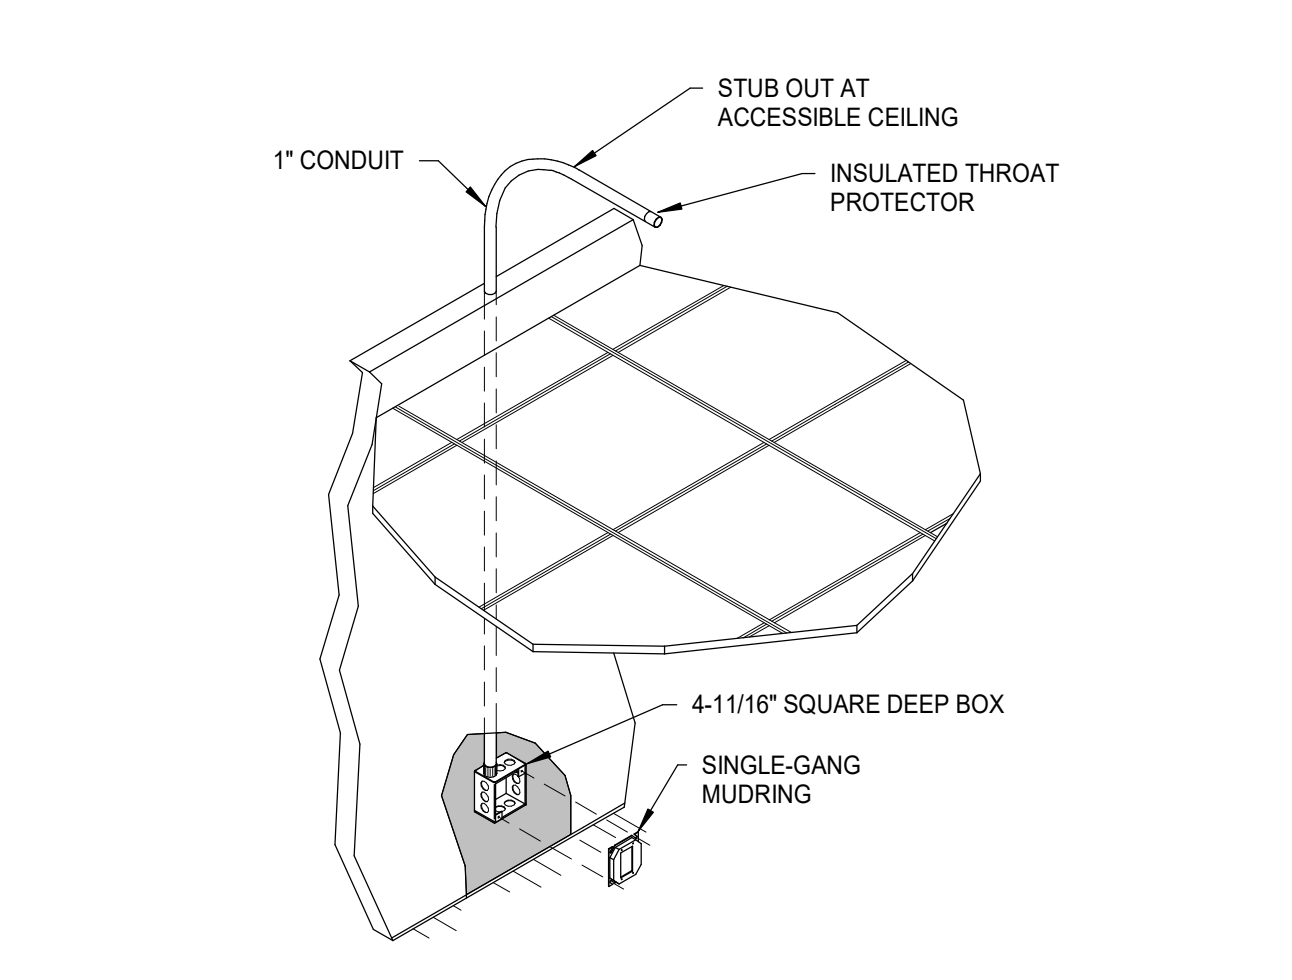

OUTLET ROUGH-IN DETAIL


NO SCALE

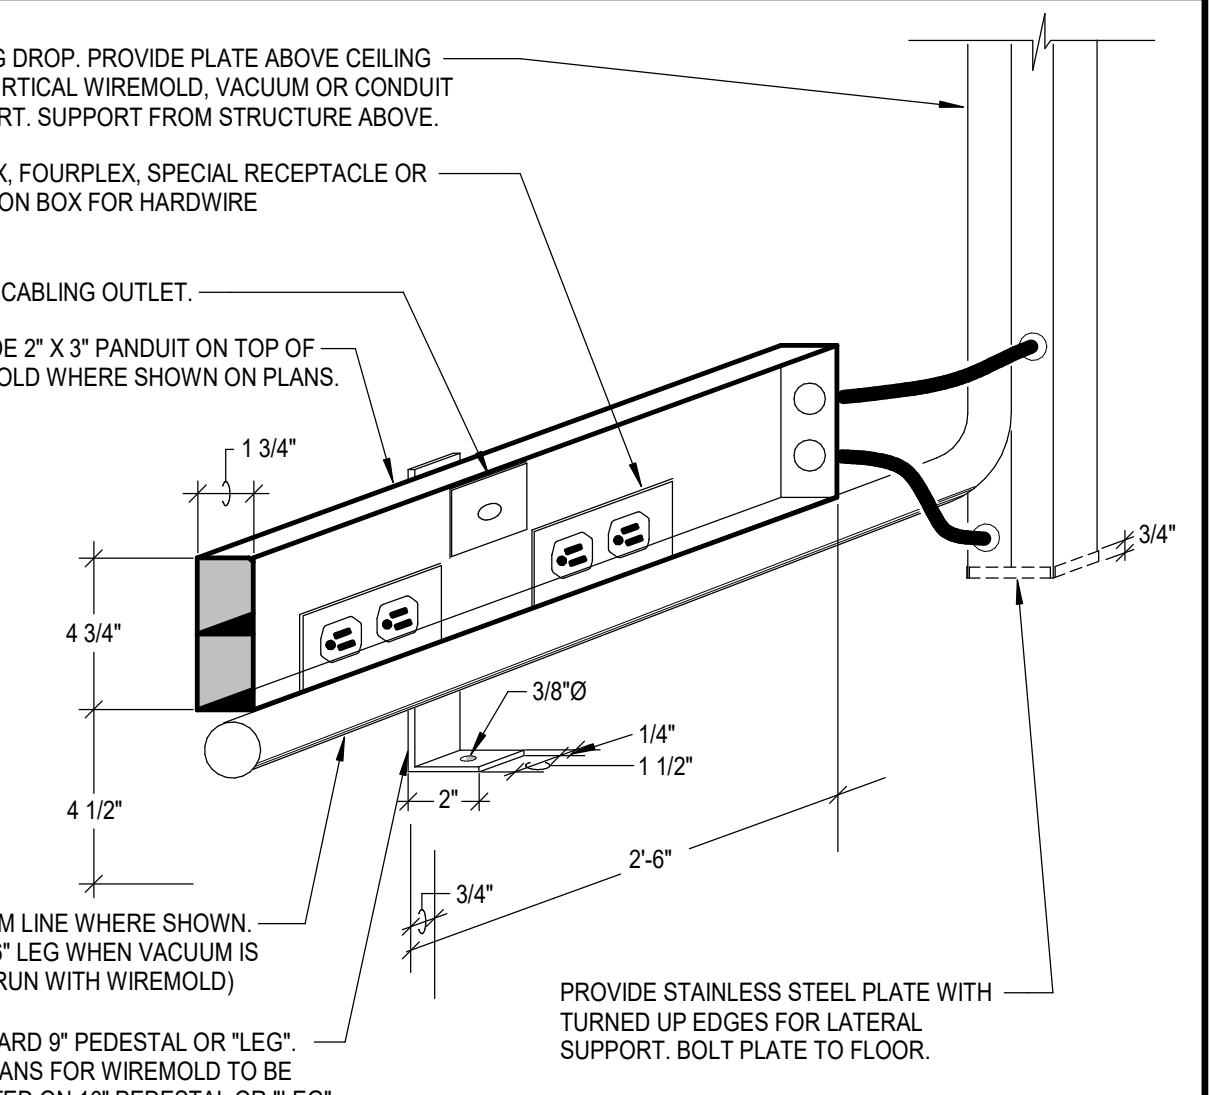

WIREMOLD DETAIL

NO SCALE

C

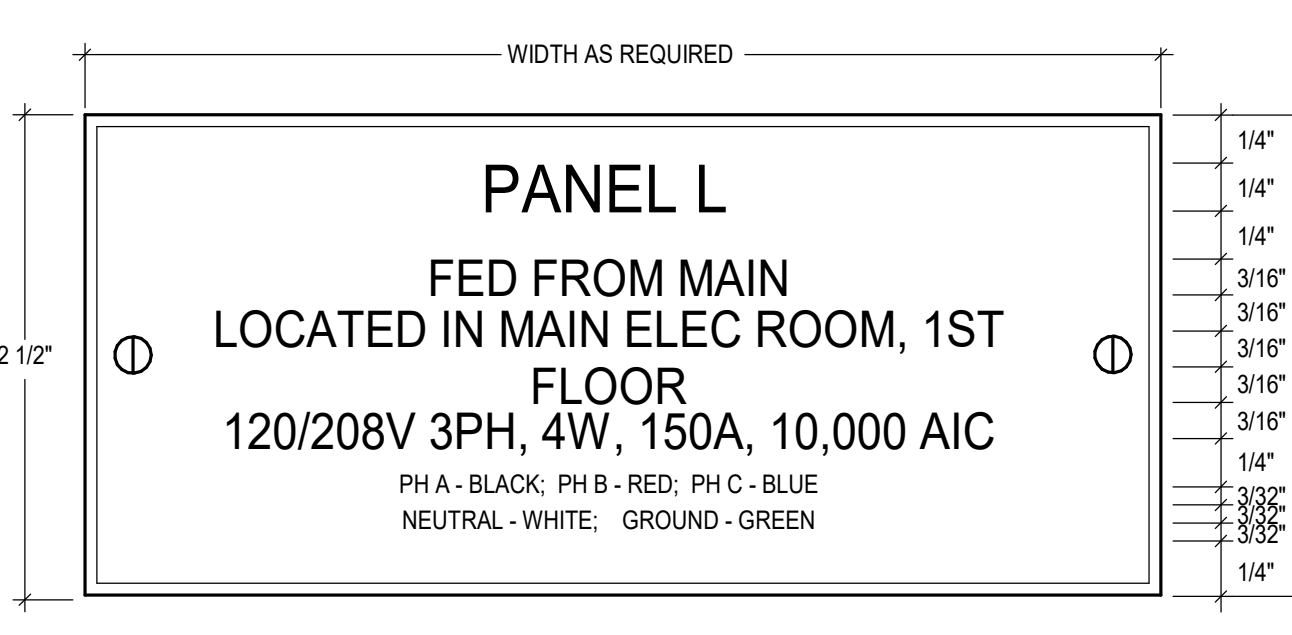

SUB-DISTRIBUTION CENTER AND BRANCH PANELBOARD NAMEPLATE DETAIL

SCALE: FULL

- NOTES:
- SEE SPECIFICATIONS FOR ADDITIONAL NAMEPLATE INFORMATION.
 - REWORD NAMEPLATE FOR FIELD CONDITIONS.
 - AMP RATING SHALL INDICATE BUS RATING.
 - CONFIRM ROOM NUMBER (X) AND FLOOR (Y) WITH OWNER AND ARCHITECT PRIOR TO PRINTING LABEL.
 - REFER TO SPECIFICATIONS FOR 277/480V PHASE CONDUCTOR COLOR REQUIREMENTS.

D

E


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Project:
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PACKAGE 6, SUPPORT SERVICE
CLASSROOM TENANT IMPROVEMENT
AT ROBERT STUART MIDDLE SCHOOL
644 Casewell Ave W
Twin Falls, ID 83301

Sheet: ELECTRICAL DETAILS



Project No: 23010-00
Drawn By: BEL
Checked By: RHM
Date: 12/22/2023

Sheet No: E3.01

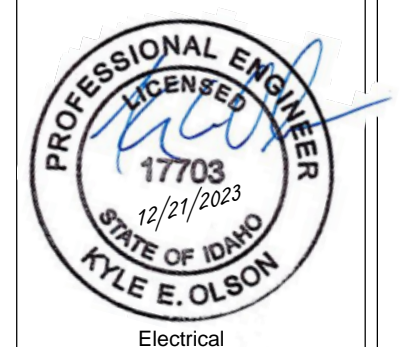Dist. Panel MAIN

EXISTING

Location: Main
Supply From: Surface
Mounting: Surface

Voltage: 120/208 Wye
Phases: 3
Wires: 4

A.I.C. Rating: 10,000
Mains Type: MCB
Bus Rating: 400 A
MCB Rating: 400 A

Circuit Notes:
1. EXISTING LOAD REMOVED. LABEL BREAKER AS SPARE.

Load	Type	A	B	C	Note
100A	---	0 VA			
PANEL K 200A	Spare	0 VA	0 VA	0 VA	
PANEL KA 200A	Spare R	0 VA	0 VA	180 VA	
PANEL L 160A	Spare; R, G, M	14246 VA	12972 VA	10014 VA	
		14246 VA	12972 VA	10194 VA	
		122 A	112 A	85 A	
		10	31	44	

Refer to one-line diagram for space, spare, and circuit breaker quantities.

Load Type	Connected Load	Demand Factor	Demand Load	Switchboard Totals
L Lighting	0 VA	0.00%	0 VA	Power Factor: 1
R Receptacle	12460 VA	90.13%	11230 VA	
M Motor	12760 VA	109.49%	13971 VA	
C Continuous	0 VA	0.00%	0 VA	
G General	12192 VA	100.00%	12192 VA	
K Kitchen	0 VA	0.00%	0 VA	
E Existing	0 VA	0.00%	0 VA	
O Other	0 VA	0.00%	0 VA	
Total Connected Load: 37412 VA				
Total Connected Current: 104 A				
Total Demand Load: 37393 VA				
Total Demand Current: 104 A				

General Notes:

Panel L

NEW

Location: KITCHENETTE 308C
Supply From: MAIN
Mounting: Recessed
Enclosure: Type 1

Voltage: 120/208 Wye
Phases: 3
Wires: 4

A.I.C. Rating: 10,000
Mains Type: MLO
Bus Rating: 150 A

Circuit Notes:

Note	Circ...	Load	Type	Trip	Po...	A	B	C	Po...	Trip	Type	Load	Circ...	Note	
	1	VENT HOOD	G	20 A	1	240 VA	1080 VA		1	20 A	R	R-CLASSROOM 308	2		
	3	DISH WASHER	G	20 A	1		1500 VA	1373 VA	2	20 A	M	CONDENSING UNIT CU-3	4		
	5	WASHER	G	20 A	1			1200 VA	1373 VA	2	20 A	M	CONDENSING UNIT CU-2	6	
	7	MICROWAVE	G	20 A	1	1000 VA	1373 VA		2	20 A	M	CONDENSING UNIT CU-2	8		
	9	MICROWAVE	G	20 A	1		1000 VA	1373 VA	2	20 A	M	CONDENSING UNIT CU-2	10		
	11	DRYER	G	30 A	2		2288 VA	2421 VA	2	35 A	M	CONDENSING UNIT CU-1	12		
	13														
	15	REFRIGERATOR	G	20 A	1	1500 VA	116 VA		2	15 A	M	INDOOR SPLIT UNIT DX-1	14		
	17	R-KITCHENETTE 308C	R	20 A	1		900 VA	116 VA	2	15 A	M	INDOOR SPLIT UNIT DX-3	16		
	19	RANGE	R	50 A	2	4160 VA	50 VA		2	15 A	M	INDOOR SPLIT UNIT DX-3	20		
	21						4160 VA	50 VA					22		
	23	INDOOR SPLIT UNIT	M	15 A	2		50 VA	1176 VA	1	20 A	G	GARBAGE DISPOSAL	24		
	25	DX-2	M	20 A	1	50 VA	864 VA		1	20 A	M	EF-1 RESTROOM 308A	26		
	27	EH-1	M	20 A	1		1000 VA	900 VA	1	20 A	R	R-RM 308A, 308, 308B	28		
	29	ERV-1	M	20 A	1			130 VA	360 VA	1	20 A	R	R-RM 308B, 309	30	
	31	SPACE	--	--	1	720 VA			1	20 A	R	R-STORAGE 309	32		
	33	SPACE	--	--	1		0 VA		1	20 A	--	SPARE	34		
	35	SPACE	--	--	1			0 VA	1	20 A	--	SPARE	36		
	37	SPACE	--	--	1		0 VA		1	20 A	--	SPARE	38		
	39	SPACE	--	--	1			0 VA	1	20 A	--	SPARE	40		
	41	SPACE	--	--	1			0 VA	1	20 A	--	SPARE	42		

Load Type	Connected Load	Demand Factor	Demand Load	Panel Totals
L Lighting	0 VA	0.00%	0 VA	Power Factor: 1
R Receptacle	12280 VA	90.72%	11140 VA	
M Motor	12760 VA	109.49%	13971 VA	
C Continuous	0 VA	0.00%	0 VA	
G General	12192 VA	100.00%	12192 VA	
K Kitchen	0 VA	0.00%	0 VA	
E Existing	0 VA	0.00%	0 VA	
O Other	0 VA	0.00%	0 VA	
Total Load: 14246 VA				
Total Amps: 123 A				
Total Demand Load: 112 A				
Total Demand Current: 83 A				
Phase Balance: 9 % A-B, 34 % B-C, 47 % C-A				

General Notes:

Panel H

EXISTING

Location: Main
Supply From: Recessed
Enclosure: Type 1

Voltage: 120/208 Wye
Phases: 3
Wires: 4

A.I.C. Rating: 10,000
Mains Type: MLO
Bus Rating: 225 A

Circuit Notes:
1. EXISTING LOAD REMOVED. LABEL BREAKER AS SPARE.

Note	Circ...	Load	Type	Trip	Po...	A	B	C	Po...	Trip	Type	Load	Circ...	Note
	1	RESTROOM LIGHTS	--	20 A	1	0 VA	0 VA		1	20 A	--	GIRLS RR OUTLETS	2	
	3	CLASS 306 LIGHTS	--	20 A	1		0 VA	0 VA	1	20 A	--	BOYS RR OUTLETS	4	
	5	CLASS 306 LIGHTS	--	20 A	1			0 VA	1	20 A	--	MULTI PUR OUTLETS	6	
	7	CLASS 310 LIGHTS	--	20 A	1	0 VA	0 VA		1	20 A	--	CLASS C OUTLETS	8	
	9	CLASS 309 LIGHTS	--	20 A	1		0 VA	0 VA	1	20 A	--	CLASS E OUTLETS	10	
	11	OFFICE LIGHTS	--	20 A	1			0 VA	1	20 A	--	MULTI PUR OUTLETS	12	
	13	HALL LIGHTS	--	20 A	1	0 VA	0 VA		1	20 A	--	OFFICE OUTLETS	14	
	15	KITCHEN 308 LIGHTS	--	20 A	1		0 VA	0 VA	1	20 A	--	OFFICE ENTRY OUTLS	16	
	17	RRs LIGHTS	--	20 A	1			0 VA	1	20 A	--	CLASS B OUTLET U.V.	18	
	19	307/306 STOR LIGHTS	--	20 A	1	0 VA	0 VA		1	20 A	--	PHY THERAPY OUTLETS	20	
	21	CLASS 307 LIGHTS	--	20 A	1		0 VA	0 VA	1	20 A	--	CLASS F OUTLETS	22	
	23	SPARE	--	20 A	1			0 VA	1	20 A	--	U.V. CLASS A	24	
	25	SPARE	--	20 A	1	0 VA	0 VA		1	20 A	--	U.V. CLASS C & E	26	
	27	SPARE	--	20 A	1		0 VA	0 VA	1	20 A	--	SPARE	28	1
	29	SPARE	--	20 A	1			0 VA	1	20 A	--	U.V. CLASS D	30	
	31	SPARE	--	20 A	1	0 VA	0 VA		1	20 A	--	SPARE	32	
	33	SPARE	--	30 A	2		0 VA	0 VA	2	50 A	--	SPARE	34	1
	35					0 VA	0 VA		0 VA	0 VA			36	
	37					0 VA	0 VA		0 VA	0 VA			38	
	39	SPARE	--	20 A	3	0 VA	0 VA		3	20 A	--	SPARE	40	
	41					0 VA	0 VA		0 VA	0 VA			42	


Load Type	Connected Load	Demand Factor	Demand Load	Panel Totals
L Lighting	0 VA	0.00%	0 VA	Power Factor: 1
R Receptacle	0 VA	0.00%	0 VA	
M Motor	0 VA	0.00%	0 VA	
C Continuous	0 VA	0.00%	0 VA	
G General	0 VA	0.00%	0 VA	
K Kitchen	0 VA	0.00%	0 VA	
E Existing	0 VA	0.00%	0 VA	
O Other	0 VA	0.00%	0 VA	
Total Connected Load: 0 VA				
Total Connected Current: 0 A				
Total Demand Load: 0 VA				
Total Demand Current: 0 A				

General Notes:

FEEDER SCHEDULE

NOTE:


KEY	CONDUCTORS	C"
150 4G	4 # 10, 1 # 6 G2	

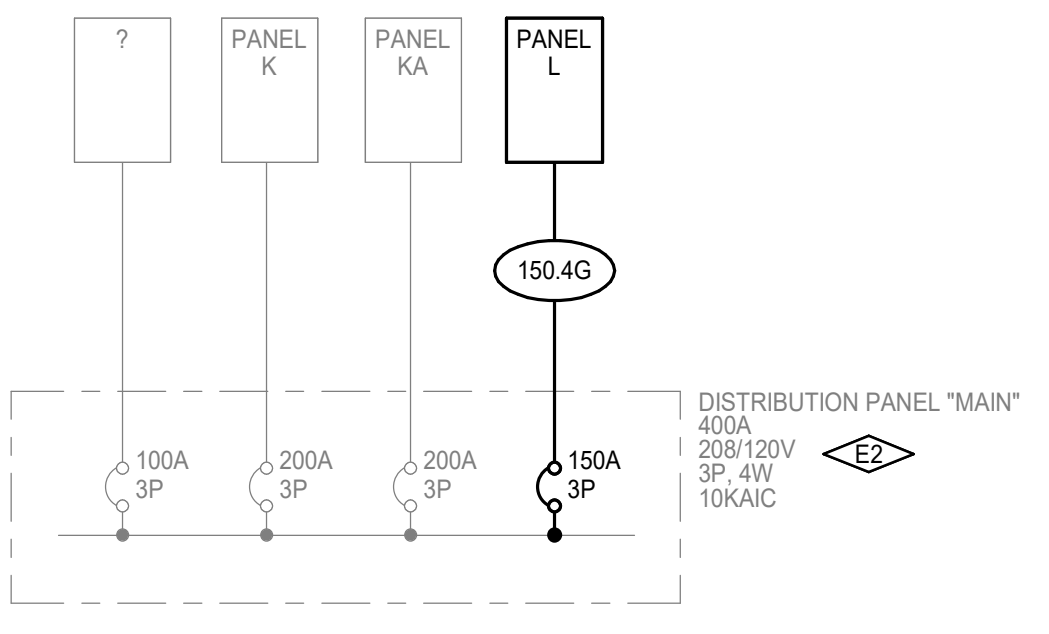

ELECTRICAL ONE-LINE DIAGRAM
SCALE: NONE



OVERALL ELECTRICAL PANEL PLAN
SCALE: 1/16" = 1'-0"

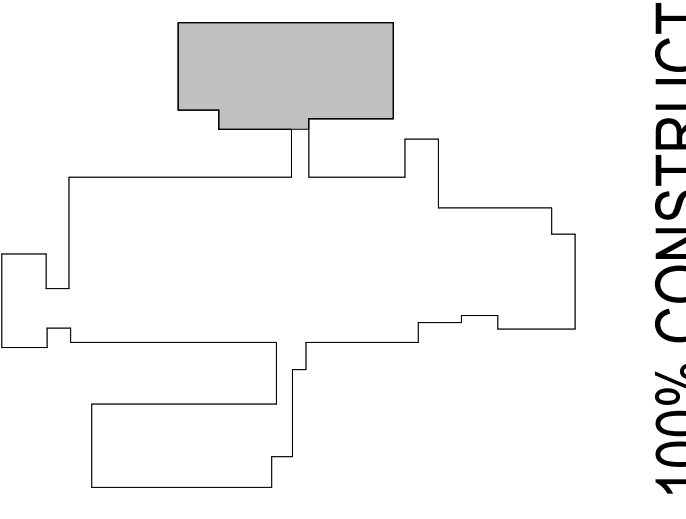

KEY PLAN OVERALL
SCALE: NONE

KEYNOTES

E2 PROVIDE 3-PHASE DIGITAL RECORDING METER AT LOCATION INDICATED FOR A PERIOD OF 30 DAYS PRIOR TO SUBMITTING FOR PERMIT TO VERIFY EXISTING LOAD. METER SHALL RECORD VOLTAGE AMPERAGE, KVA AND POWER FACTOR FOR EACH PHASE AND SUM OF THE PHASES. THE METER SHALL CONTINUALLY AVERAGE THE POWER DEMAND OVER MAXIMUM 15 MINUTE INTERVALS AS REQUIRED BY NEC 220.87. COMPLETE A METERING SUMMARY REPORT AND DELIVER RESULTS TO ENGINEER AFTER 7 DAYS AND AFTER 30 DAYS. VERIFY EXISTING LOADS AT AND DOWNSTREAM OF THE METERING LOCATION AND PROVIDE LIST TO ENGINEER OF WHAT LOADS ARE NOT ON DURING THE 30 DAY METERING AND THE REASON WHY. ORGANIZE LIST BY EQUIPMENT NAME. IF ANY LOADS HAVE BEEN REMOVED OR PERMANENTLY ABANDONED, TURN CIRCUIT BREAKER OFF AND RELABEL AS SPARE.


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Project:
TFSD 2023 CAPITAL IMPROVEMENTS
PACKAGE 6, SUPPORT SERVICE
CLASSROOM TENANT IMPROVEMENT
AT ROBERT STUART MIDDLE SCHOOL
644 Casewell Ave W
Twin Falls, ID 83301

Sheet:
ELECTRICAL PANEL SCHEDULES



Project No: 23010-00
Drawn By: Author
Checked By: Checker
Date: 12/22/2023

Sheet No:
E4.01

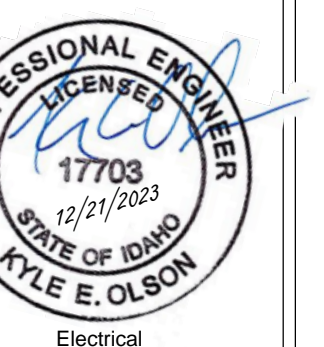100% CONSTRUCTION DOCUMENTS

